RESIDENTIAL REMODEL/ADDITION

NGAI RESIDENCE

ZONING

CONSULTANTS

REVISED

RECEIVED

AUG 30 2022

CITY OF BURLINGAME

CDD-PLANNING DIVISION

OCCUPANCY: CONSTRUCTION TYPE: SPRINKLER:

PROJECT DATA

PROJECT SCOPE

NEW CLOSET IN FRONT BEDROOM AND LINEN CLOSET NEXT TO POWDER ROOM. REMODEL EXISTING

PROJECT SUMMARY TABLE

NET LOT AREA	11,125 SF		TOTAL		
FLOOR AREA	1ST LEVEL	LOWER LEVEL	LIVING	GARAGE	FAR
EXISTING	1,914	1,332	3,246	624	3,870
PROPOSED	748	-	748	-	
TOTAL SF	2,662	1,332	3,994	624	4,618

11,125 SF LOT X .32 FAR = 3,560 + 1,100 = 4,660 SF MAX

LOT COVERAGE 11,125 SF LOT X .40 = 4,450 SF MAX

NON-CITY HOLIDAYS BETWEEN 8AM - 5PM

TANDARDS	REQUIRED (MAX)	PROPOSED
EIGHT	30'-0"	21'-9"
ETBACKS 1ST FLOOR		
RONT	15'-0"	15'-0"
IDE RIGHT	7'-0"	9'-9"
IDE LEFT	7'-0"	9'-9 1/2"
EAR	15'-0"	67'-0"
LAK	13-0	07-0

SUNDAYS AND HOLIDAYS: NO WORK ALLOWED SEE CITY OF BURLINGAME MUNICIPAL CODE, SECTION 18.07.110 FOR DETAILS

SEE CITY OF BURLINGAME MUNICIPAL CODE, SECTION 13.04.100 FOR DETAILS

INDEX TO DRAWINGS

CVR1 COVER SHEET

ROOF PLAN

SECTIONS SECTIONS 1ST FLOOR ELECTRICAL PLAN


GBC2 CAL GREEN

REVISIONS DATE

HERS FEATURE SUMMARY

CONSTRUCTION HOURS

PROJECT LOCATION

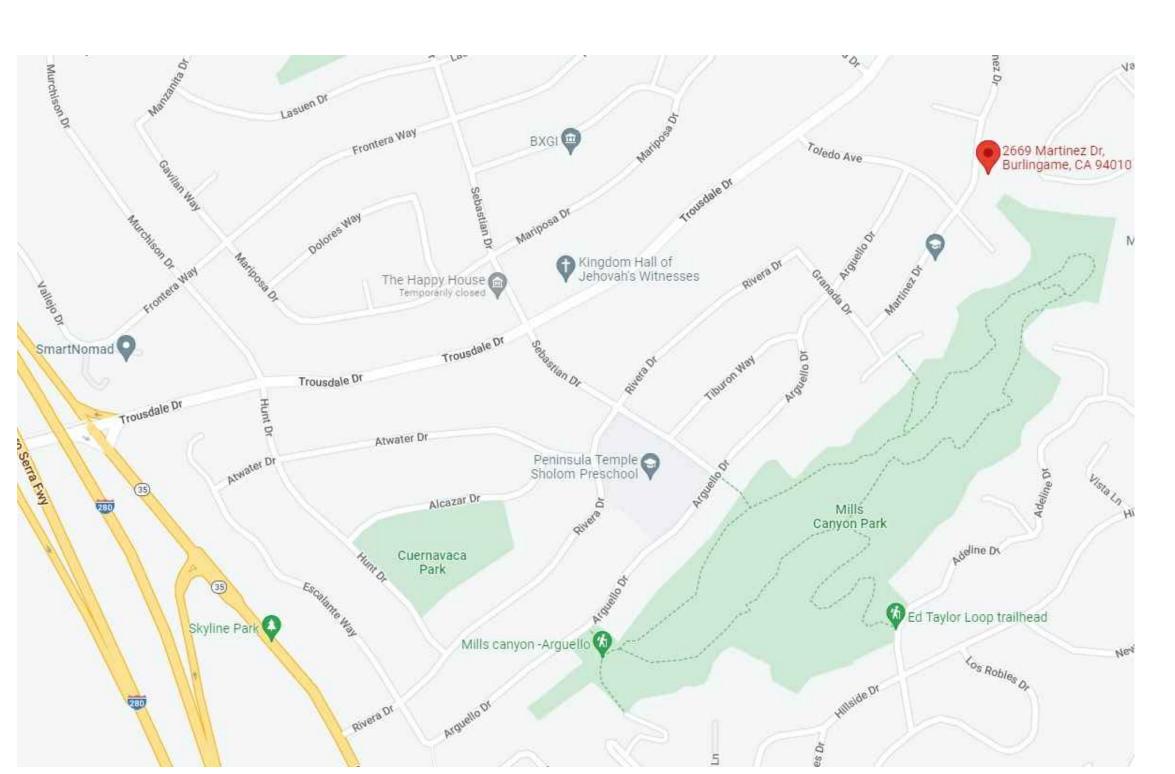

ABBREVIATIONS SYMBOLS F.O.M. FACE OF MASONRY POUNDS PER SQUARE INCH AGGREGATE BASE ASPHALT CONCRETE F.O.S. FACE OF STUD P.T. PRESSURE TREATED A.C. AIR CONDITIONING FTG FOOTING ROOM NAME — ROOM NAME ACC Q.T. QUARRY TILE ----- ROOM NUMBER ACCESSIBLE GALV GALVANIZED ADJUSTABLE — INTERIOR ELEVATIONS GLB GLUE LAMINATED BEAM ROOF DRAIN ABOVE FINISH FLOOR R.D. REINF REINFORCE G.S.M. GALVANIZED SHEET METAL ALTERNATE ALUM ALUMINUM GWB GYPSUM WALLBOARD REQ'D REQUIRED ——— DETAIL NUMBER APPROX APPROXIMATE ROOM SHEET NUMBER H.B. HOSE BIBB ROUGH OPENING A.T. ACOUSTIC TILE HOLLOW CORE REDWOOD HDWR HARDWARE RAIN WATER LEADER BUILDING BLOCKING HDWD HARDWOOD R.H.W.S. ROUND HEAD WOOD SCREW SHEET NUMBER BOTTOM OF H.M. HOLLOW METAL B.O. HORIZ HORIZONTAL SELF-ADHERED FLASHING B.U.R. BUILT UP ROOFING SOLID CORE SECTION NUMBER SIDE DRAINAGE EASEMENT — SHEET NUMBER I.D. SHT INSIDE DIAMETER SHEET CALIFORNIA BUILDING CODE INSUL INSULATION SIM SIMILAR CONSTRUCTION JOINT SHEET METAL SCREW ELEVATION NUMBER SPEC SPECIFICATION CLG — SHEET NUMBER CLR JOINT STAINLESS STEEL CMU CONCRETE MASONRY UNIT CLEAN OUT STANDARD LENGTH S.T.S. SELF-TAPPING SCREW COLUMN LAMINATED COMP COMPOSITION STL STEEL LAV LAVATORY CONT CONTINUOUS STOR STORAGE CONC CONCRETE POUND STRUCT STRUCTURAL COUNTERSUNK LAG SCREW SUSP SUSPENDED SYM SYMMETRICAL LIGHT WINDOW NUMBER MFR MANUFACTURER DETAIL TONGUE & GROOVE DRINKING FOUNTAIN MAXIMUM TELEPHONE WALL TYPE / STUD SIZE MECH MECHANICAL DIAMETER THICK MINIMUM DIM DIMENSION T.O. TOP OF MISCELLANEOUS T.O.C. TOP OF CONCRETE — INDICATES NOMINAL CEILING MULTI-PURPOSE EASEMENT TYP TYPICAL HEIGHT ABOVE F.F.E. ON DOWNSPOUT MASONRY OPENING REFLECTED CEILING PLAN U.O.N. UNLESS OTHERWISE NOTED DISHWASHER UNREINF UNREINFORCED +6'-10" ELEVATION SYMBOL UR URINAL N.I.C. NOT IN CONTRACT NO. NUMBER VCT VINYL COMPOSITION TILE EACH $-4:12 \rightarrow ----$ ROOF PITCH EXPANSION JOINT ELEC VEST. VESTIBULE ELECTRICAL **ELEV** ELEVATION VINYL WALL COVERING - 2435.12 ——— NEW GRADE ELEVATION ON CENTER

WIDTH

WOOD

ANGLE

CENTER LINE

DIAMETER

NUMBER

OVER

ΑT

WSCT WAINSCOT

WT WEIGHT

WATER CLOSET

WATER HEATER

O.D.

EQUIPMENT

FLOOR DRAIN

FINISH GRADE

FIRE HYDRANT

FLUOR FLUORESCENT

F.O.F. FACE OF FINISH

F.H.W.S. FLAT HEAD WOOD SCREW

F.F.E.

FIRE EXTINGUISHER

FIRE EXTINGUISHER CABINET

FINISH FLOOR ELEVATION

OUTSIDE DIAMETER

OWNER INSTALLED

CONTRACTOR INSTALLED

OPPOSITE

O.F.C.I. OWNER FURNISHED,

O.F.O.I. OWNER FURNISHED,

OUNCE

PERF PERFORATED

PLAS PLASTIC

PR PAIR

PLUMB. PLUMBING

PLYWD PLYWOOD

PLATE

PMF PRESSED METAL FRAME

OWNER

415.309.6768

GRACE AND LARRY NGAI

2269 MARTINEZ DRIVE BURLINGAME, CA 94010

LGNGAI@GMAIL.COM

DEFERRED SUBMITTALS

APPLICABLE CODES

2019 CALIFORNIA CODE OF REGULATIONS (CCR) APPLICABLE CODES EFFECTIVE JAN 1, 2019:

TITLE 19 CCR. PUBLIC SAFETY, STATE FIRE MARSHAL REGULATIONS

TITLE 24 CCR, PART 2.5 - 2019 CALIFORNIA RESIDENTIAL CODE (CRC)

TITLE 24 CCR, PART 3 - 2019 CALIFORNIA ELECTRICAL CODE (CEC)

TITLE 24 CCR, PART 4 - 2019 CALIFORNIA MECHANICAL CODE (CMC)

TITLE 24 CCR, PART 8 - 2019 CALIFORNIA HISTORICAL BUILDING CODE

TITLE 24 CCR, PART 12 - 2019 CALIFORNIA REFERENCED STANDARDS

TITLE 24 CCR, PART 5 - 2019 CALIFORNIA PLUMBING CODE (CPC)

TITLE 24 CCR, PART 6 - 2019 CALIFORNIA ENERGY CODE

TITLE 24 CCR. PART 9 - 2019 CALIFORNIA FIRE CODE (CFC)

TITLE 24 CCR, PART 10 - 2019 EXISTING BUILDING CODE

LOCAL MUNICIPAL CODE

(E) GRADE ELEVATION

SIGN NUMBER

——— SIGN TYPE

TITLE 24 CCR, PART 1 - 2019 BUILDING STANDARDS ADMINISTRATIVE CODE

TITLE 24 CCR, PART 2 - 2019 CALIFORNIA BUILDING CODE, VOL. 1 & 2 (CBC)

TITLE 24 CCR, PART 7 - 2019 CALIFORNIA ELEVATOR SAFETY CONSTRUCTION CODE

TITLE 24 CCR, PART 11 - 2019 CALIFORNIA GREEN BUILDING STANDARDS CODE


SPECIAL INSPECTIONS

NORTH


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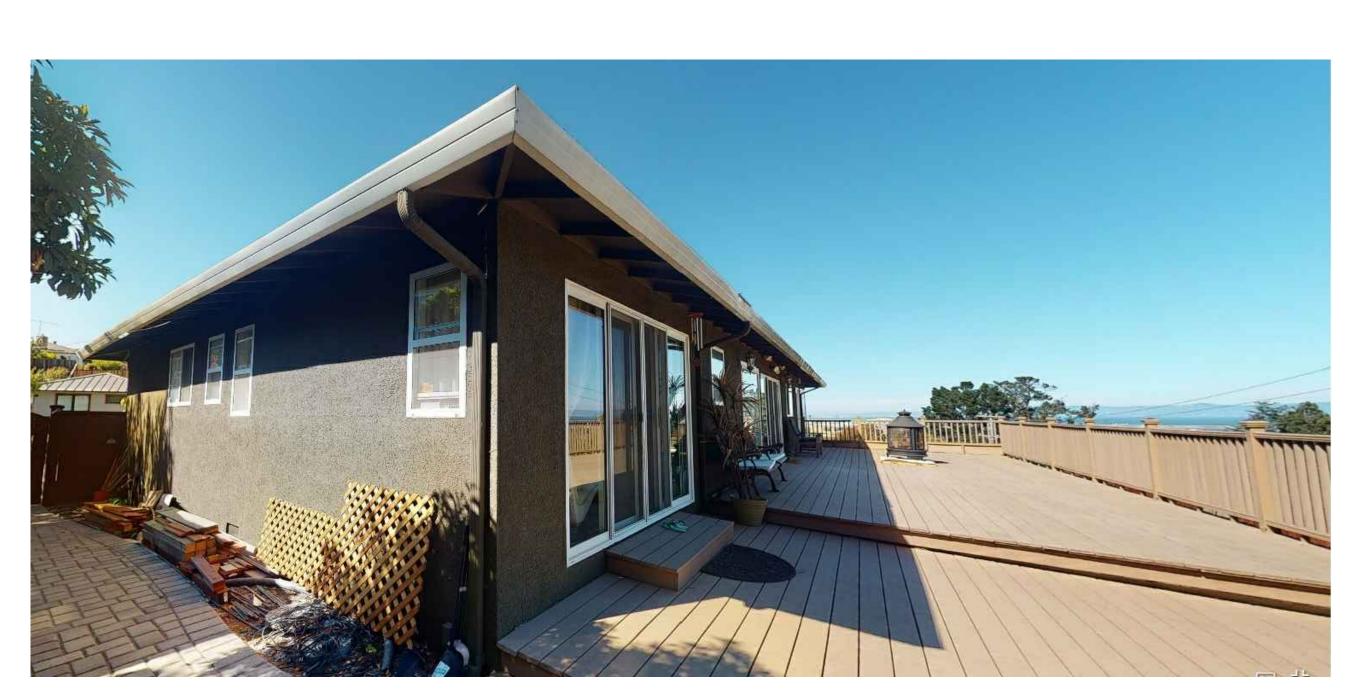
EXISTING FRONT PHOTO



EXISTING LEFT PHOTO

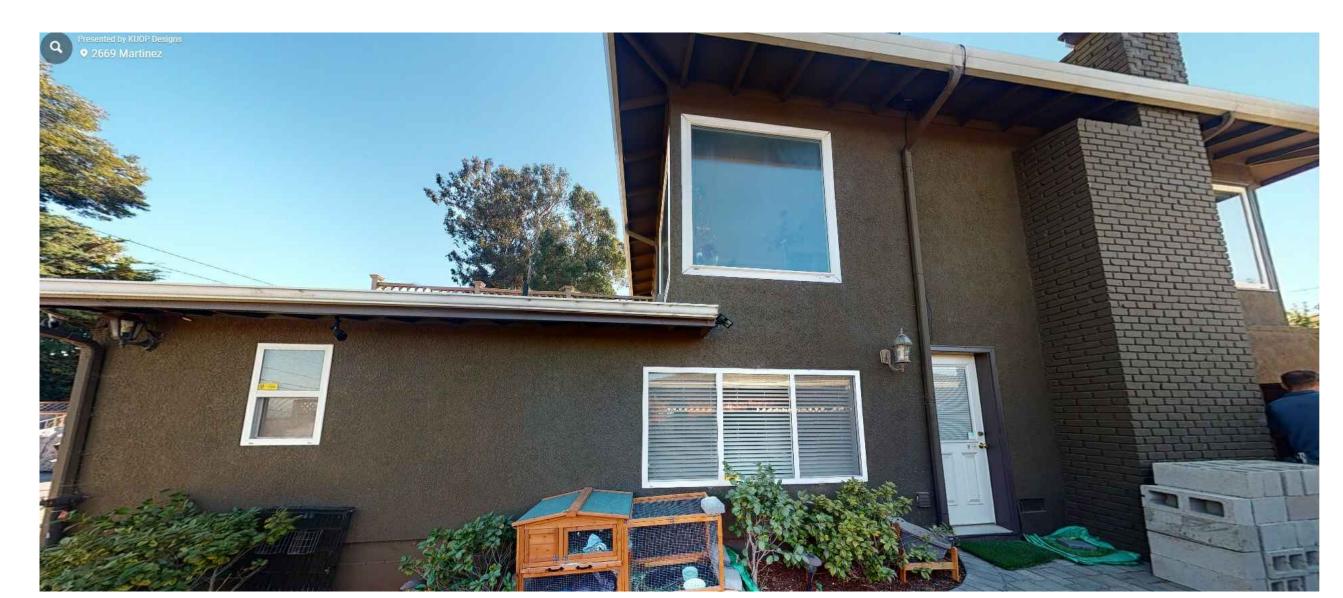

EXISTING REAR PHOTO

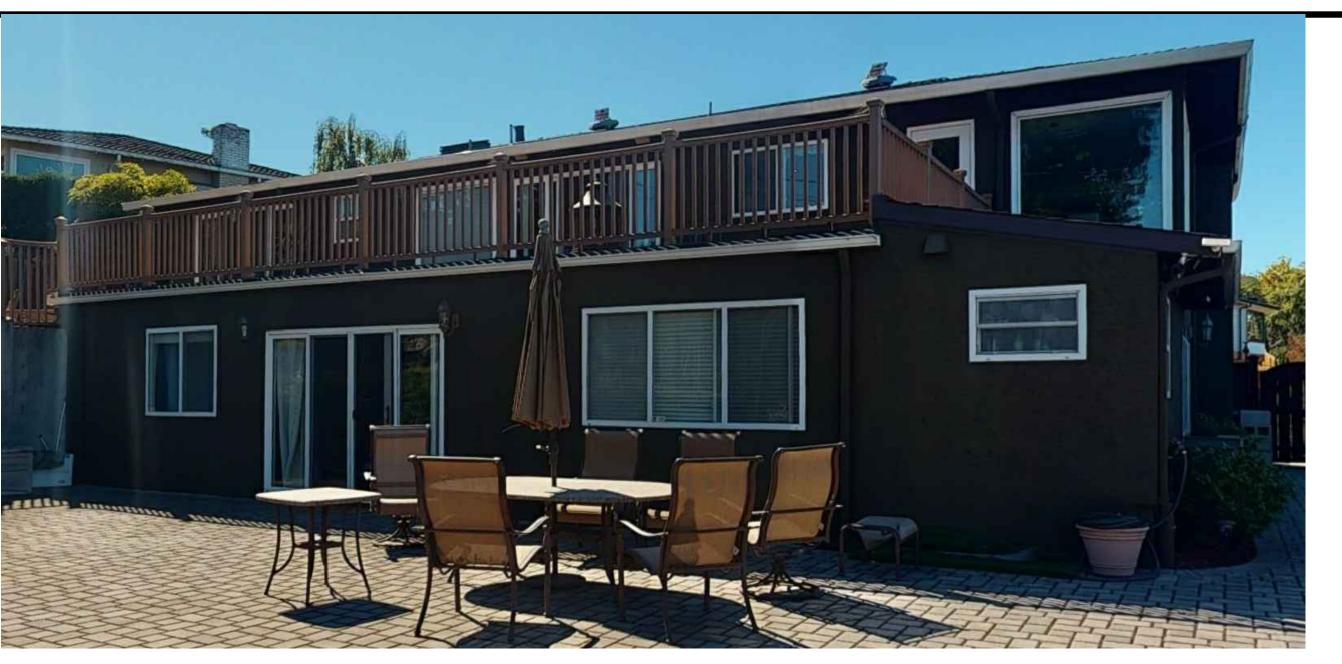

EXISTING RIGHT/REAR PHOTO

REVISIONS	DATE
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CITY OF BURLINGAME City Hall – 501 Primrose Road Burlingame, California 94010-3997



COMMUNITY DEVELOPMENT DEPARTMENT

Planning Division PH: (650) 558-7250 FAX: (650) 696-3790

Story Pole Requirements

When requested by the Planning Commission, story poles are required to help determine the mass and bulk of the proposed structure and assess potential view impacts by the proposed new structure or addition to neighboring properties.

Story Pole Plan:

The applicant must prepare a story pole plan and have it approved by the project planner in advance of installation. The proposed story pole plan must be submitted to the project planner three (3) days in advance of installation to allow for adequate time for review.

The story pole plan should be an 8.5" x 11" copy of the roof plan, located on the site plan. The locations and heights of the proposed poles must be clearly indicated. Ridges and perimeters that will be represented with netting should also be shown on the plan. Any roof areas of an existing structure should be included on the plan for reference. See attached sample story pole plan.

Installation Schedule:

The story poles must be installed and certified at least 10 days prior to the Planning Commission meeting at which the application will be considered. The poles must stay up through the appeal period, which is 10 days after the Planning Commission takes action on the project. The story poles must be removed no later than 10 days after the appeal period ends.

Story poles shall be installed as follows:

- 1. The proposed building/addition shall be staked with poles that reach from the foundation (or the existing structure, where applicable) to the roof at an adequate number of locations to be able to determine the bulk and mass of the structure. It may be necessary to stake more than just the four corners of the building/addition. Additionally, story poles are to be erected at key roof peak/ridge locations (including the highest), to visually demonstrate the different roof heights, and the maximum roof heights.
- 2. All story poles shall represent the final height of the building, with grading accounted for in the height of the poles.

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- 3. All story poles shall be painted with 12" high stripes, alternately black and white, to assist with the visual verification of indicated heights above grade.
- 4. Netting of at least 12"-wide woven plastic fencing shall be assembled to represent the proposed structure. Netting must be supported by stakes or support wires that are strong enough to accurately outline the building mass and height. Please see attached photographs.
- 5. All story poles and netting shall be installed so as to withstand weather until removal, which shall occur no earlier than 10 but no later than 20 days after the Planning Commission takes action on the project (unless the project was continued).

Certification Required:

At least 10 days prior to the Planning Commission meeting, the applicant shall submit certification by a licensed surveyor or civil engineer that the poles have been installed as per the approved story pole plan. The approved plan (showing locations and heights of the poles) shall be attached to the certification letter. The certification shall bear the professional stamp and signature of the licensed professional.

Failure to install and verify the story poles as required will result in a continuance of the hearing to a subsequent Planning Commission meeting.

If you have any questions, call the Planning Division at (650) 558-7250.

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CITY OF BURLINGAME
City Hall – 501 Primrose Road
Burlingame, California 94010-3997




COMMUNITY DEVELOPMENT DEPARTMENT Planning Division

Planning Division
PH: (650) 558-7250
FAX: (650) 696-3790

Date:		
Project Address:		
Assessor's Parcel No.:		
Owner's Name:		
referenced site were installe with the design, height, and plan.	d or inspected by the undersigned, a location shown on the plans, elevation secondary me at	and found to be in conformance ons, and the attached story pole
Signature		
Name (printed or typed)		
Title		Professional License Stamp Here

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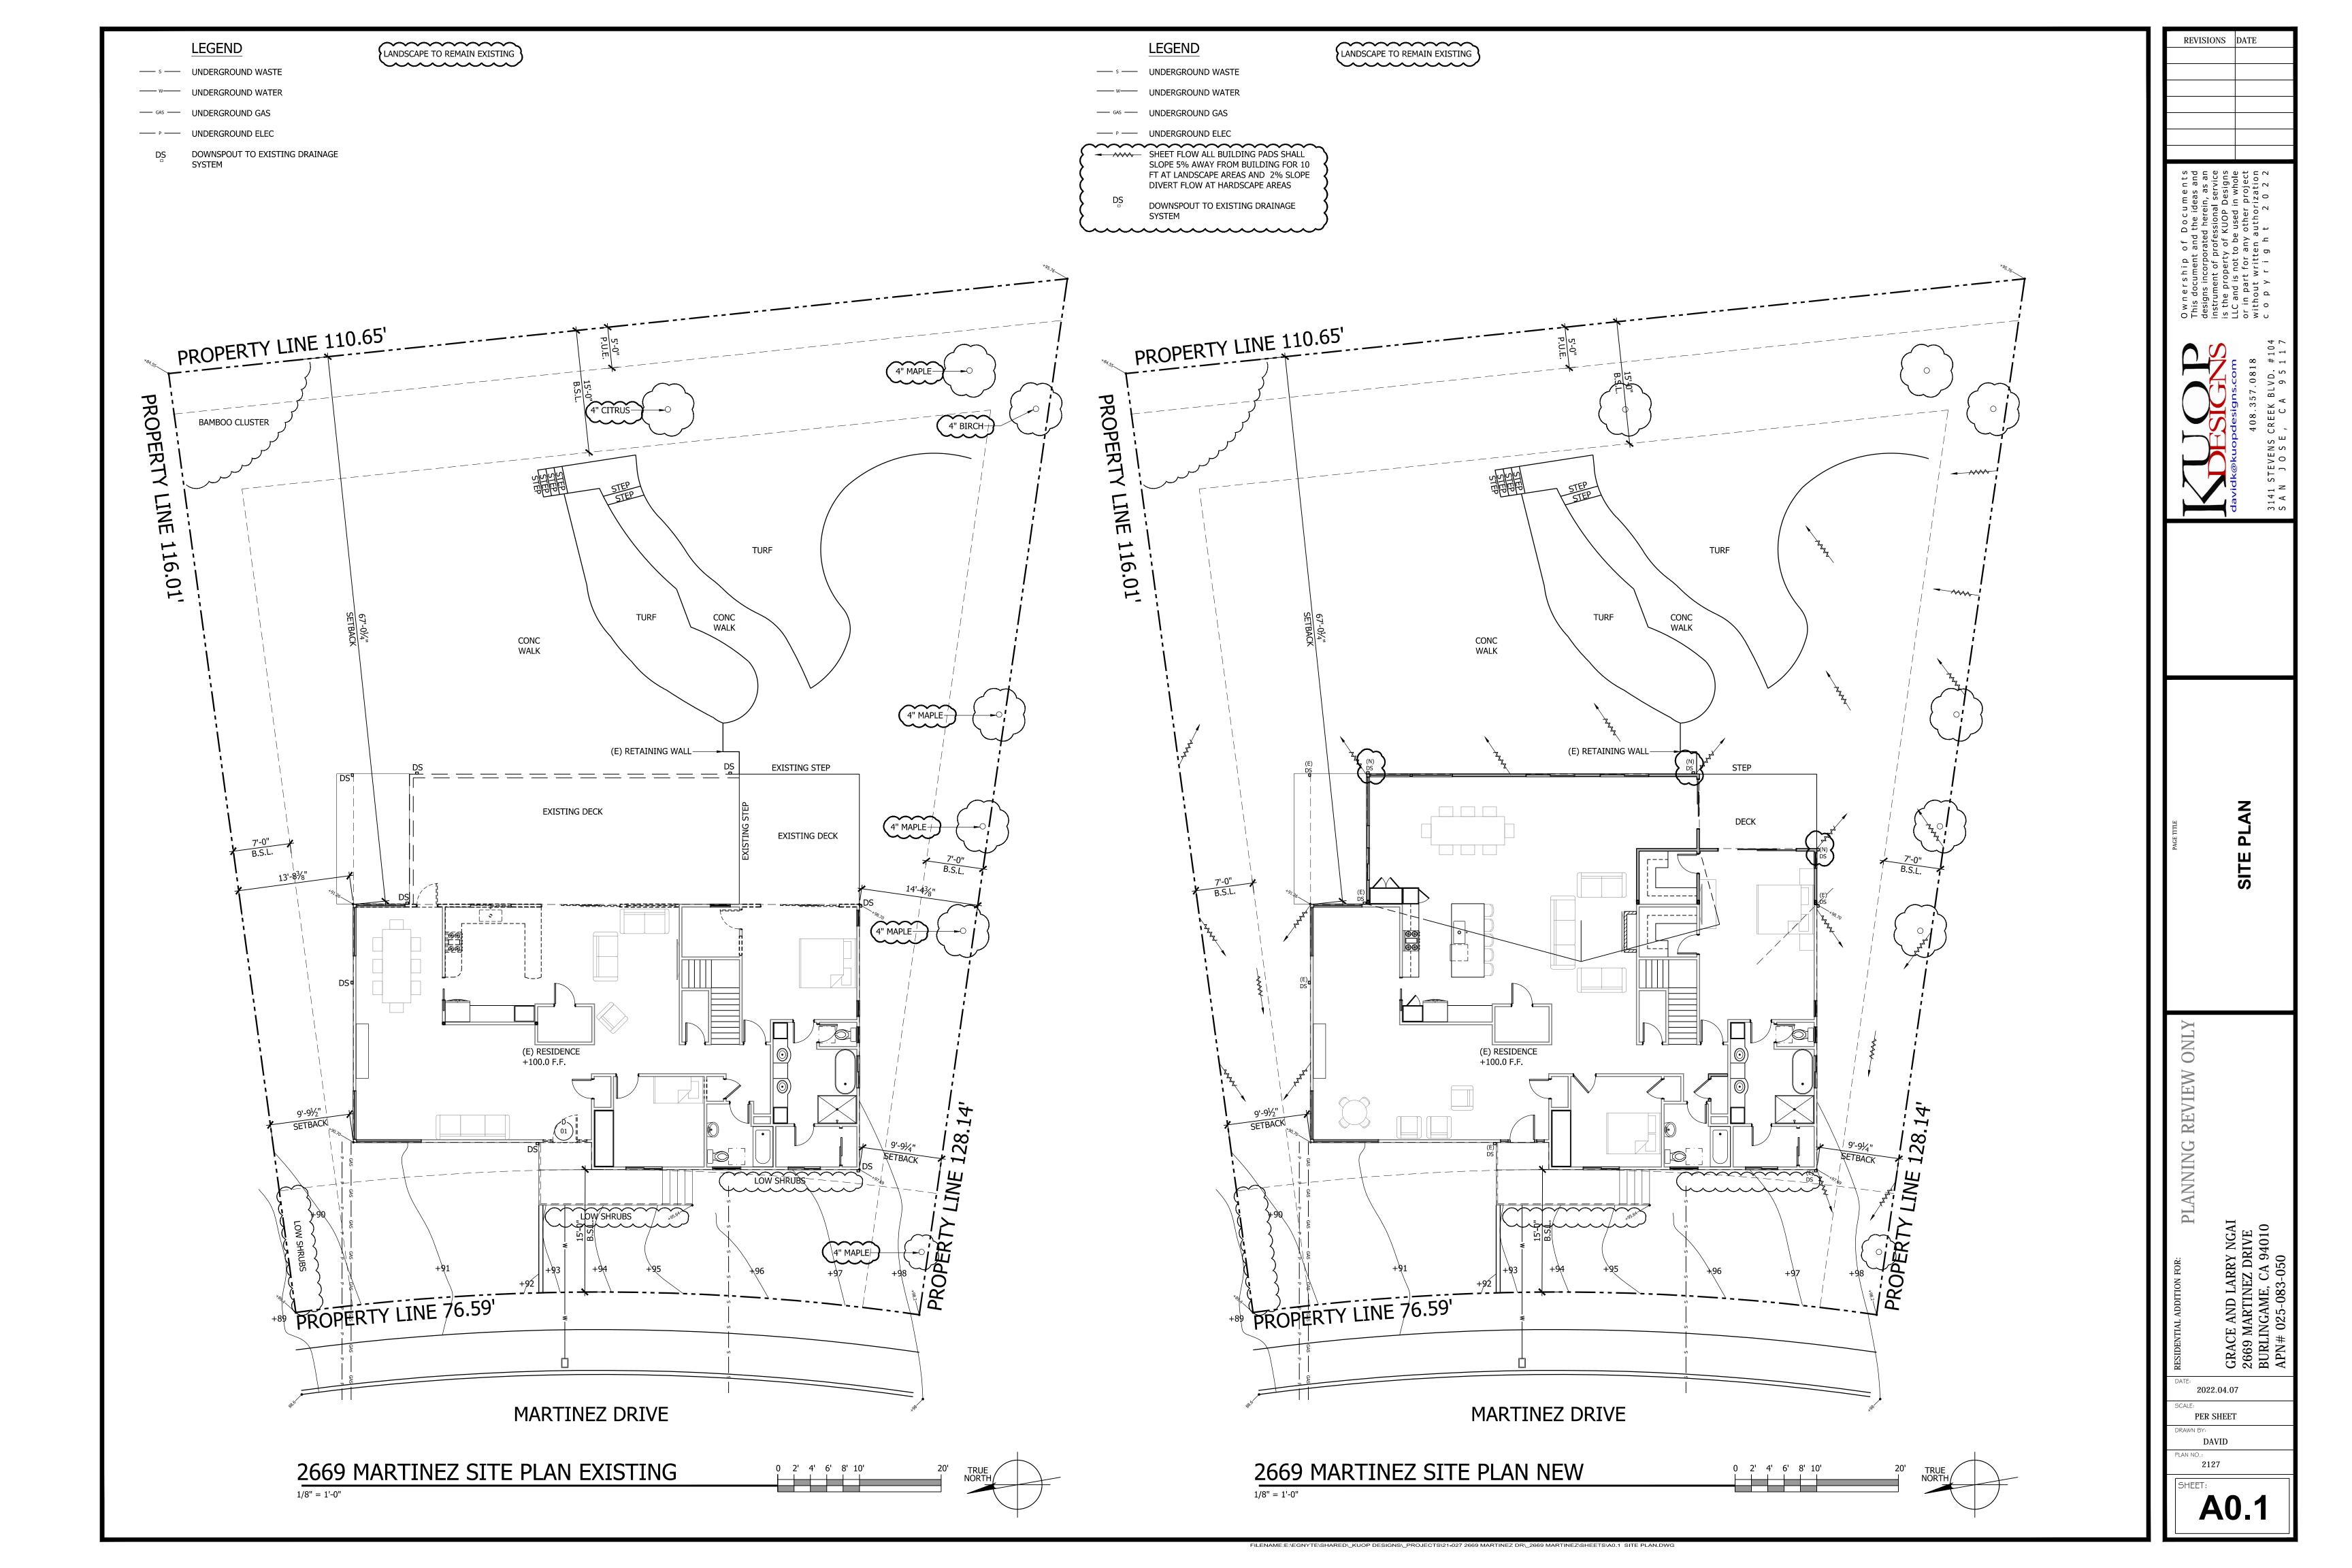
REVISIONS DATE

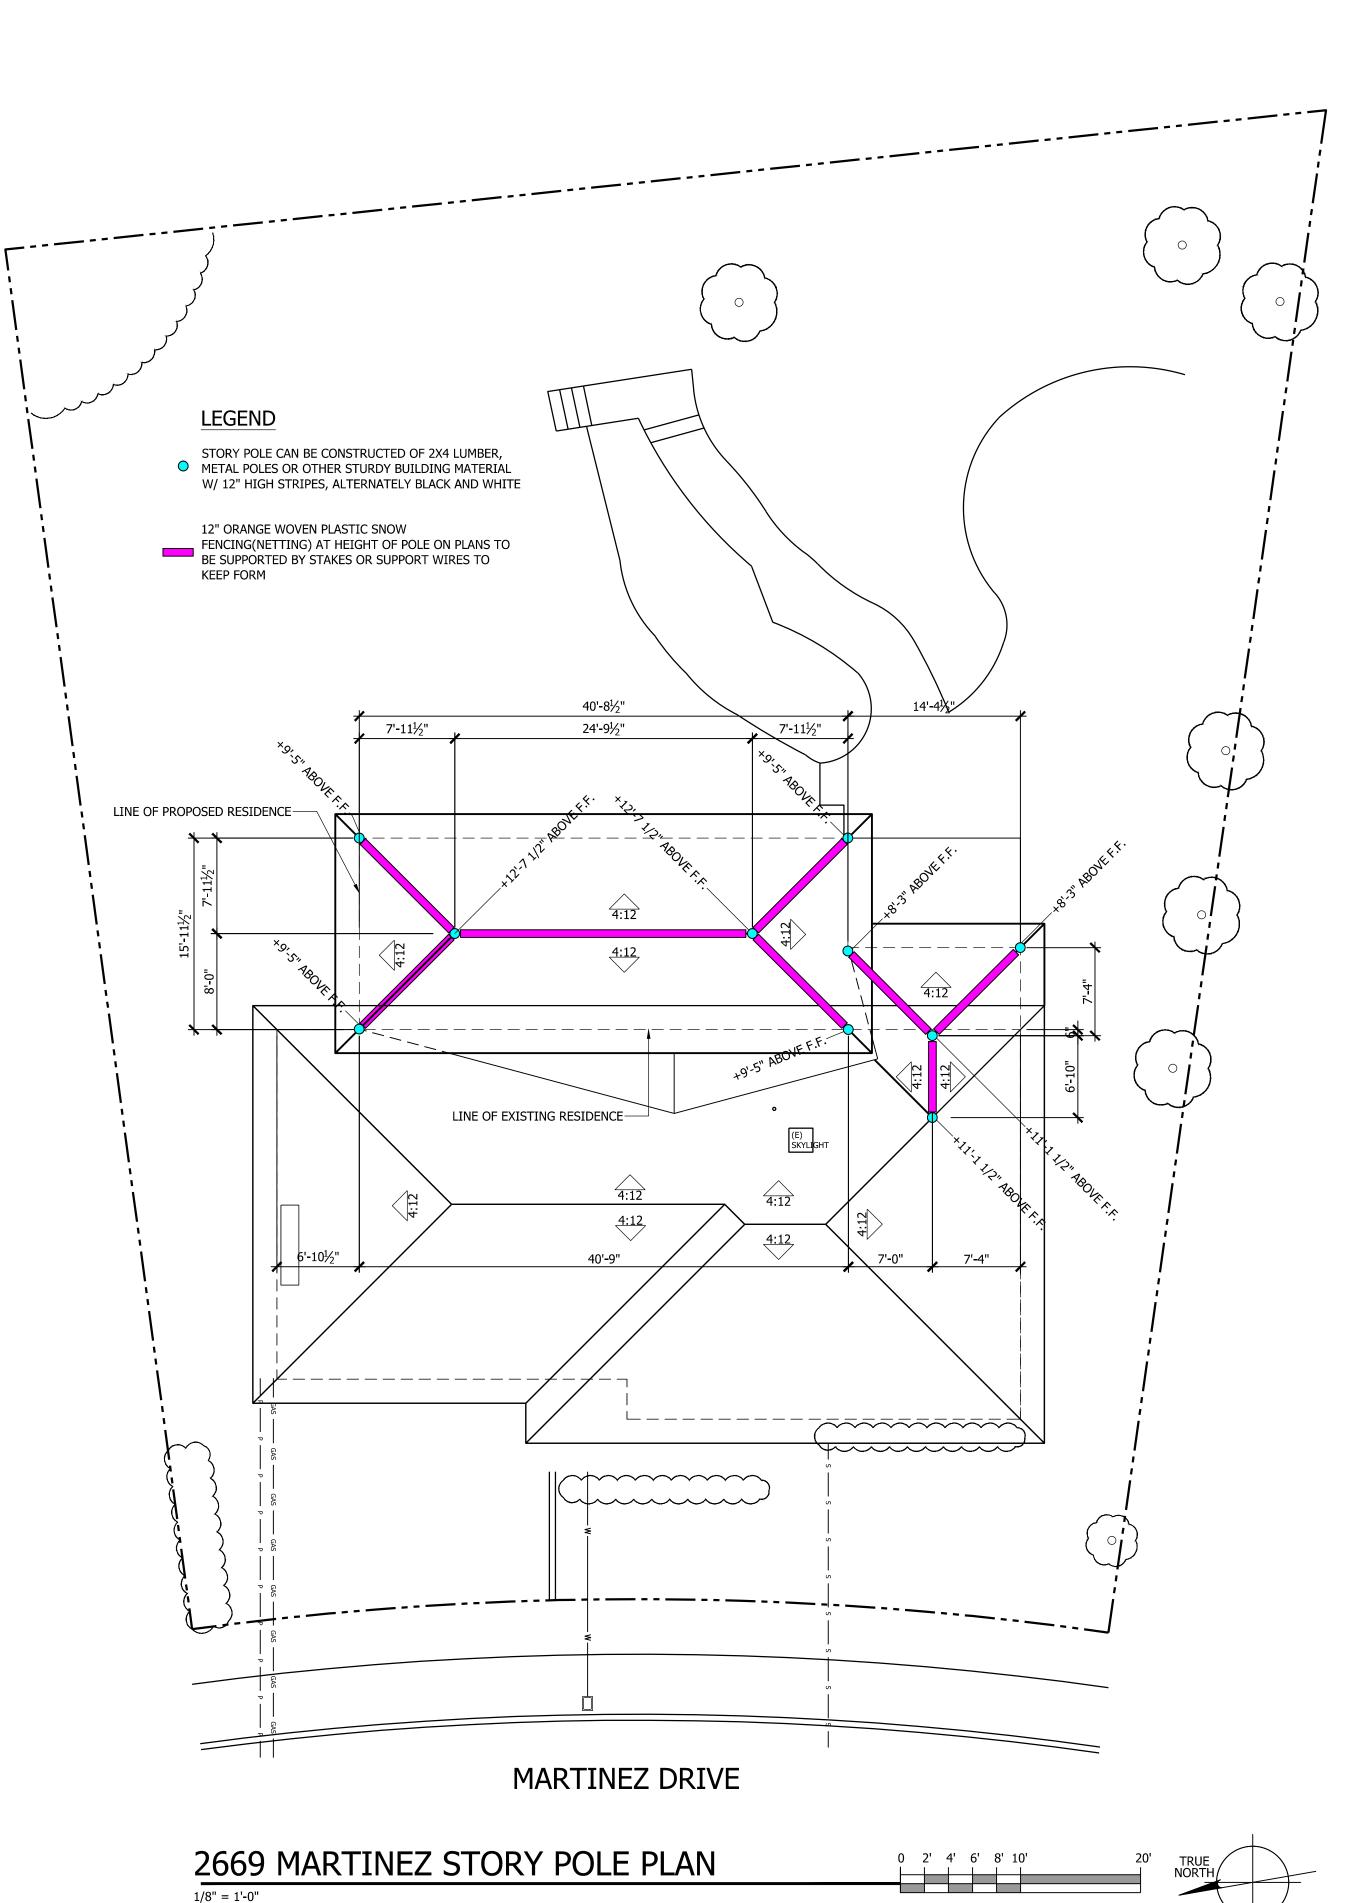2022.04.07

PER SHEET

DAVID

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NON-COMPLIANT PLUMBING FIXTURE REPLACEMENT REQUIREMENTS

1. EFFECTIVE JANUARY 1, 2014 ALL BUILDINGS UNDERGOING PERMIT ALTERATION, ADDITIONS OR IMPROVEMENTS SHALL REPLACE NON-COMPLIANT PLUMBING FIXTURES WITH WATER-CONSERVING PLUMBING FIXTURES LAVATORY FAUCETS EXCEED 2.2 GPM KITCHEN FAUCETS EXCEED 2.2 GPM

EXCEED 1.6 GALLONS/FLUSH WATER CLOSETS SHOWER DEVICES EXCEED 2.5 GALLONS PER MINUTE

IF THE EXISTING PLUMBING FIXTURE WATER USAGE/FLOW RATE IS EQUAL TO OR LOWER THAN THE FIGURE SHOWN ABOVE, IT IS NOT REQUIRED TO BE UPGRADED. IF AN UPGRADE IS REQUIRED, PLEASE FOLLOW WATER CONSERVATION NOTES ABOVE.

WATER CONSERVATION NOTES

1. NEW PLUMBING FIXTURES AND PLUMBING FITTINGS SHALL MEET THE FOLLOWING STANDARDS:

LAVATORY FAUCETS 1.2 GPM MAX @ 60 PSI JULY 1, 2016 KITCHEN FAUCETS 1.8 GPM MAX JANUARY 1, 2016 1.28 GAL/FLUSH MAX JANUARY 1, 2016 WATER CLOSETS *SHOWER DEVICES 1.8 GPM MAX JULY 1, 2018

* "SHOWER DEVICES" INCLUDES SHOWERHEADS, HANDSHOWERS AND BODY SPRAYS/JETS

AIR CONDITIONING UNIT NOTES

- 1. THE INSTALLATION OF THE AIR CONDITIONING UNIT SHALL FOLLOW THE MANUFACTURER'S INSTALLATION INSTRUCTIONS (CRC R106.1.2)
- 2. AN ELECTRICAL DISCONNECT FOR THE UNIT SHALL BE PROVIDED WITHIN SIGHT OF THE UNIT AND READILY ACCESSIBLE. THE MAIN ELECTRICAL PANEL SHALL BE LABELED WITH THE CIRCUIT FOR THE NEW EQUIPMENT (CEC 408.4(A), 440.11 AND
- 3. PROVIDE A 15 OR 20 AMP RECEPTACLE OUTLET AT AN ACCESSIBLE LOCATION WITHIN 25 FEET OF THE CONDENSER UNIT. IF LOCATED OUTSIDE, THE RECEPTACLE SHALL BE GFCI PROTECTED, WATER-RESISTANT AND IN A WEATHERPROOF COVER (CEC 210.63, 210.8 AND 406.9)
- 4. THE CONDENSER UNIT SHALL BE LOCATED AND ANCHORAGE TO A MINIMUM 3 INCH THICK SLAB OR APPROVED PLATFORM (CMC 1105.2)
- 5. THE CONDENSATE DRAINAGE LINE SHALL DRAIN TO A LANDSCAPED AREA OR TO THE TAIL PIECE OF A SANITARY SEWER LINE (CMC 310.1, 310.5, 310.6, 1105.7)
- 6. THE REFRIGERANT PORT PROTECTION CIRCUIT ACCESS LOCATED OUTDOOR SHALL BE PROTECTED FROM UNAUTHORIZED ACCESS WITH A LOCK-TYPE TAMPER RESISTANT CAP (CMC 1105.11)
- 7. CONDENSING UNITS FOR A SINGLE-PACKAGE AIR CONDITIONER UP TO 45,000 Btu/h SHALL HAVE A MINIMUM SEASONAL ENERGY EFFICIENCY RATING OF 14 (SEER) AND AN ENERGY EFFICIENT RATIO OF 12.2 (EER) (2019 BUILDING ENERGY EFFICIENCY STANDARDS)
- 8. INSULATION ON THE SUCTION LINE (COOLING REFRIGERANT LINE) SHALL BE PROTECTED FROM PHYSICAL DAMAGE OR ULTRAVIOLET DETERIORATION BY AN ALUMINUM OR METAL SHROUD, PAINT, PLASTIC COVER, OR ULTRAVIOLET RESISTANT TAPE (CENERC 150.0(m)9).
- 9. CLEARANCE TO A CLOTHES DRYER VENT WHEN LOCATED OUTDOORS, THE CONDENSING UNIT SHALL BE A MINIMUM OF FIVE FEET CLEARANCE FROM THE TERMINATION OF A CLOTHES DRYER VENT (CENERC 150.0(h)3(A)).

ENERGY COMPLIANCE NOTES

- 1. ALL RESIDENCES SHALL MEET THE REQUIREMENTS OF ANSI/ASHRAE STANDARD 62.2-2007.
- 2. ENERGY STAR COMPLIANT QUIET (1.0 SONE MAX.) CEILING MOUNTED BATH FAN OR REMOTE-MOUNTED INLINE FAN MEETING THE REQUIRED VENTILATION RATE IS
- 3. MANDATORY MIN. VENTILATION RATE FOR BATHROOMS = 50 CFM.
- 4. MANDATORY MIN. VENTILATION RATE FOR KITCHEN HOODS = 100 CFM.
- 5. UNLESS FUNCTIONING AS A WHOLE HOUSE VENTILATION SYSTEM, BATHROOM FANS MUST BE CONTROLLED BY A HUMIDISTAT WHICH SHALL BE READILY ACCESSIBLE. HUMIDISTAT CONTROLS SHALL BE CAPABLE OF ADJUSTMENT BETWEEN A RELATIVE HUMIDITY RANGE OF 50 TO 80 PERCENT.

FIRE SEPARATION NOTES

- 1. GARAGE DOOR: DOOR TO LIVING AREA MUST BE 1-3/8" SOLID CORE OR EQUAL. DOORS WILL BE SELF-CLOSING, WEATHER STRIPPED AND HAVE A SELF LATCHING
- 2. DUCTS IN GARAGES: NO NON-APPROVED, NON-METALLIC PENETRATIONS ARE ALLOWED. AIR DUCTS IN GARAGE THAT PASS THROUGH SEPARATION WALL - TO BE MIN. NO. 26 GAGE STEEL,
- 3. FIRE CAULKING: SHALL BE INSTALLED WITH APPROVED FIRE CAULKING
- 4. ALL FIRE BLOCKING SHALL BE PROVIDED TO CUT OFF ALL CONCEALED DRAFT OPENINGS (BOTH VERTICAL AND HORIZONTAL) AND TO FORM AN EFFECTIVE FIRE BARRIER BETWEEN STORIES AND BETWEEN A TOP STORY AND THE ROOF SPACE PER R302.11 AND SHALL BE PROVIDED IN WOOD-FRAME CONSTRUCTION IN THE **FOLLOWING LOCATIONS:**
- 4.1. IN CONCEALED SPACES OF STUD WALLS AND PARTITIONS, INCLUDING FURRED SPACES AND PARALLEL ROWS OF STUDS OR STAGGERED STUDS AS FOLLOWS: VERTICALLY AT THE CEILING AND FLOOR LEVELS HORIZONTALLY AT INTERVALS NOT EXCEEDING 10 FEET
- 4.2. AT ALL INTERCONNECTIONS BETWEEN CONCEALED VERTICAL AND HORIZONTAL SPACES SUCH AS OCCUR AT SOFFITS, DROP CEILINGS AND COVE CEILINGS IN CONCEALED SPACES BETWEEN STAIR STRINGERS AT THE TOP AND BOTTOM
- OF THE RUN. ENCLOSED SPACES UNDER STAIRS SHALL COMPLY WITH SECTION 4.4. AT OPENINGS AROUND VENTS, PIPES, DUCTS, CABLES AND WIRES AT CEILING AND FLOOR LEVEL, WITH AN APPROVED MATERIAL TO RESIST THE FREE PASSAGE OF FLAME AND PRODUCTS OF COMBUSTION. THE MATERIAL FILLING

THIS ANNULAR SPACE SHALL NOT BE REQUIRED TO MEET THE ASTM E 136

- REQUIREMENTS. 4.5. FOR THE FIRE BLOCKING OF CHIMNEYS AND FIREPLACES, SEE SECTION
- R1003.19. 5. GARAGE BENEATH HABITABLE ROOM(s): COVER GARAGE WALLS AND CEILING WITH (1) 5/8" TYPE 'X' DRYWALL, SUPPORT WALLS, BEAMS & POSTS FOR SECOND FLOOR ARE 1-HR PROTECTED OR HEAVY TIMBER I.E. 8X8 POSTS & 6X10 BEAMS AND
- 6. STAIR STRINGERS: ALL ENCLOSED SPACES UNDER STAIRS SHALL HAVE A MINIMUM 1/2" DRYWALL PER R302.7

TABLE 501.1 2019 CPC FIRST HOUR RATING WATER HEATER SIZING

1 11/	<i>)</i>		1 1 1 1 1 1	/ I TI,	V V	v /	_ 1 🗸 1				.I V O
NUMBER OF BATHROOMS		1 TC	1.5		2 TC	2.5			3 TC	3.5	
NUMBER OF BEDROOMS	1	2	3	2	3	4	5	3	4	5	6
FIRST HOUR RATING, GAL	42	54	54	54	67	67	80	67	80	80	80

FOR SI UNITS: 1 GALLON = 3.785 L

- 1. THE FIRST HOUR RATING IS FOUND ON THE "ENERGY GUIDE" LABEL.
- 2. SOLAR WATER HEATERS SHALL BE SIZED TO MEET THE APPROPRIATE FIRST HOUR RATING AS SHOWN IN THE TABLE

GENERAL NOTES

- CONTRACTOR SHALL VERIFY SITE CONDITIONS AND ALL DIMENSIONS PRIOR TO STARTING WORK, ORDERING MATERIAL, OR BUILDING. NOTIFY OWNER OF ANY DISCREPANCIES.
- 2. BUILDING INSULATION VALUES: EXTERIOR WALLS ROOF R-30 BATT **FLOOR** R-19 BATT
- THE CONTRACTORS SHALL FULLY COORDINATE WITH STRUCTURAL, MECHANICAL, ELECTRICAL AND ARCHITECTURAL COMPONENTS OF THE BUILDING.
- 4. ALL DOORS AND WINDOWS SHALL BE WEATHER-STRIPPED. ALL JOINTS AND PENETRATIONS SHALL BE CAULKED AND SEALED.
- ALL EGRESS WINDOWS TO HAVE MAX BOTTOM RAIL HEIGHT OF 44 INCHES. MIN CLEAR WIDTH SHALL BE 20 INCHES. MIN CLEAR HEIGHT SHALL BE 24 INCHES. MIN OPENABLE AREA SHALL BE 5.7 SQ FT.
- 6. SAFETY GLAZING IS REQUIRED IN FIXED OR OPERABLE PANELS ADJACENT TO A DOOR WHERE THE NEAREST EXPOSED EDGE OF THE GLAZING IS WITHIN A 24" ARC OF EITHER VERTICAL EDGE OF THE DOOR IN A CLOSED POSITION AND WHERE THE BOTTOM EXPOSED EDGE OF THE GLAZING IS LESS THAN 60 INCHES ABOVE THE WALKING SURFACE.
- ALL EXTERIOR WALLS SHALL 2x DF FRAMING @ 16" O.C. & FINISHED WITH STUCCO SYSTEM (3 COAT, \(\frac{7}{8} \)" STUCCO SYSTEM OVER APPROVED LATH AND 2 LAYERS OF CLASS 'D' BUILDING PAPER), OR HARDIE SIDING PANELS OVER (1) LAYER OF No. 15 ASPHALT FELT. ALL INTERIOR WALLS SHALL BE 2x DF FRAMING @ 16" O.C. & FINISHED WITH 1/2" GYPSUM BOARD, CEILINGS SHALL BE FINISHED WITH 5" GYPSUM BOARD.
- 8. PROVIDE WINDOWS WITH LOW E COATING & DUAL GLAZING. OBSERVE URBAN-WILDLAND INTERFACE REQ's.
- 9. ALL BUILDING PADS SHALL SLOPE 5% AWAY FROM BUILDING FOR 10'. CRC SEC
- 10. AN OPERATION AND MAINTENANCE MANUAL SHALL BE PROVIDED TO THE BUILDING OCCUPANT OR OWNER PER CGBC 4.410.1
- 11. POLLUTANT CONTROL AND EMISSIONS SHALL CONFORM TO CGBC SECTION 4.504
- 12. MOISTURE CONTENT OF BUILDING MATERIALS USED IN WALL AND FLOOR SHALL BE CHECKED BEFORE ENCLOSURE, CGBC 4.505.3
- 13. GUARDRAILS SHALL NOT HAVE OPENINGS FROM THE WALKING SURFACE TO THE REQUIRED GUARDRAIL HEIGHT WHICH ALLOW THE PASSAGE OF A SPHERE 4" IN DIAMETER (48 AT STAIR RAILS & 6 AT STAIR TREADS.
- 14. ATTIC ACCESS SHALL BE WEATHER STRIPPED TO PREVENT AIR LEAKAGE AND SHALL HAVE PERMANENTLY ATTACHED INSULATION USING ADHESIVE OR MECHANICAL
- 15. EXTERIOR DOORS SHALL HAVE AN EXTERIOR LANDING A MAXIMUM OF 73/4" BELOW THRESHOLD IF DOOR SWINGS IN OR SLIDING DOOR AND A MAXIMUM OF $1\frac{1}{2}$ " IF DOOR SWINGS OUT
- BUILDINGS SHALL BE PROVIDED WITH APPROVED ADDRESS IDENTIFICATION THAT IS LEGIBLE AND VISIBLE FROM THE STREET OR ROAD FRONTING THE PROPERTY. NUMBERS SHALL BE MIN 4" AND CONTRAST WITH THEIR BACKGROUND PER R319.1
- 17. ENCLOSED ACCESSIBLE SPACE UNDER STAIRS SHALL HAVE WALLS, UNDER-STAIR SURFACE AND ANY SOFFITS PROTECTED ON THE ENCLOSED SIDE WITH 1/2" GYPSUM BOARD, R302.7

MECHANICAL NOTES

- 1. THE CLOTHES DRYER EXHAUST DUCT IS LIMITED 14' TOTAL LENGTH, INCLUDING ELBOWS, FROM THE CLOTHES DRYER TO THE POINT OF TERMINATION. REDUCE THIS LENGTH BY 2' FOR EVERY ELBOW IN EXCESS OF 2.
- 2. CLOTHES DRYER EXHAUST SHALL BE A MINIMUM 4 INCHES, TERMINATE TO THE OUTSIDE OF THE BUILDING, SHALL BE EQUIPPED WITH A BACK-DRAFT DAMPER AND MEET THE REOUIREMENTS OF CMC 504.3. PROVIDE 100 SO INCH MINIMUM MAKE-UP AIR OPENING FOR DOMESTIC DRYERS
- HVAC SYSTEM INSTALLERS MUST BE TRAINED AND CERTIFIED AND SPECIAL INSPECTORS EMPLOYED BY THE ENFORCING AGENCY MUST BE QUALIFIED.
- EVERY DWELLING UNIT SHALL BE PROVIDED WITH HEATING FACILITIES CAPABLE OF MAINTAINING A MINIMUM ROOM TEMPERATURE OF 68°F AT A POINT 3 FT ABOVE THE FLOOR AND 2 FEET FROM EXTERIOR WALLS.
- 5. EVAPORATIVE COOLER SHALL BE ISOLATED FROM THE GROUND BY A LEVEL CONCRETE SLAB EXTENDING NOT LESS THAN 3 INCHES ABOVE THE ADJOINING GROUND LEVEL (CMC 935.4.2)
- 6. GAS VENT TERMINATIONS SHALL MEET THE REQUIREMENTS OF CMC 802.6
- 7. COMBUSTION AIR SHALL MEET THE REQUIREMENTS OF CMC CHAPTER 7
- ENVIRONMENTAL AIR DUCTS SHALL TERMINATE 3 FEET FROM THE PROPERTY LINE AND 3 FEET FROM OPENINGS INTO THE BUILDING PER CMC 504.5 AND PROVIDE WITH BACK-DRAFT DAMPERS PER CMC 504.1
- 9. DOMESTIC RANGE HOOD VENTS SHALL MEET THE REQUIREMENTS OF CMC 504.2 AND COMPLY WITH CMC TABLE 403.7
- 10. DIRECT VENT APPLIANCES PER CMC 802.2.1 (PER MANUFACTURER'S INSTALLATION INSTRUCTIONS)
- 11. 26 GAUGE DUCT IN GARAGE
- 12. SUITABLE COVER SHALL BE INSTALLED OVER EXTERIOR INSULATED PIPES (AC SUCTION, WATER LINES, ETC) EX PAINTED CANVAS, PLASTIC COVER, SHEET METAL, ETC.) CA ENERGY CODE 150.0(J)3
- 13. ALL NEWLY INSTALLED GAS FIREPLACES SHALL BE DIRECT VENT AND SEALED-COMBUSTION TYPE. CMC 912.2
- FILTERS OR BETTER CEC 150.0(M)12B 15. PROVIDE WHOLE HOUSE MECHANICAL VENTILATION, PER CEC 150 (O) AND ASHRAE

14. VENTILATION HEATING AND AIR CONDITIONING SYSTEMS SHALL HAVE MERV 13

- 62.2. 4,368 SF/100 + (4BED +1) X 7.5 =81.18 CFM WHOLE HOUSE FAN 16. PROVIDE AN ADDITIONAL WATERTIGHT PAN OF CORROSION-RESISTANT MATERIAL WITH A SEPARATE DRAIN LINE, UNDERNEATH CONDENSATE-PRODUCING UNITS TO CATCH THE OVERFLOW CONDENSATE DUE TO A CLOGGED PRIMARY CONDENSATE
- DRAIN IN THE SPACE. NOTE THAT THE SECONDARY DRAIN LINE MUST BE LOCATED WHERE IT CAN BE READILY OBSERVED. CMC 310.2(2) AND CPC 814.2

PLUMBING NOTES

- 1. SHOWER AND/OR TUB-SHOWER COMBINATIONS ARE TO BE PROVIDED WITH INDIVIDUAL CONTROL VALVES OF THE PRESSURE BALANCE OR THE THERMOSTATIC MIXING VALVE TYPE. THE WATER TEMPERATURE MAXIMUM IS A SETTING OR 120 F. SHOWER WALLS SHALL BE FINISHED WITH A HARD, NON-ABSORBENT SURFACE TO A HEIGHT NOT LESS THAN 72" ABOVE THE DRAIN INLET.
- WATER HEATER TO HAVE SEISMIC BRACING AS PER MANUFACTURERS INSTRUCTIONS OR STATE ARCHITECT OFFICE GUIDELINES. ALL STORAGE TYPE WATER HEATERS NEED A TEMPERATURE/PRESSURE RELIEF VALVE WITHIN A 3/4" HARD PIPE DRAIN WHICH TERMINATES 6" TO 24" ABOVE GRADE AND POINTING DOWNWARD. THE DRAIN PIPE SHALL MAINTAIN A DOWNWARD SLOPE TO THE EXTERIOR. WATER HEATER PAN SHALL BE INSTALLED WITH A 3/4" DRAIN. FIRST 5 HOT AND COLD SHALL BE INSULATED. AND A CATEGORY III OR IV VENT, OR B VENT WITH STRAIGHT PIPE BETWEEN THE OUTSIDE TERMINATION AND THE SPACE WHERE THE WATER HEATER IS INSTALLED AND A CONDENSATE DRAIN THAT IS NO MORE THAN 2 INCHES HIGHER THAN THE BASE OF THE INSTALLED WATER HEATER AND ALLOWS NATURAL DRAINING WITHOUT PUMP.
- 3. FIXTURES ABOVE SHOWERS AND BATHTUB AREAS SHALL BE RATED MOISTURE
- 4. 2X6 WALL REQUIRED WHEN PIPING OUTER DIAMETER IS GREATER THAN 2" PER CRC 602.69.1
- PROVIDE A MINIMUM 3" SEDIMENT TRAP FOR THE GAS LINE TO THE WATER HEATER AND OR THE FURNACE LOCATED ON THE APPLIANCE SIDE OF THE SHUTOFF FOR THE GAS TO EACH APPLIANCE (CPC 1210.8)
- 6. PROVIDE 1" INSULATION ON FIRST 5 FT. OF HOT AND COLD WATER PIPES AT THE WATER HEATER, ALL PIPING WITH NOMINAL 3/4" Ø OR LARGER, ALL HOT WATER PIPES FROM THE HEATING SOURCE TO THE KITCHEN (CEC 150 (j)
- 7. ANTI-SIPHON DEVICES ARE REQUIRED AT ALL HOSE BIBBS. MIN ONE BACK AND ONE FRONT OF STRUCTURE. THIS IS TO PREVENT THE POSSIBLE BACKFLOW OF CONTAMINATED WATER INTO THE POTABLE WATER SYSTEM.
- 8. ISOLATION WATER VALVES REQUIRED FOR INSTANTANEOUS WATER HEATERS 6.8kBTU/HR & ABOVE. VALVES SHALL BE INSTALLED ON BOTH COLD AND HOT WATER LINES. CA ENERGY CODE 110.3(c)7
- 9. SUITABLE COVER SHALL BE INSTALLED OVER EXTERIOR INSULATED PIPES (AC SUCTION, WATER LINES, ETC) EX PAINTED CANVAS, PLASTIC COVER, SHEET METAL, ETC.) CA ENERGY CODE 150.0(j)3
- 10. WATER, SOIL AND WASTE PIPES IN ATTICS AND CRAWL SPACES SHALL BE PROVIDED WITH FREEZE PROTECTION, CPC 312.6
- 11. ABS PIPING SHALL NOT BE EXPOSED TO DIRECT SUNLIGHT UNLESS PROTECTED BY WATER BASED SYNTHETIC LATEX PAINTS. CPC 312.13
- 12. PVC PIPING SHALL NOT BE EXPOSED TO DIRECT SUNLIGHT UNLESS PROTECTED BY WATER BASED SYNTHETIC LATEX PAINT, .04" THICK WRAP OR OTHERWISE PROTECTED FROM UV DEGRADATION. CPC 312.14
- 13. THE ADJACENT SPACE NEXT TO SHOWERS WITHOUT THRESHOLDS (CURBLESS) SHALL BE CONSIDERED A "WET LOCATION"
- 14. DOMESTIC HOT WATER LINES SHALL BE INSULATED. INSULATION SHALL BE THE THICKNESS OF THE PIPE DIAMETER UP TO 2" IN SIZE AND MINIMUM 2" THICKNESS FOR PIPES LARGER THAN 2" IN DIAMETER.
- 15. UNDERFLOOR CLEANOUTS SHALL NOT BE MORE THAN 5 FEET (OLD CODE WAS 20FT) FROM AN UNDERFLOOR ACCESS, ACCESS DOOR OR TRAP DOOR.
- 16. 710.1. DRAINAGE PIPING SERVING FIXTURES WHICH HAVE FLOOD LEVEL RIMS LESS THAN TWELVE (12) INCHES (304,8 MM) ABOVE THE ELEVATION OF THE NEX UPSTREAM MANHOLE AND/OR FLUSHING INLET COVER AT THE PUBLIC OR PRIVATE SEWER SYSTEM SERVING SUCH DRAINAGE PIPING SHALL BE PROTECTED FROM BACKFLOW OF SEWAGE BY INSTALLING AN APPROVED TYPE BACKWATER VALVE. FIXTURES ABOVE SUCH ELEVATION SHALL NOT DISCHARGE THROUGH THE BACKWATER VALVE, UNLESS FIRST APPROVED BY THE ADMINISTRATIVE AUTHORITY.
- 17. NO DOMESTIC DISH WASHING MACHINE SHALL BE DIRECTLY CONNECTED TO A DRAINAGE SYSTEM OR FOOD WASTE DISPOSER WITHOUT THE USE OF AN APPROVED DISHWASHING AIR GAP FITTING ON THE DISCHARGE SIDE OF THE DISHWASHING MACHINE. LISTED AIRGAPS SHALL BE INSTALLED WITH THE FLOOD-FLEVEL MARKING AT OR ABOVE THE FLOOR LEVEL OF THE SINK OR DRAINBOARD, WHICHEVER IS HIGHER. CPC 807.3
- 18. ALL PLUMBING FIXTURES AND FITTINGS SHALL MEET THE STANDARDS REFERENCED IN TABLE 1701.1 2019 CPC & CGBSC SECTION 4.303.2
- 19. ANNULAR SPACES AROUND PIPES, ELECTRIC CABLES, CONDUITS OR OTHER OPENINGS IN SOLE/BOTTOM PLATES AT EXTERIOR WALLS SHALL BE PROTECTED AGAINST THE PASSAGE OF RODENTS BY CLOSING SUCH OPENINGS WITH CEMENT MORTAR, CONCRETE MASONRY, OR SIMILAR ACCEPTABLE METHODS. CGBSC SECTION 4.406.1

SHOWER NOTES

- 1. THE SHOWER COMPARTMENT(S) REGARDLESS OF SHAPE, HAVING A MINIMUM INTERIOR FLOOR AREA OF 1,024 SQ INCHES AND ALSO CAPABLE OF ENCOMPASSING
- CIRCLE. THE MIN. REQUIRED AREA AND DIMENSIONS SHALL BE MEASURED AT A HEIGHT EQUAL TO THE TOP OF THE THRESHOLD AND AT A POINT TANGENT TO ITS CENTERLINE. THE AREA AND DIMENSION SHALL BE MAINTAINED TO A POINT OF NOT LESS THAN 70 INCHES ABOVE THE SHOWER DRAIN OUTLET. PER 2019 CPC
- 2. SHOWERS (AND TUB/SHOWERS) ARE PROVIDED WITH PRESSURE BALANCE OR THERMOSTATIC MIXING VALVE CONTROLS, PER 2019 CPC 408.3 SHOWER (AND TUB/SHOWER) WALLS HAVE A SMOOTH, HARD, NONABSORBENT SURFACE OVER A MOISTURE RESISTANT UNDERLAYMENT TO A HEIGHT OF 72" ABOVE THE DRAIN INLET PER 2019 CRC 307.2
- 3. THE FINISHED FLOOR OF THE RECEPTOR SHALL SLOPE UNIFORMLY FROM THE SIDES TOWARD THE DRAIN NOT LESS THAN 1/4" PER FOOT AND NOT MORE THAN 1/2" PER FOOT
- 4. DOORS AND PANELS OF SHOWER AND BATHTUB ENCLOSURES AND ADJACENT WALL OPENINGS WITHIN 60 INCHES VERTICALLY AND 60" HORIZONTALLY ABOVE THE ADJACENT TO THE STANDING SURFACE AND DRAIN INLET SHALL BE FULLY TEMPERED, LAMINATED SAFETY GLASS OR APPROVED PLASTIC PER 2019 CRC 308.4.5
- 5. DOOR INTO THE ENCLOSE PROVIDES A MINIMUM 22" CLEAR WIDTH DIMENSION PER 2019 CPC 408.5 DOOR MUST OPEN OUTWARD
- 6. THE LOCATION OF THE VALVE CONTROLS LOCATED ON THE SIDE WALL OR ARRANGED SO THAT THE SHOWER DOES NOT SPRAY DIRECTLY AT THE ENTRANCE.

REVISIONS DATE




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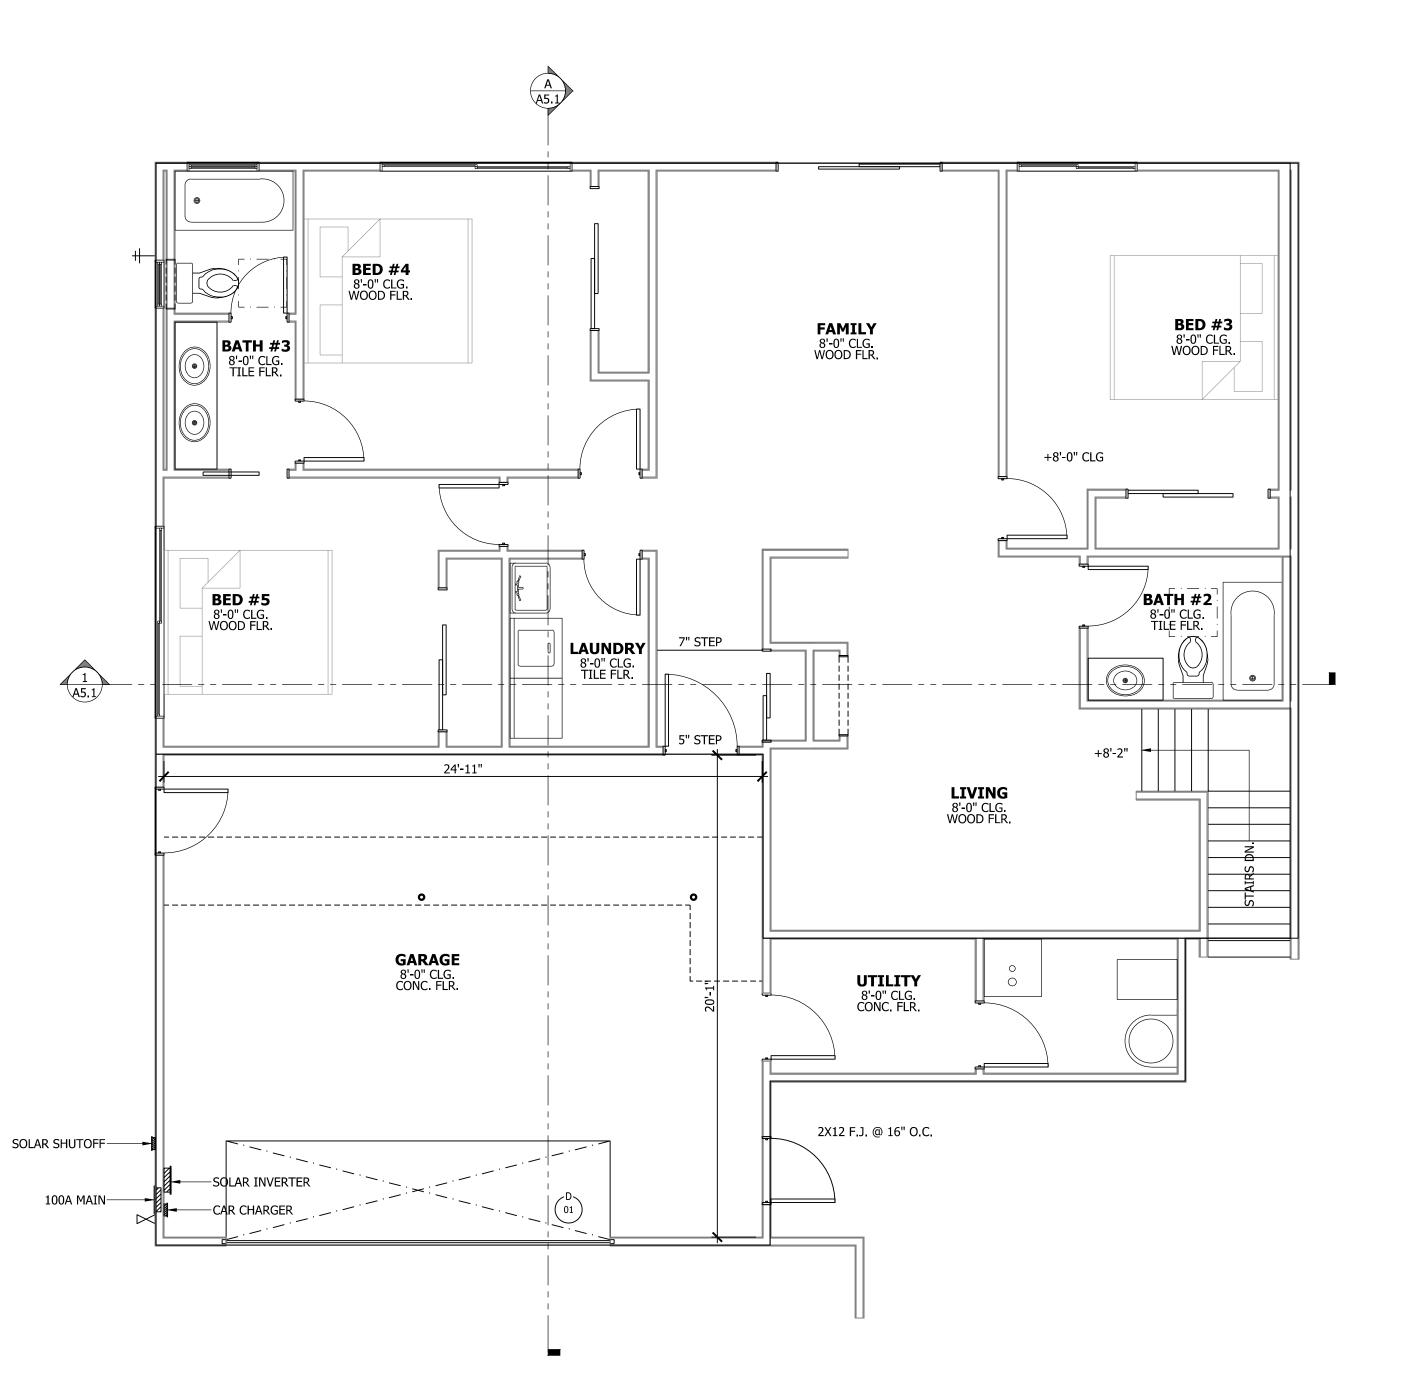
2022.04.07

PER SHEET DAVID

2127

FILENAME:E:\EGNYTE\SHARED\ KUOP DESIGNS\ PROJECTS\21-027 2669 MARTINEZ DR\ 2669 MARTINEZ\SHEETS\A1.1 ARCHITECTURAL NOTES.DV



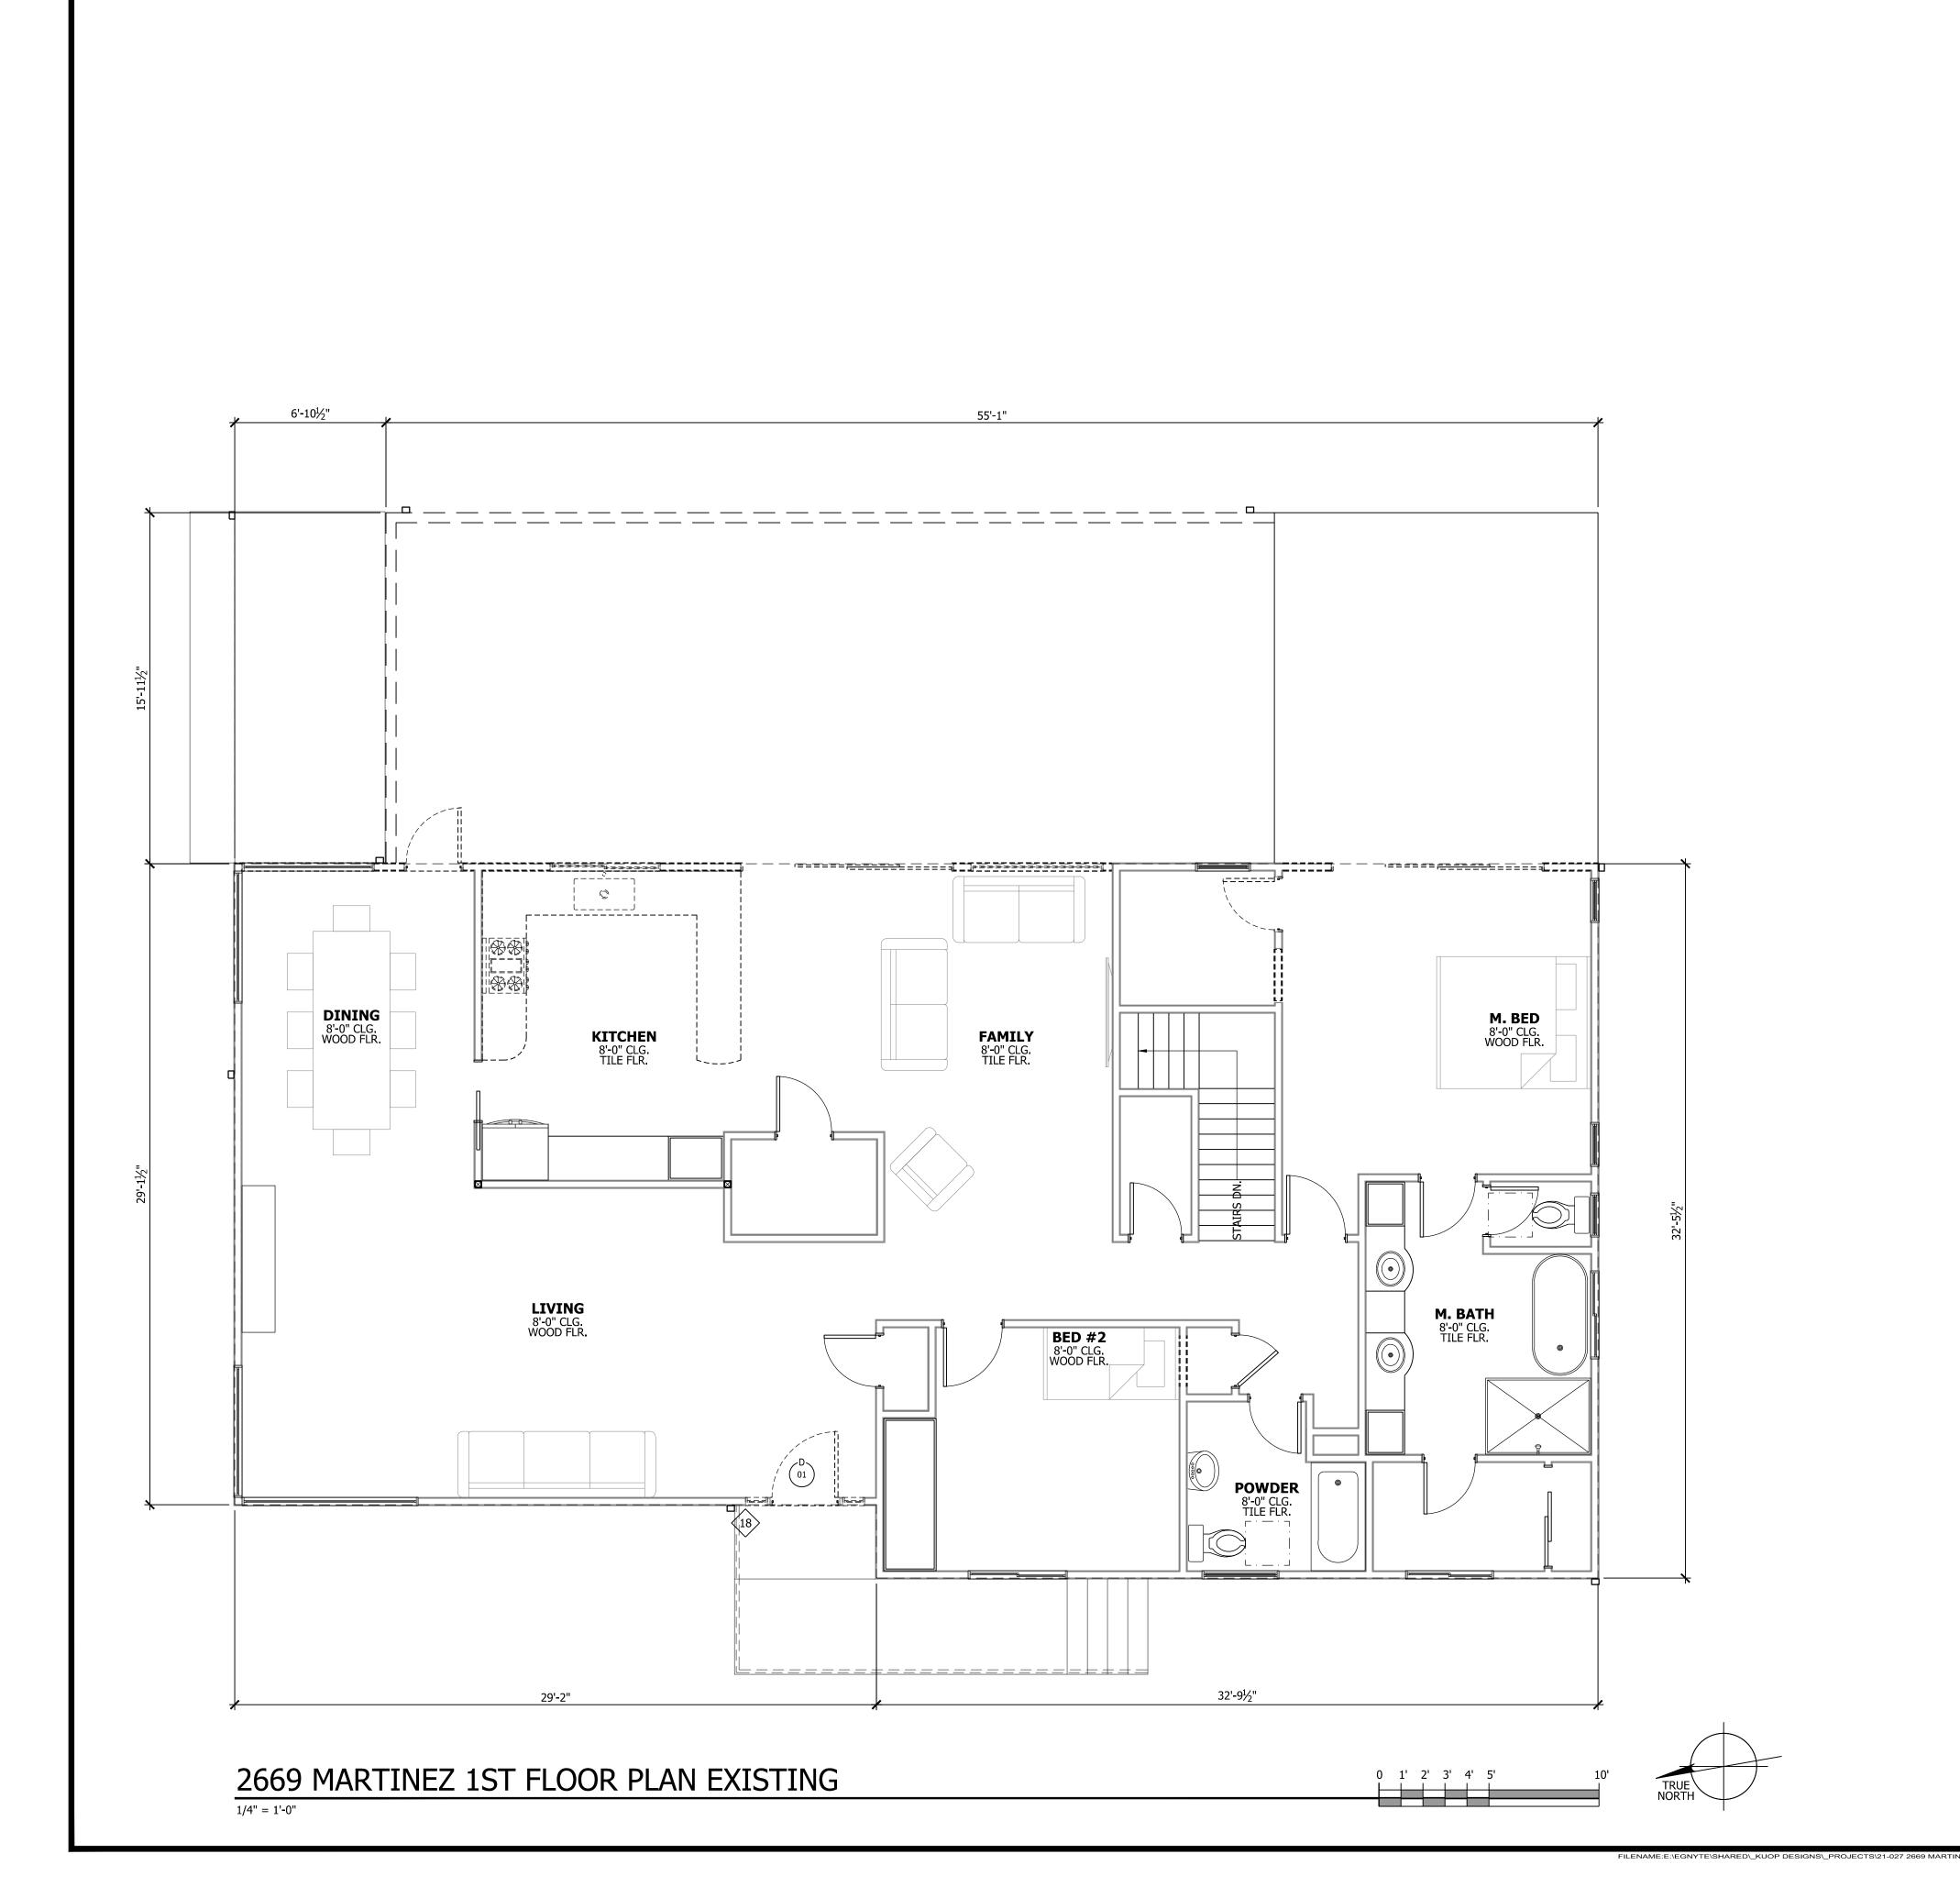

SEE DETAIL 1/A10.0 FOR WINDOW EGRESS


	WINDOW SCHEDULE						
NUMBER		ZE	STYLE NOTES		Frame Finish		
INOMBER	WIDTH	WIDTH HEIGHT STYLE NOT	NOTES				
1	8'-0"	4'-0"	SLIDER	EXISTING	VINYL		
2	2'-0"	3'-0"	SINGLE HUNG	EXISTING	VINYL		
3	3'-0"	2'-0"	SINGLE HUNG	EXISTING	VINYL		
4	8'-0"	4'-0"	SLIDER	EXISTING	VINYL		
5	5'-0"	4'-0"	SLIDER	EXISTING	VINYL		

TRUE


2669 MARTINEZ LOWER FLOOR PLAN EXISTING

1/4" = 1'-0"

FOR REFERENCE ONLY

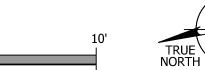

REVISIONS DATE

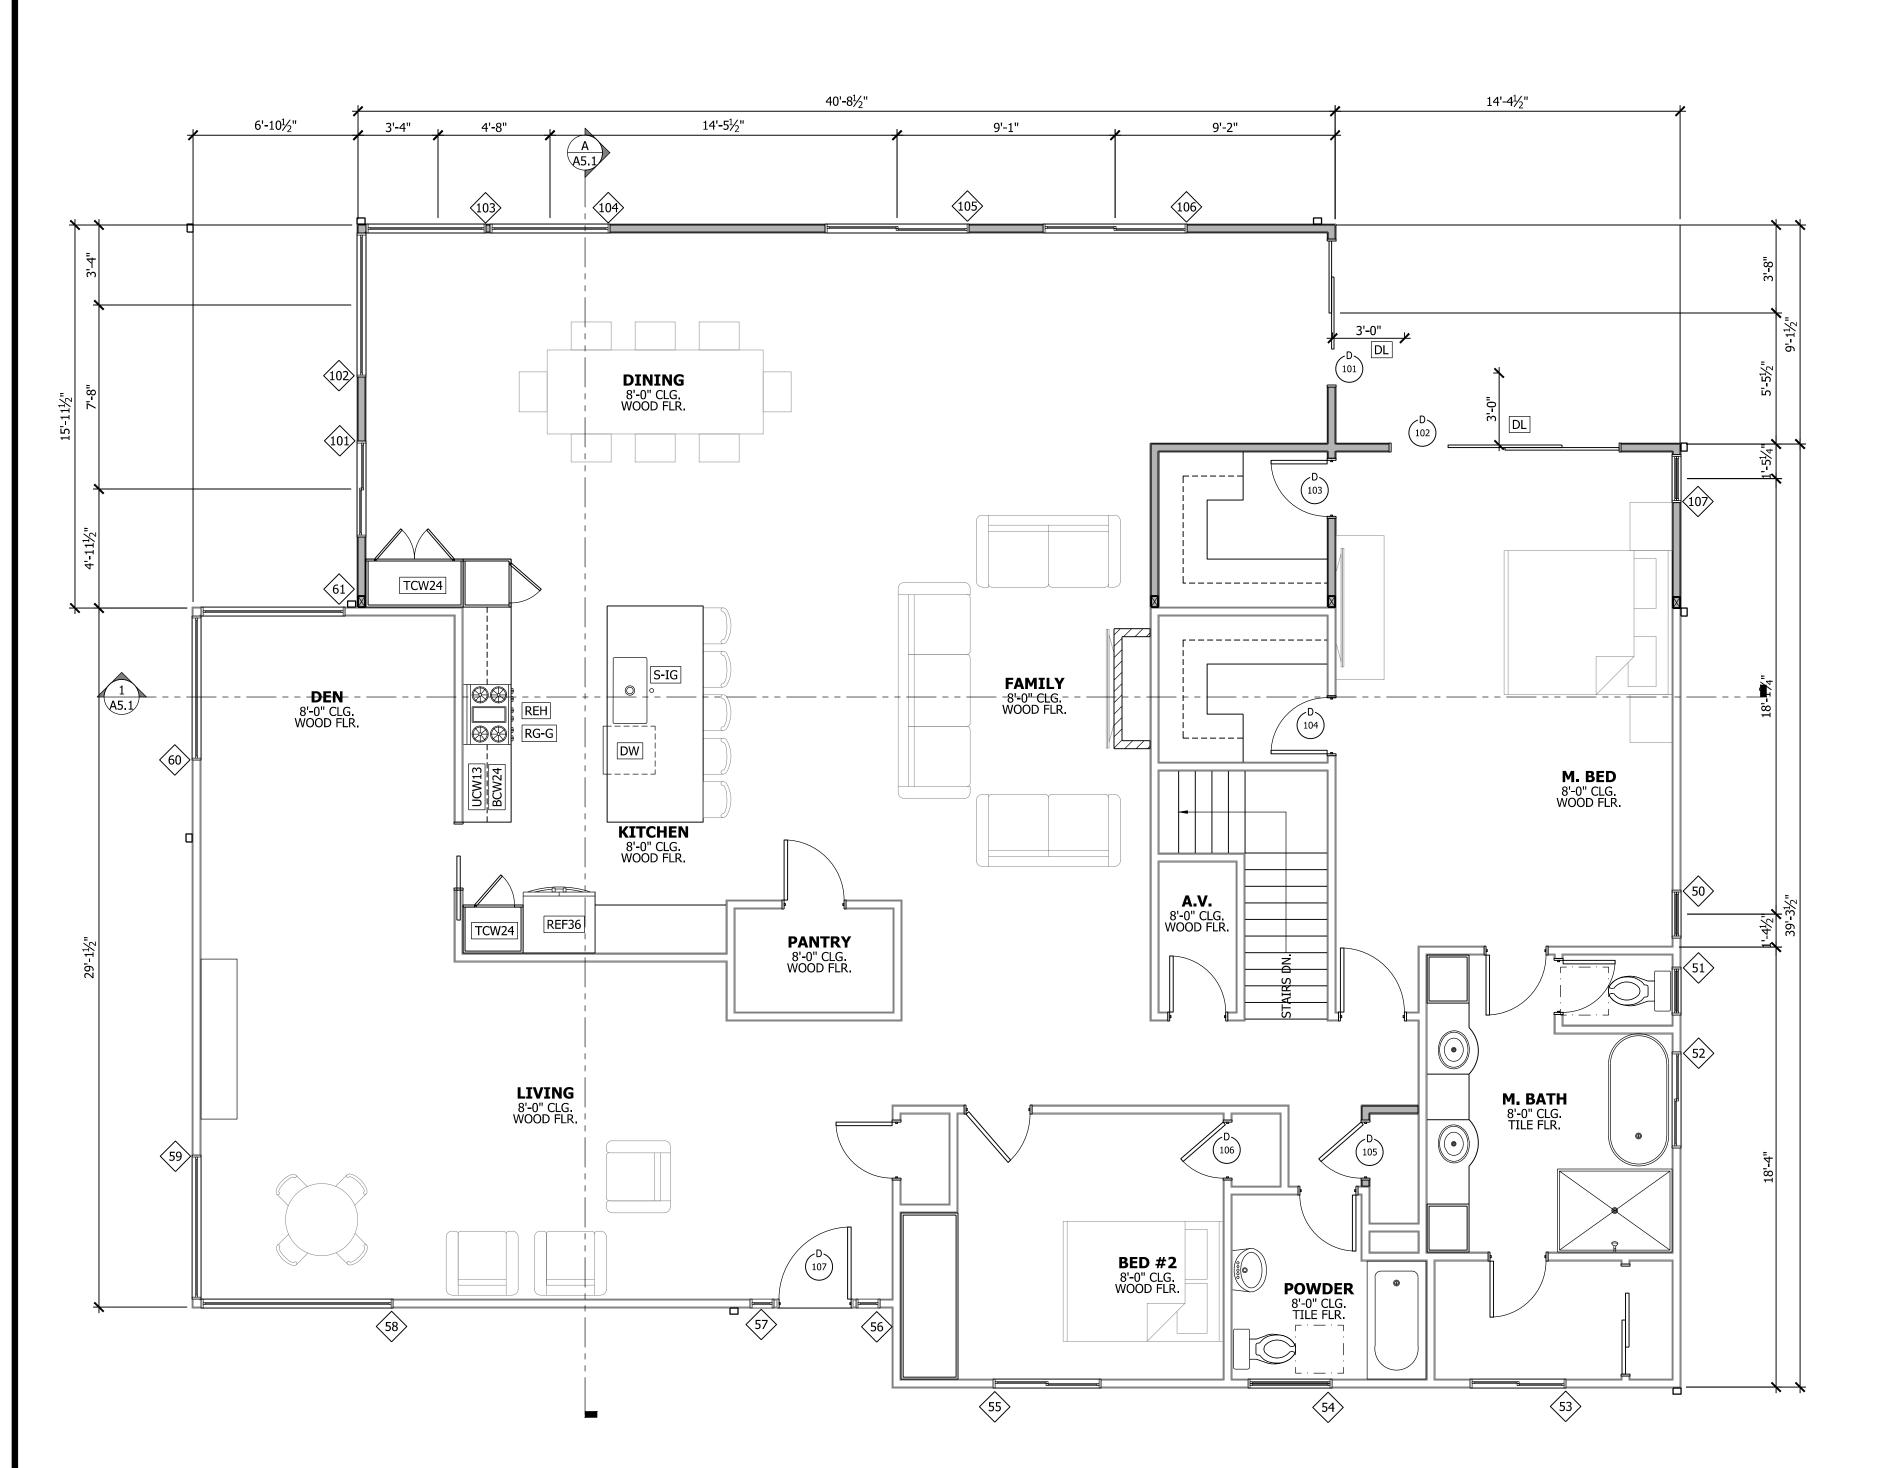


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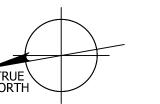
,	WIN	DOW	SCHE	DUL	.E
NUMBER	S	ZE	STYLE	NOTES	Frame Finish
NONDLIX	WIDTH	HEIGHT	STILL	INOTES	Traine Tillish
50	2'-0"	3'-6"	SINGLE HUNG	EXISTING	VINYL
51	2'-0"	3'-0"	SINGLE HUNG	EXISTING	VINYL
52	4'-0"	3'-0"	SLIDER	EXISTING	VINYL
53	4'-0"	4'-6"	SLIDER	EXISTING	VINYL
54	3'-6"	3'-0"	SINGLE HUNG	EXISTING	VINYL
55	4'-6"	4'-6"	SLIDER	EXISTING	VINYL
56	1'-0"	6'-8"	PICTURE	EXISTING	WOOD
57	1'-0"	6'-8"	PICTURE	EXISTING	WOOD
58	8'-0"	5'-0"	PICTURE	EXISTING	VINYL
59	6'-0"	5'-0"	PICTURE	EXISTING	VINYL
60	6'-0"	6'-0"	PICTURE	EXISTING	VINYL
61	6'-0"	6'-0"	PICTURE	EXISTING	VINYL
101	4'-0"	4'-0"	SLIDER		VINYL
102	6'-0"	4'-0"	PICTURE	RE-USE	VINYL
103	5'-0"	6'-0"	PICTURE		VINYL
104	5'-0"	6'-0"	PICTURE		VINYL
105	6'-0"	6'-0"	SLIDER		VINYL
106	6'-0"	6'-0"	SLIDER		VINYL
107	2'-0"	3'-6"	SINGLE HUNG	RE-USE	VINYL

DOOR AND FRAME SCHEDULE					
Number	SIZE	STYLE	NOTES(Frame Finish	
101	PR 3'-0" x 6'-8" x 1-1/4"	SLIDING - EXTERIOR		VINYL	
102	PR 4'-9" x 6'-8" x 1-1/4"	SLIDING - EXTERIOR		VINYL	
103	2'-4" x 6'-8" x 1-3/4"	SINGLE - INTERIOR			
104	2'-4" x 6'-8" x 1-3/4"	SINGLE - INTERIOR			
105	2'-4" x 6'-8" x 1-3/4"	SINGLE - INTERIOR			
106	2'-4" x 6'-8" x 1-3/4"	SINGLE - INTERIOR			
107	3'-0" x 6'-8" x 1-3/4"	SINGLE - EXTERIOR		WOOD	


REFERENCE KEYNOTES						
DIVISIO	DIVISION 06 - WOOD AND PLASTICS					
CABINETRY -						
BCW24	-	BASE CABINET, WOOD, 24" DEEP, W/ ADJUSTABLE SHELVES				
TCW24	-	TALL CABINET, WOOD, 24" DEEP, W/ ADJUSTABLE SHELVES				
UCW13	-	UPPER CABINET, WOOD, 13" DEEP W/ ADJUSTABLE SHELVES				
DIVISIO	ON (08 - DOORS AND WINDOWS				
DL	-	LANDINGS MAX OF 7 3/4" DOWN FROM SLIDERS AND IN SWINGING DOORS OR MAX 1 1/2" DOWN FROM OUT SWINGING DOORS				
DIVISIO	ON 1	l1 - EQUIPMENT				
DW	-	DISHWASHER				
REF36	-	36" WIDE REFRIGERATOR, PROVIDE PLUMBING FOR ICE MAKER				
REH	-	RANGE EXHAUST HOOD, VENTED, SEE ENERGY COMPLIANCE NOTES #4 SHEET A1.1				
RG-G	-	RANGE; GAS				
DIVISION 22 - PLUMBING						
S-IG	-	ISLAND SINK W/ GARBAGE DISPOSAL, SEE DETAIL 5/A10.0				


2669 MARTINEZ 1ST FLOOR PLAN NEW



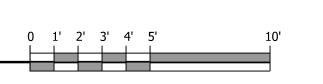



REVISIONS DATE

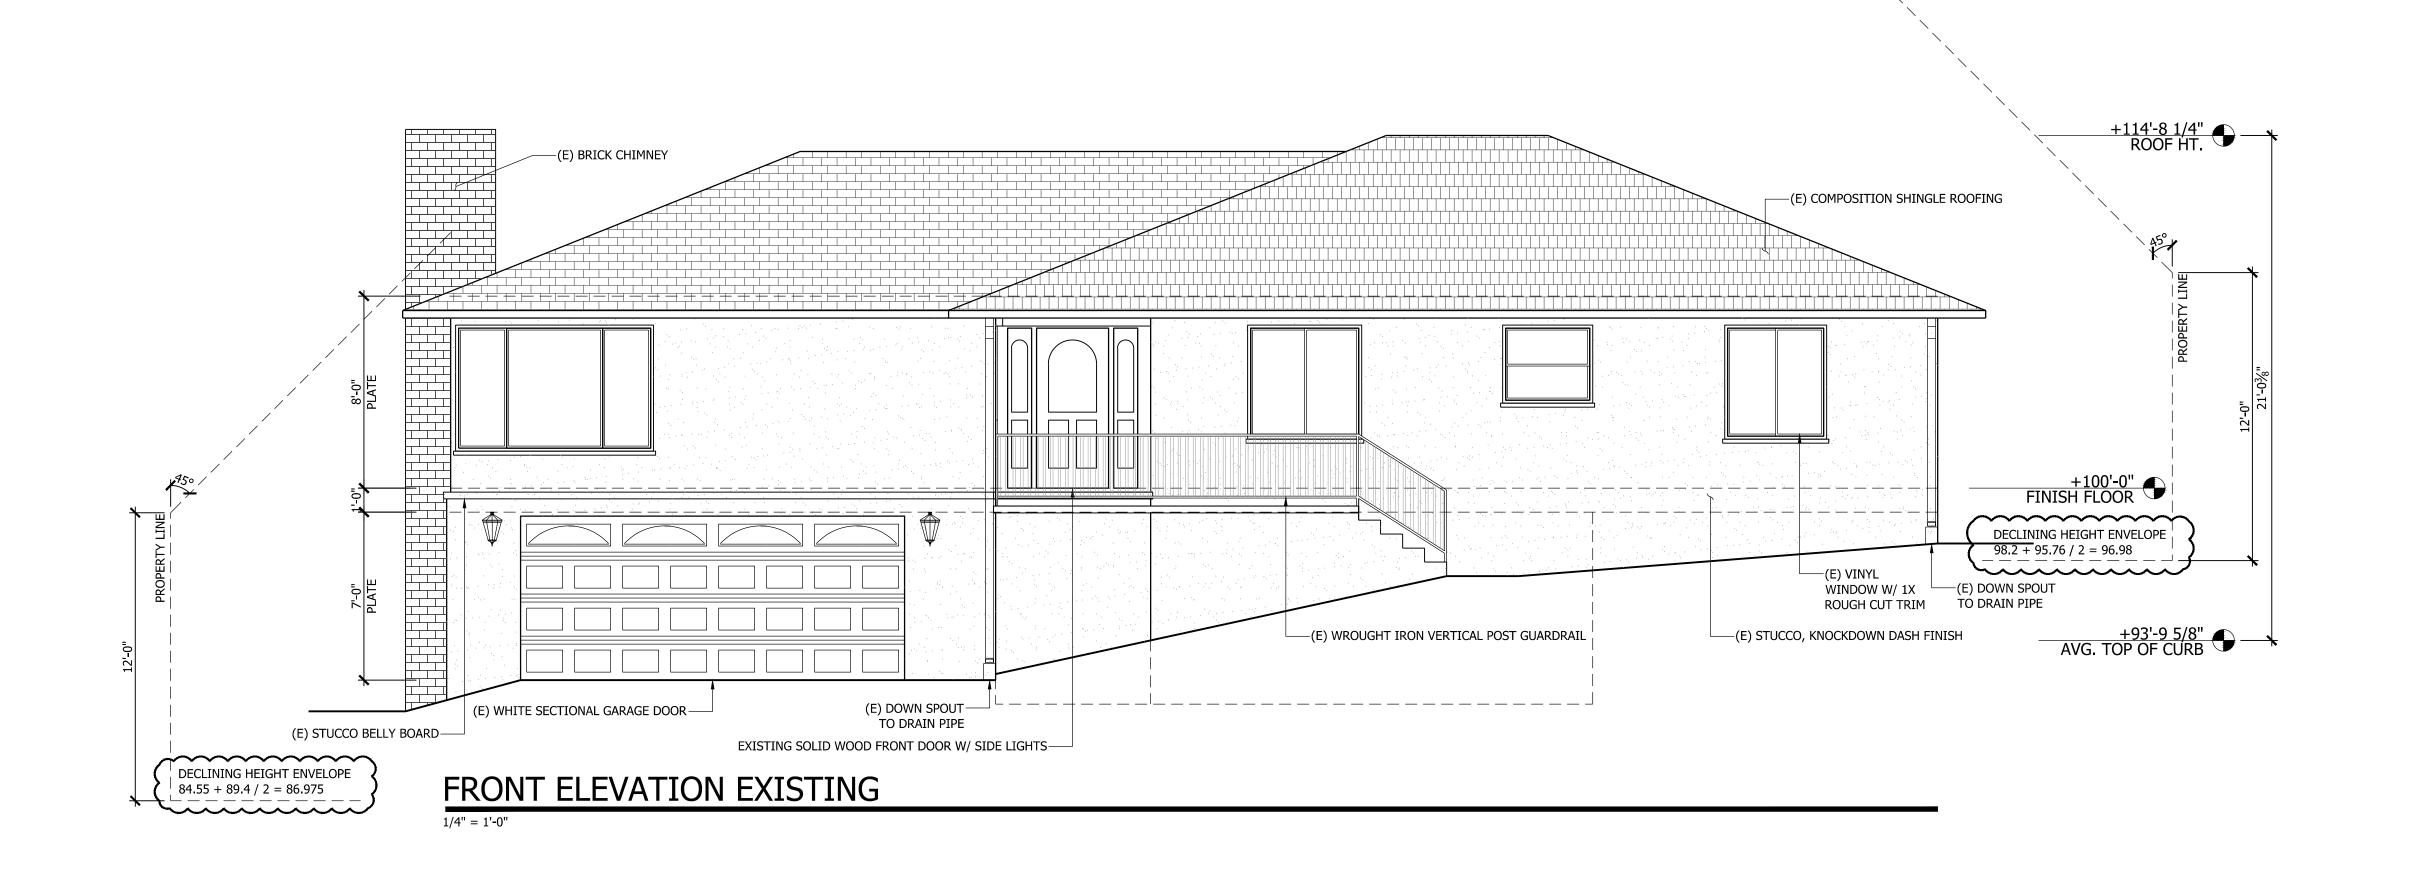

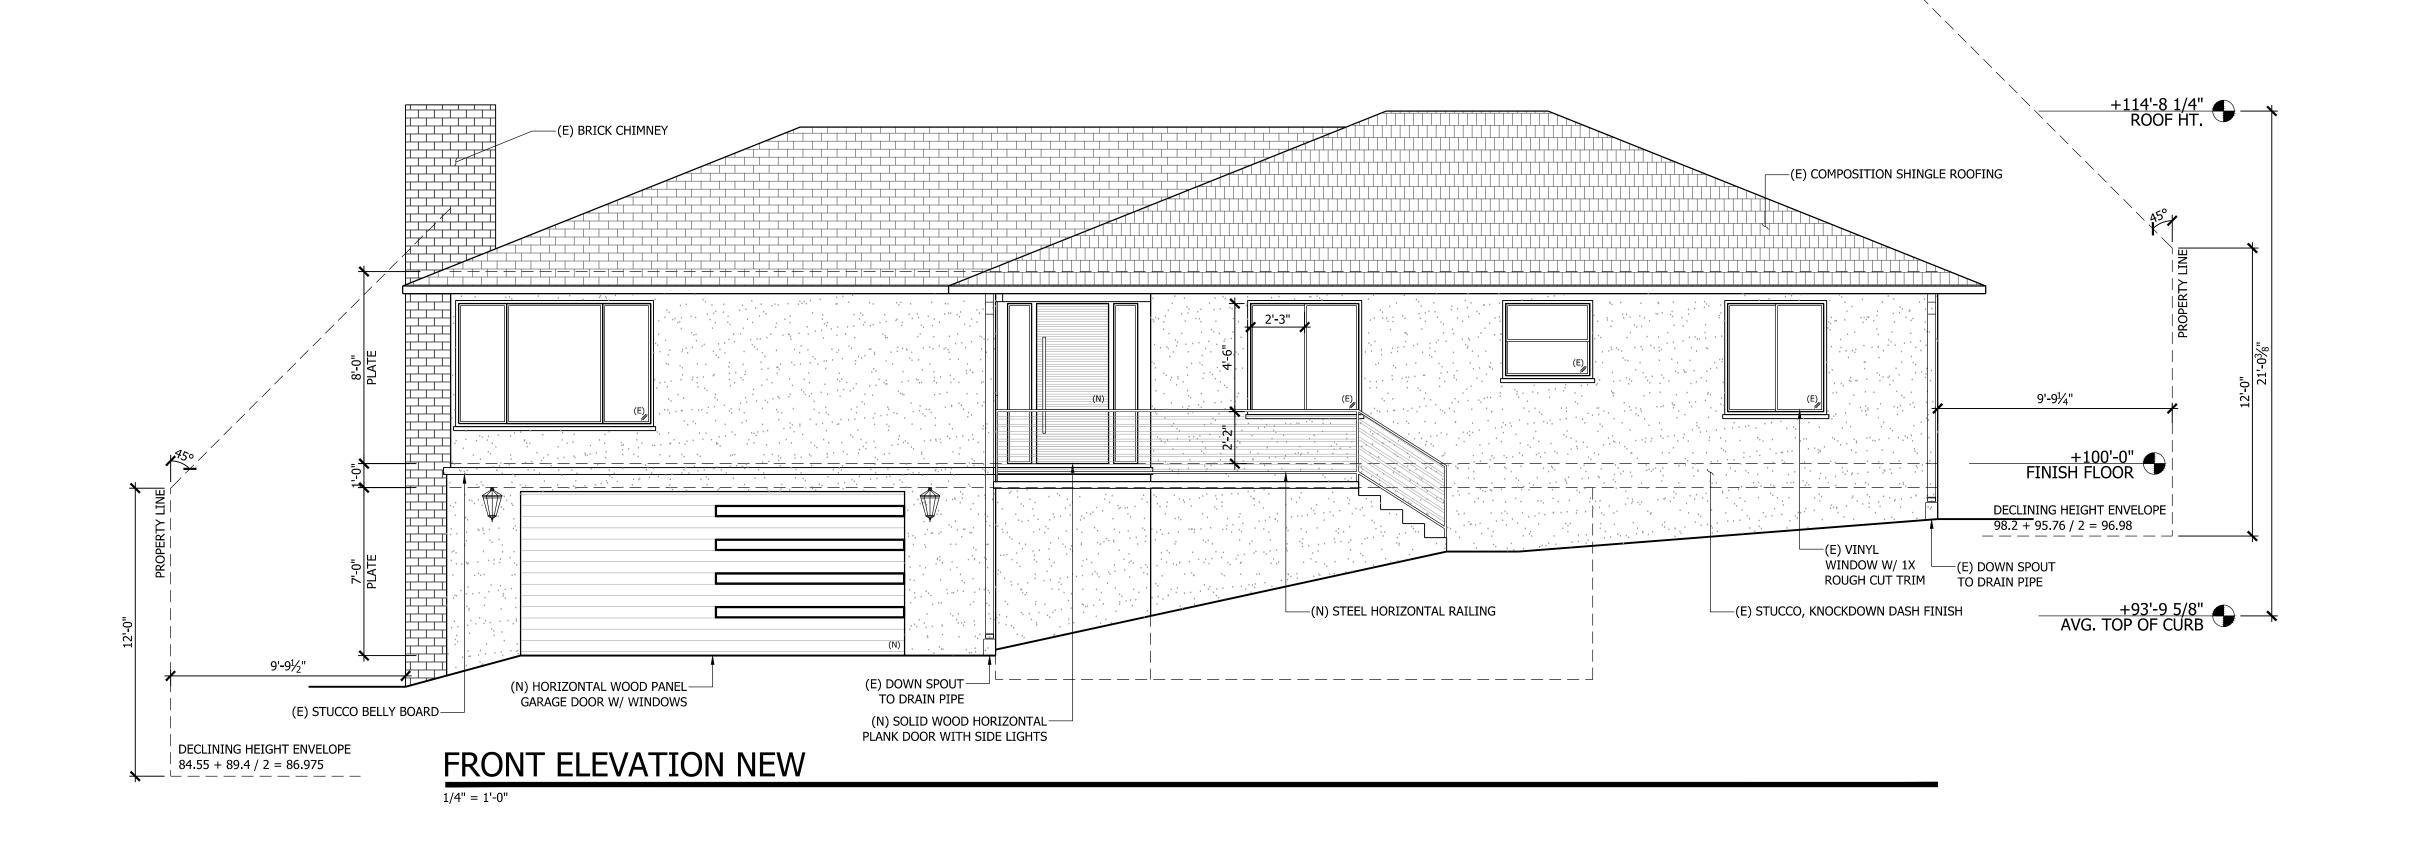


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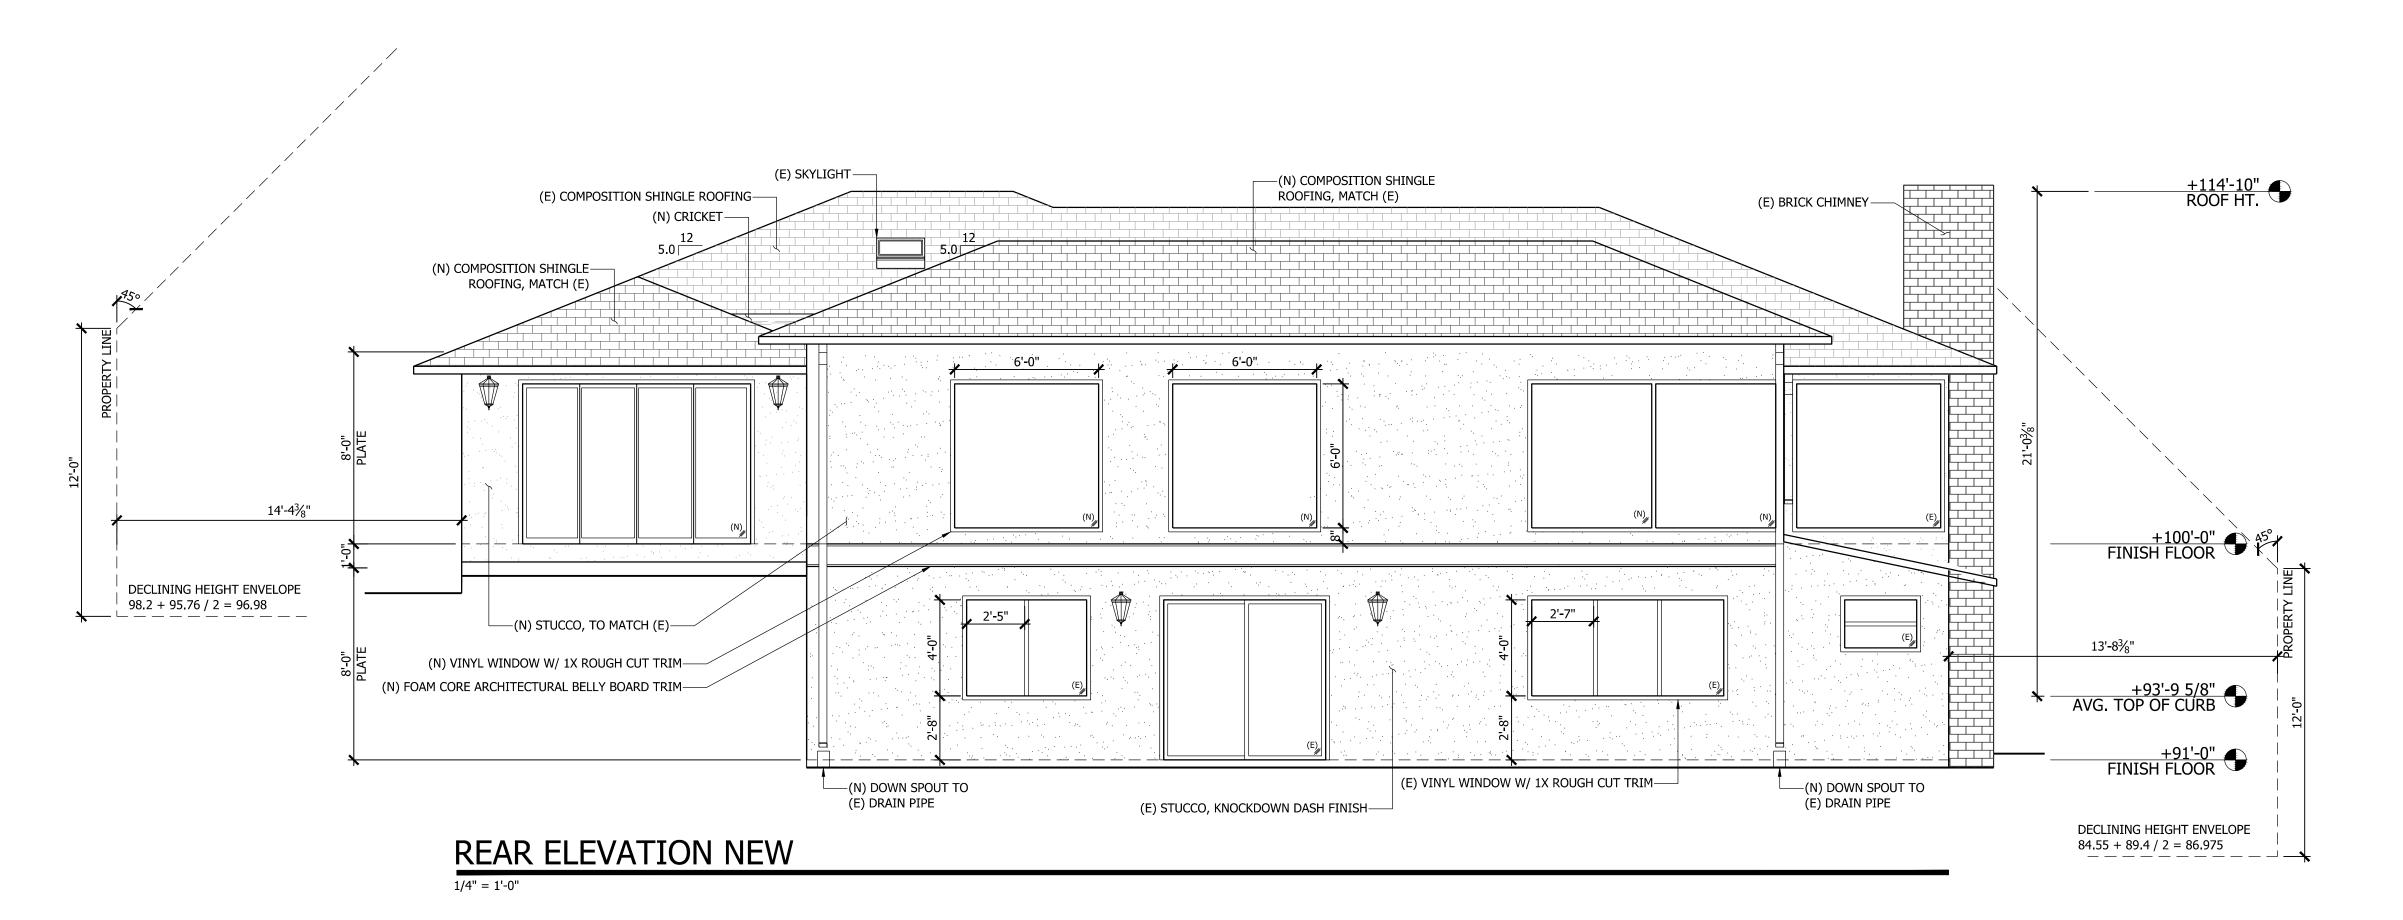


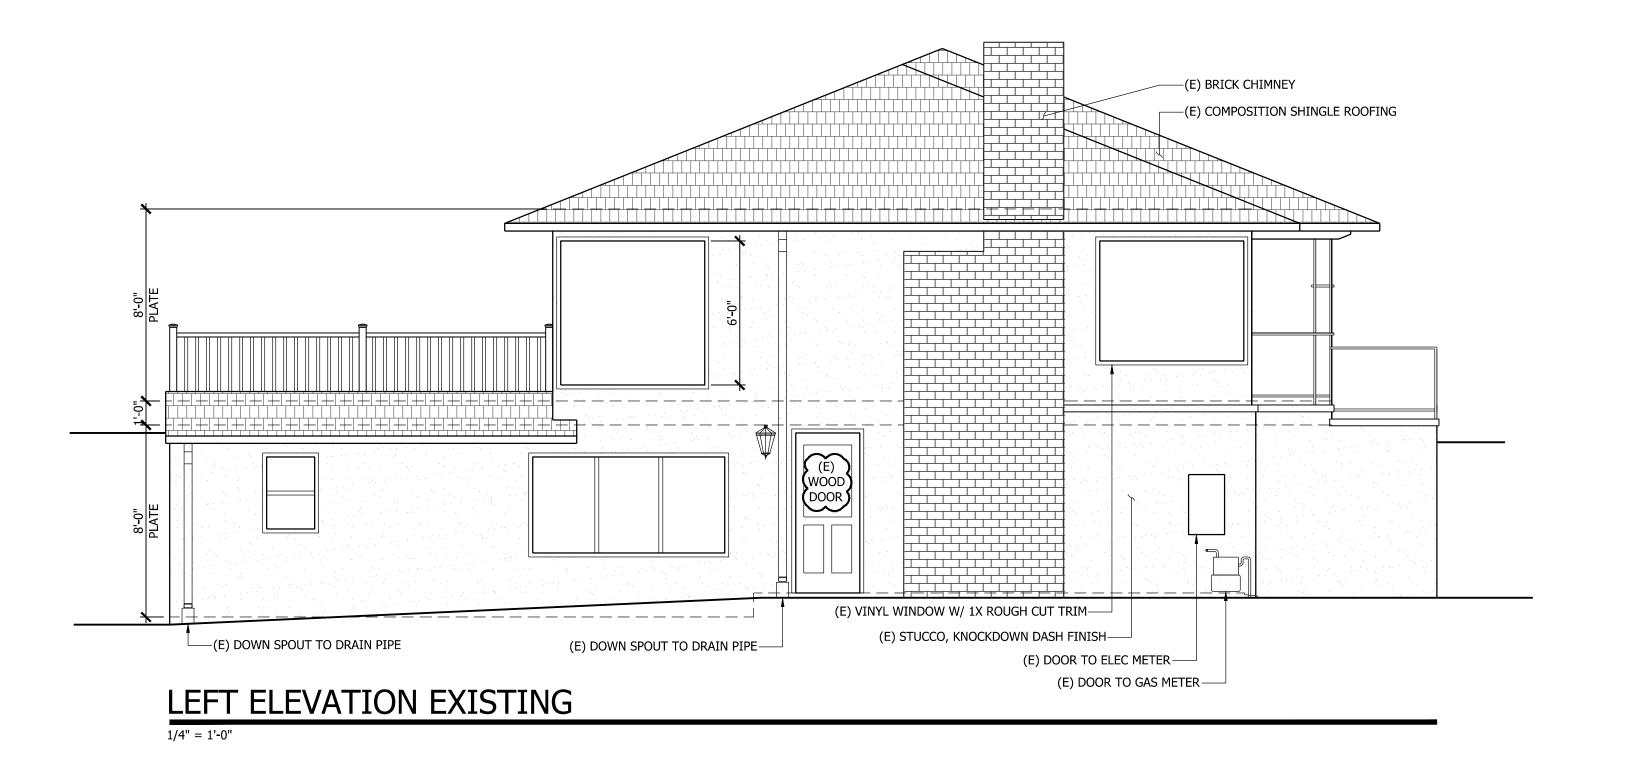

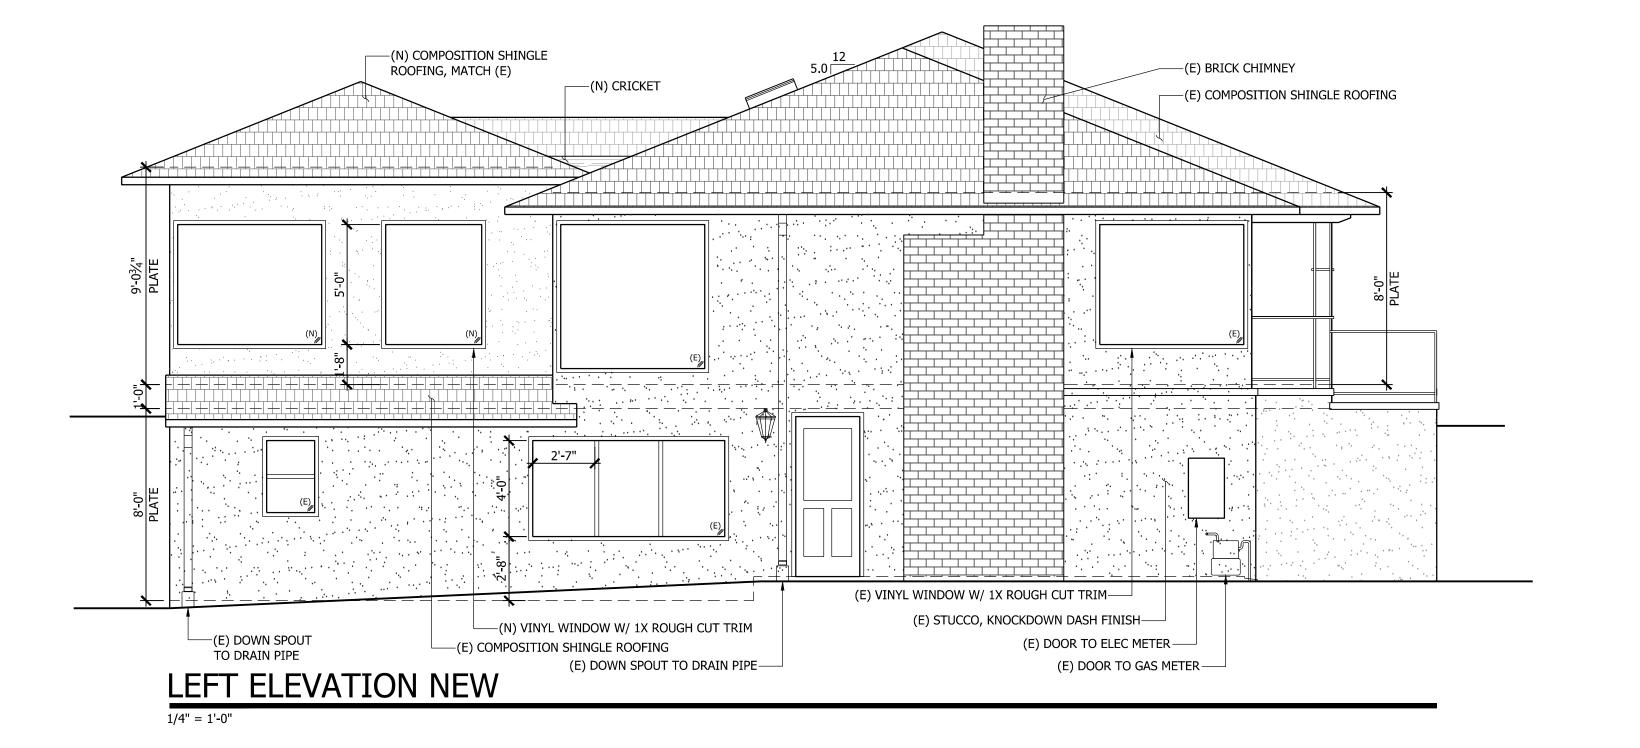
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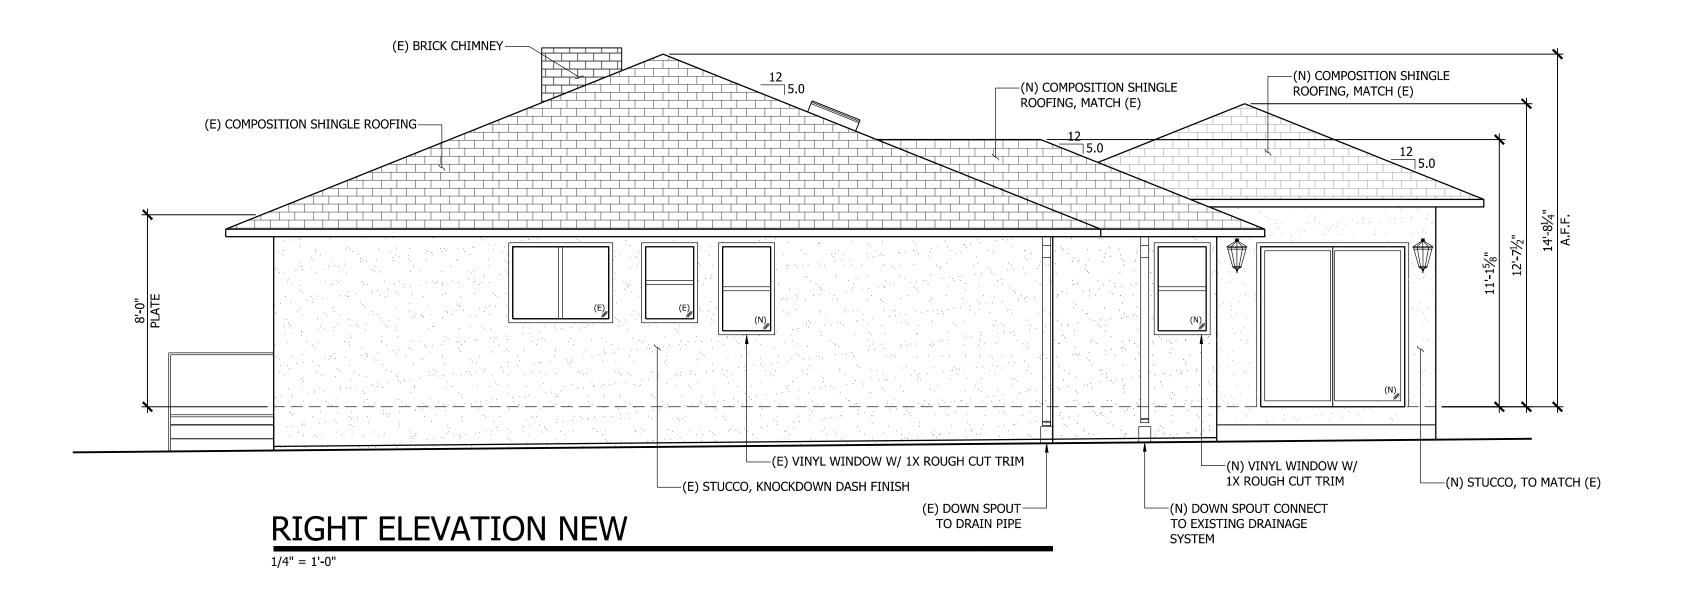
A3.2



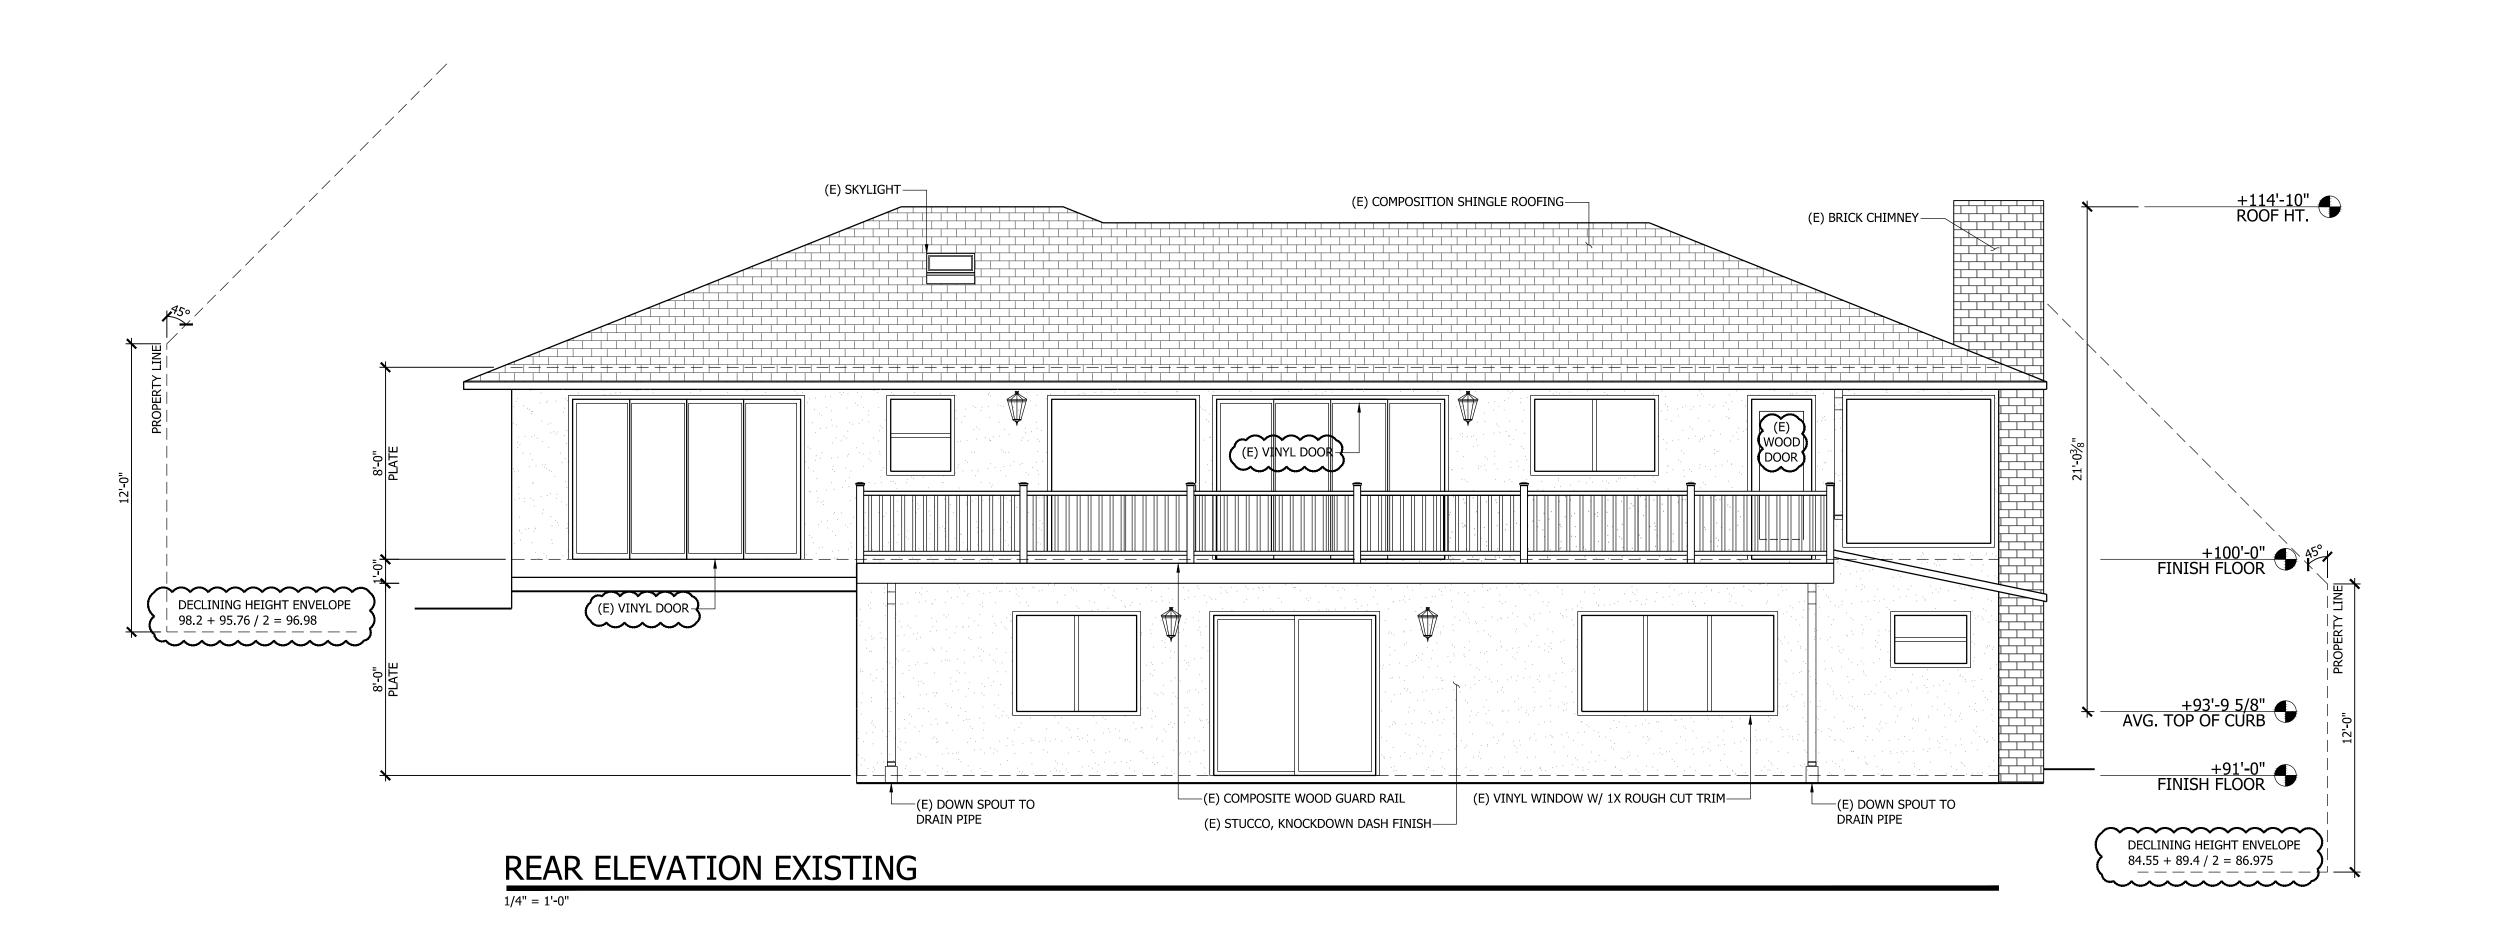


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ATTIC VENTILATION CALCULATIONS 1ST FLOOR ROOF:

748 SF ATTIC/300 EQUAL TOTAL 2.5 SF

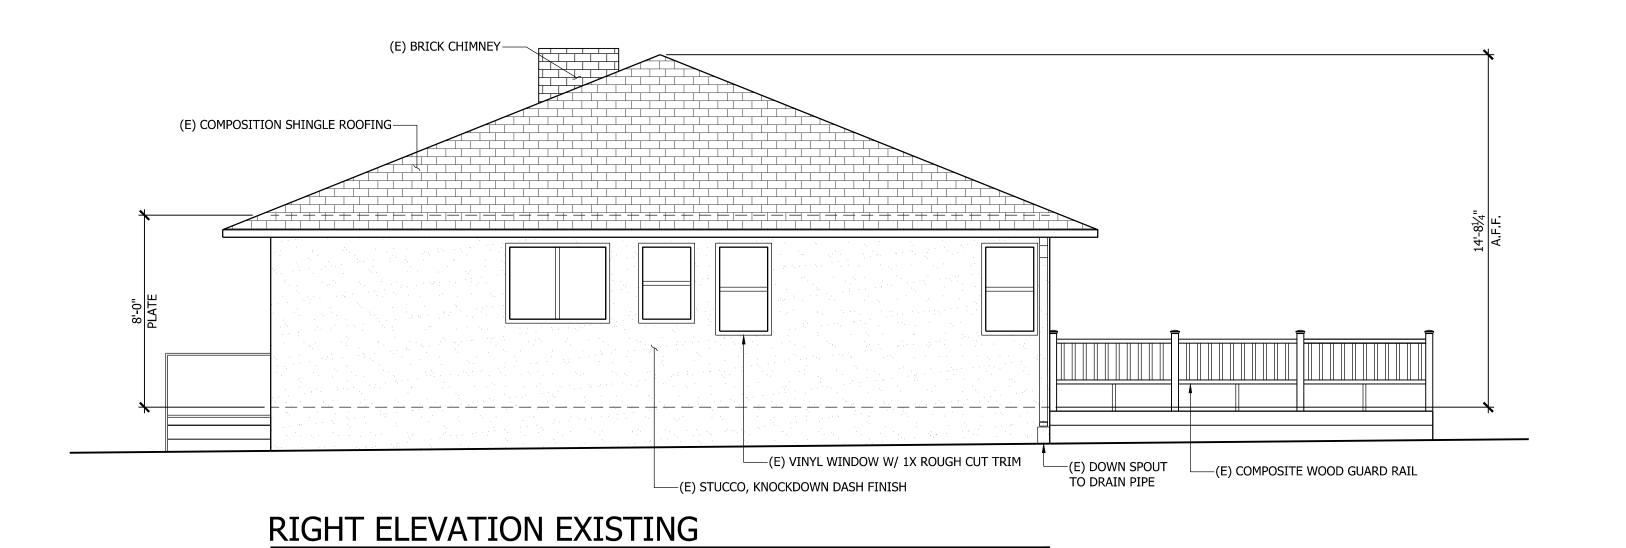NEED 2.8 SF LOW VENT

(5) LOW PRO VENTS @ .3 SF EACH 1.5 SF

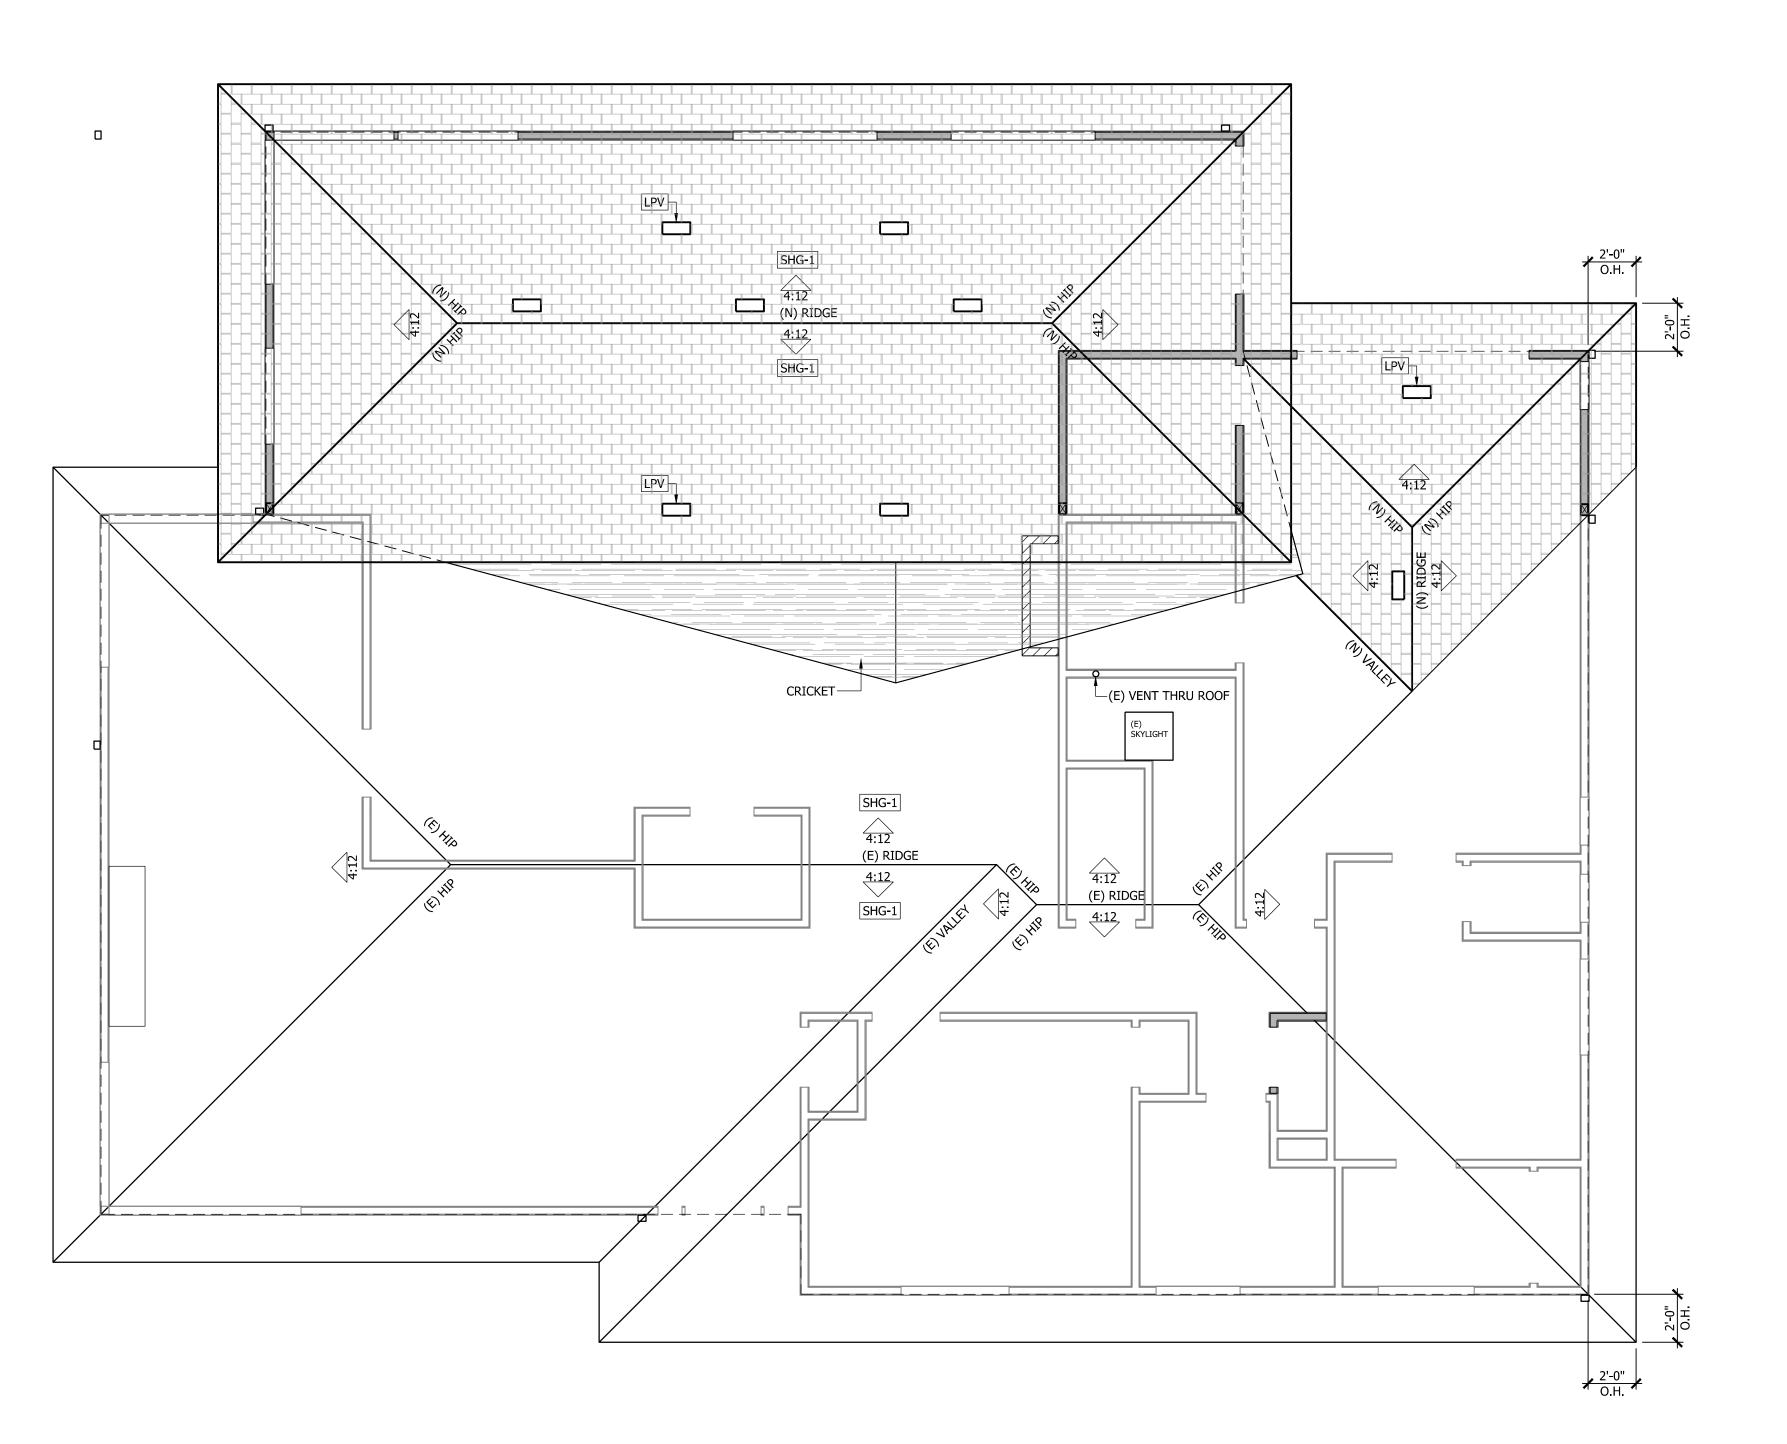2.7 SF TO BE INSTALLED

REFERENCE KEYNOTES

DIVISION 07 - THERMAL AND MOISTURE PROTECTION

ROOFING AND SIDING -

BUR - BUILT-UP ASPHALT ROOF SYSTEM

LPV - LOW PROFILE ROOF VENT, PREFINISHED TO MATCH ROOFING. SHG-1 - (E) COMPOSITION SHINGLE ROOFING

ROOF NOTES:

- PLYWOOD FOR ANY SURFACE OR EDGE EXPOSED TO WEATHER MUST BE BONDED WITH EXTERIOR GLUE.
- 2. EXPOSED GLU-LAMS SHALL BE PRESERVATIVE TREATED, APPLIED BY THE MANUFACTURER, OR MADE FROM NATURALLY DURABLE WOOD.
- 3. ALL FASTENERS USED FOR ATTACHMENT OF SIDING SHALL BE CORROSION-RESISTANT
- 4. NEW ROOF SHEATHING TO BE MINIMUM 15/32"CDX/OSB APA RATED FOR 24" O.C. FRAMING, RADIANT BARRIER NAIL WITH 8d AT 6" O.C. EDGE, 12 O.C. FIELD. INSTALL WITH FACE GRAIN PERPENDICULAR TO FRAMING, STAGGER END JOINTS.
- 5. CORROSION RESISTANT FLASHING SHALL BE PROVIDED AT OPENINGS AND INTERSECTIONS/ATTACHMENTS. (R703.8)
- 6. FIRE BLOCKING SHALL BE PROVIDED IN CONCEALED SPACES OF STUD WALLS AND PARTITIONS, INCLUDING FURRED SPACES AND PARALLEL ROWS OF STUDS OR STAGGERED STUDS; VERTICALLY AT FLOOR AND CEILING LEVELS, HORIZONTALLY AT INTERVALS NOT TO EXCEED 10' (R302.11)
- 7. FASTENERS FOR PRESERVATIVE-TREATED AND FIRE-RETARDANT-TREATED WOOD SHALL BE OF HOT DIPPED ZINC-COATED GALVANIZED STEEL, STAINLESS STEEL, SILICON BRONZE OR COPPER.
- 8. MOISTURE CONTENT OF BUILDING MATERIALS USED IN WALL AND FLOOR SHALL BE CHECKED BEFORE ENCLOSURE, CBC 4.505.3

2669 MARTINEZ 1ST FLOOR PLAN NEW

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2022.04.07

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