PRAKASH-RAO RESIDENCE

2836 MARIPOSA DRIVE BURLINGAME, CA

RECEIVED

08/26/22

CITY OF BURLINGAME **CDD-PLANNING DIVISION**

LEGEND DRAWING INDEX **ABBREVIATIONS** PROJECT DATA LOCATION: A1.0 TITLE SHEET LABORATORY EACH EXPANSION JOINT ANGLE AT SEE ARCHITECTURAL DUPLEX OUTLET, DED INDICATES DEDICATED CIRCUIT SURVEY 2836 MARIPOSA DR. LAV. LB. L.F. DOCUMENTS A1.1 SITE PLAN CENTERLINE 220 INDICATES 220V OUTLET, 4 INDICATES 4 WAY SWITCH BURLINAGME, CA ELEVATION SHELF AND HANGING ROD ELECTRICAL W.P. INDICATES WEATHER-PROOF PUBLIC WORKS STANDARD DETAILS LINEAR FEET ASSESSOR'S PARCEL #: 025-072-100 POUND OR NUMBER LEVATOR SCHEDULE LKR. LT. TELEPHONE OUTLET EMERGENCY PERPENDICULAR SOAP DISPENSER **ZONING DISTRICT: RS-6** EXISTING/DEMO PLAN ENCLOSURE CONSTRUCTION TYPE: V-B SWITCH, 3 & 4 INDICATES 3 OR 4 WAY SWITCH. ACOUS. ACOUSTICAL ENTRANCE SEE ELECTRICAL DOCUMENTS CONSTRUCTION PLAN AIR CONDITION ELECTRICAL PANELBOARD **OCCUPANCY TYPE:** HE INDICATES HIGH EFFICACY SQUARE FEET A2.1A AREA CALCULATIONS AD.JACENT INDICATES DIMMER SWITCH, F INDICATES FLUORESCENT JEATZULDA TZULDA EQUIPMENT EXISTING ROOF PLAN MEDICINE, MEDICAL O INDICATES OCCUPANCY SENSOR, L INDICATES LED LIGHTING, AGGR. AGGREGATE LECTRIC WATER COOLER FLOOR AREA RATIO INFORMATION SEE MECHANICAL DOCUMENTS MEMBRANE PROPOSED ROOF PLAN ALUMINUM SANITARY NAPKIN DISPENSER LOT SIZE: 15,072 SF MATCH EXISTING SMOKE DETECTOR, HARDWIRED ALTERNATE SANITARY NAPKIN RECEPTACLE **EXISTING AND PROPOSED FRONT ELEVATIONS EXCAVATE** SEE PLUMBING DOCUMENTS ALLOWABLE FAR FOR THE HOUSE: 32% OF LOT PLUS 1100 SF CARBON MONOXIDE/SMOKE DETECTOR, HARD-WIRED EXISTING AND PROPOSED REAR ELEVATIONS ACCESS PANE XPANSION SPECIFICATION ALLOWABLE FAR FOR THE HOUSE: 4,823 SF + 1,100 SF = 5,923 SF EXPOSED EXTERIOR APPROX. APPROXIMATE SPRINKLER A4.2 EXISTING AND PROPOSED SIDE ELEVATIONS GAS LINE EXISTING FAR HOUSE: HOUSE = 1,983 SF ASPHALT J-BOX ASSOCIATE AUTOMATIC FIRE ALARM GARAGE = 467 SF MISCELANEOUS SEE STRUCTURAL DOCUMENTS FLOOR DRAIN SERVICE SINK STAINLESS STEEL SPEAKER TOTAL EXISTING FAR HOUSE: FOUNDATION MOUNTED FIRE EXTINGUISHER DOWNLIGHT, D.P. INDICATES DAMP-PROOF NDITATS FIRE EXTINGUISHER CAB. STANDARD PROPOSED FAR HOUSE: (E) HOUSE = 1.983 SF FIRE HOSE CABINET NATURAL CEILING MOUNTED PENDANT FINISH STORAGE 1ST FLOOR ADDITION = 104 SF FIXTURE FLOOR STRUCTURAL WALL SCONCE, H.E. INDICATES HIGH EFFICACY, (E) GARAGE (NO CHANGE) = 467 SF M.D INDICATES MOTION DETECTOR 2ND FLOOR ADDITION = 918 SF SYMMETRICAL W.P. INDICATES WEATHER-PROOF FLUOR. FLUORESCENT SYSTEM FACE OF WALL-WASHER **TOTAL PROPOSED FAR HOUSE:** FACE OF CONCRET D.R. D.BS. D.C. D.D. DFF. DPNG. DPP. DX. DZ. TOWEL BAR FACE OF FINISH UNDERCABINET TASK, FLUORESCENT TASKLIGHT DBSCURE F.D.M. F.D.S. FACE OF MASONR ON CENTER — · — STRIP LIGHTING FACE OF STUDS TELEPHONE DUTSIDE DIAMETER TEMPERED, TEMPORARY EXHAUST FAN, LIGHT COMBINATION TERRAZZO OPENING TONGUE AND GROOVE DXYGEN DUNCE GAUGE COUNTER THRES, THRESHOLD ALLOWABLE LOT COVERAGE - .40 X 15,072 SF = 6,029 SF DENOTES EXISTING TO BE RELOCATED GALLON CASED OPENING PROJECT DIRECTORY GALVANIZED PLASTIC LAMINATE TOP OF CONCRETE DENOTES EXISTING TO REMAIN EXISTING LOT COVERAGE: 1,983 SF (HOUSE) + 467 SF (GAR) + 17 SF PLAST. PLASTER GRAB BAR (SMALL SHED) + 68 SF (STOR. SHED) + 26 SF (RAISED DECK) = 2,561 SF PLYWD. PLYWOOD TYPICAL **NEW PARTITIONS GENERAL** UNFINISHED GALVANIZED IRON GLASS GROUND GRADE GYPSUM UNLESS OTHERWISE NOTED NEW PARTIAL HEIGHT PARTITIONS P.T.D/R. PAPER TOWEL DISPENSER UR. UTIL. URINAL UTILITY VIKRAM PRAKASH AND SONAM RAO PROPOSED LOT COVERAGE: 2,087 SF (HOUSE 1ST FLOOR) + 467 SF (GAR) CORRIDOR NEW FIRE RATED PARTITIONS 2836 MARIPOSA DR. +17 SF (SMALL SHED) + 68 SF (STOR. SHED) + 26 SF (RAISÉD DECK) VOLT PAPER TOWEL RECEPTACLE EXISTING PARTITIONS TO BE DEMOLISHED BURLINGAME, CA VERTICAL HOSE BIBB VESTIBULE HOLLOW CORE EXISTING PARTITIONS TO REMAIN HEADER RAD. R.D. RDWD. REF. RADIUS ROOF DRAIN HARDWILL 1534 PLAZA LN. #318 HARDWARE REDWOOD HEIGHT BURLINGAME, CA 94010 HOLLOW METAL **GENERAL SYMBOLS** WATER CLOSET PHONE: (650) 235-9566, FAX: (650) 235-9596 CONTACT: AUDREY TSE OR LAUREN LEE WATER HEATER REINFORCED H.V.A.C. HEATING, VENTILATING WITHOUT REQUIRED STRUCTURAL ENGINEER AND AIR CONDITIONING WATERPROOF RESILIEN1 HOT WATER WATER RESISTANT SUNG ENGINEERING, INC REVISED, REVISION WEIGHT 29300 KOHOUTEK WAY, SUITE #190 CUT OR WINDOW OF DETAIL ROUGH OPENING YD. YARD UNION CITY, CA 94587 - SHEET DETAIL IS DRAWN ON PHONE/FAX: 510-475-7900/510-475-7913 INTERIOR **DETAIL REFERENCE:** CONTACT: PETER SUNG JANITOR - SECTION NUMBER TITLE 24 AND GREEN BUILDING JDINT JIM BLOMQUIST, CERTIFIED ENERGY KIT. KITCHEN - DIRECTION OF CUT ANALYST CEPE CEA 41C HANGAR WAY - SHEET SECTION IS DRAWN ON WATSONVILLE, CA 95076 SECTION REFERENCE CONSTRUCTION HOURS PHONE: 408-310-0081 - DIRECTION AND LETTER OF ELEVATION CONTACT: JIM BLOMQUIST NO PERSON SHALL ERECT (INCLUDING EXCAVATION AND GRADING), DEMOLISH, - SHEET ELEVATIONS ARE DRAWN ON ALTER OR REPAIR ANY BUILDING OR STRUCTURE OTHER THAN BETWEEN THE INTERIOR ELEVATIONS FOLLOWING HOURS EXCEPT IN THE CASE OR URGENT NECESSITY IN THE INTEREST OF PUBLIC HEALTH AND SAFETY, AND THEN ONLY WITH PRIOR WRITTEN - DOOR AND WINDOW NUMBER APPROVAL FROM THE BUILDING OFFICIAL, WHICH APPROVAL SHALL BE GRANTED SEE DOOR AND WINDOW SCHEDULE FOR ADDITIONAL FOR A PERIOD OF 3 DAYS. NO WORK ON SUNDAYS OR HOLIDAYS. HOLIDAYS ARE INFORMATION THE 1ST DAY OF JANUARY, 3RD MONDAY OF FEBRUARY, LAST MONDAY OF MAY, 4TH DAY OF JULY, 1ST MONDAY OF SEPTEMBER, 11TH DAY OF NOVEMBER, 4TH 2019 CALIFORNIA BUILDING CODE DOOR NUMBER THURSDAY OF NOVEMBER, OR 25TH DAY OF DECEMBER. IF 1ST DAY OF JANUARY 4TH DAY OF JULY. 11TH DAY OF NOVEMBER OR 25TH DAY OF DECEMBER FALLS - INFORMATION WITHIN HAS BEEN REVISED. 2019 CALIFORNIA PLUMBING CODE UPON A SUNDAY THE FOLLOWING MONDAY IS A HOLIDAY. SEE TITLE BLOCK FOR REVISION NUMBER **CONSTRUCTION HOURS -**2019 CALIFORNIA ENERGY CODE MONDAY - FRIDAY: 8:00AM - 7:00PM 2019 CALIFORNIA FIRE CODE SATURDAYS: 9:00AM - 6:00PM REVISION **GENERAL NOTES** BY THE STATE OF CALIFORNIA 1. ANY HIDDEN CONDITIONS THAT REQUIRE WORK TO BE PERFORMED BEYOND SCOPE OF THE BUILDING PERMIT ISSUED FOR THESE PLANS MAY REQUIRE FURTHER CITY APPROVALS INCLUDING REVIEW BY THE PLANNING COMMISSION. 2. A GRADING PERMIT, IF REQUIRED, WILL BE OBTAINED FROM THE **LOCATION MAP** DEPARTMENT OF PUBLIC WORKS. 3. COMPLY WITH SB 407 - ALL NON-COMPLIANT PLUMBING FIXTURES TO BE REPLACED BY WATER-CONSERVING PLUMBING FIXTURES. 4. A MINIMUM OF 65% OF CONSTRUCTION WASTE TO BE RECYCLED OR SALVAGED CALGREEN 4.408.1 SECOND FLOOR ADDITION -PRIMARY SUITE, BEDROOM, BATHROOM

PRAKASH -**RAO** RESIDENCE

2836 MARIPOSA DR. **BURLINGAME**, CA

[inSite]

architecture design interiors

1534 PLAZA LN. #318 BURLINGAME, CA 94010 235-9566 tel.

DESIGN REVIEW 6/1/22

A DESIGN REVIEW COMMENTS

7/25/22

CODE DATA

THESE PLANS ARE TO COMPLY TO THE FOLLOWING CODES, ORDINANCES, RULES AND REGULATIONS:

2019 CALIFORNIA ELECTRICAL CODE 2019 CALIFORNIA MECHANICAL CODE 2019 CALIFORNIA GREEN BUILDING STANDARDS CODE

2019 CALIFORNIA EXISTING BUILDING CODE 2019 CALIFORNIA RESIDENTIAL CODE 2018 IBC, UMC, UPC AND 2017 NEC, AS AMENDED

ALL OTHER STATE, MUNICIPAL & LOCAL ORDINANCES, CODES, RULES & REGULATIONS, AS APPLICABLE



Jehovah's Witnesses


PROJECT DESCRIPTION

FIRST FLOOR REMODEL AND ADDITION KITCHEN, FAMILY ROOM, DINING AREA, LIVING ROOM, LAUNDRY,

ADDITION OF INTERIOR STAIR TO 2ND FLOOR ADDITION

FIRE SPRINKLER NOTES


- . PROVIDE A FIRE SPRINKLER SYSTEM THROUGHOUT MAIN HOUSE AND ADU. FIRE SPRINKLER PLANS SHALL BE SUBMITTED THROUGH FIRE DEPARTMENT FOR APPROVAL PRIOR TO INSTALLATION.
- 2. SEE SITE PLAN FOR SCHEMATIC LINE DIAGRAM
- 3. PROVIDE A BACKFLOW PREVENTION DEVICE; USC APPROVED DOUBLE CHECK VAVLE ASSEMBLY. GENERAL CONTRACTOR SHALL ENSURE THE DOUBLE CHECK VALVE FOR FIRE PROTECTION SHALL BE TESTED AND APPROVED BY A SAN MATEO COUNTY ENVIRONMENTAL HEALTH APPROVED CONTRACTOR PRIOR TO SCHEDULING WATER DEPARTMENT FINAL INSPECTION.
- 4. MINIMUM WATER METER SIZE SHALL ACCOMODATE BOTH DOMESTIC AND FIRE SPRINKLER SYSTEM DEMAND TOTALS.
- 5. FIRE FLOW SHALL MEET REQUIREMENTS OF CALIFORNIA FIRE CODE APPENDIX B. FIRE FLOW FOR RESIDENTIAL BUILDINGS LESS THAN 3600 SQFT SHALL BE PROVIDED AT 1000 GPM UNLESS PROTECTED BY AN AUTOMATIC RESIDENTIAL FIRE SPRINKLER SYSTEM. THEN IT MAY BE REDUCED BY 50%. CONTACT BURLINGAME ENGINEÉRING DEPARTMENT.

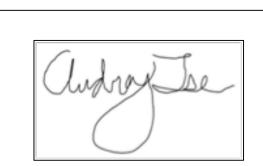


SHEET TITLE TITLE SHEET

PROJECT #: 2021-D DRAWN BY: LL SCALE: N/A

DRAWING NUMBER

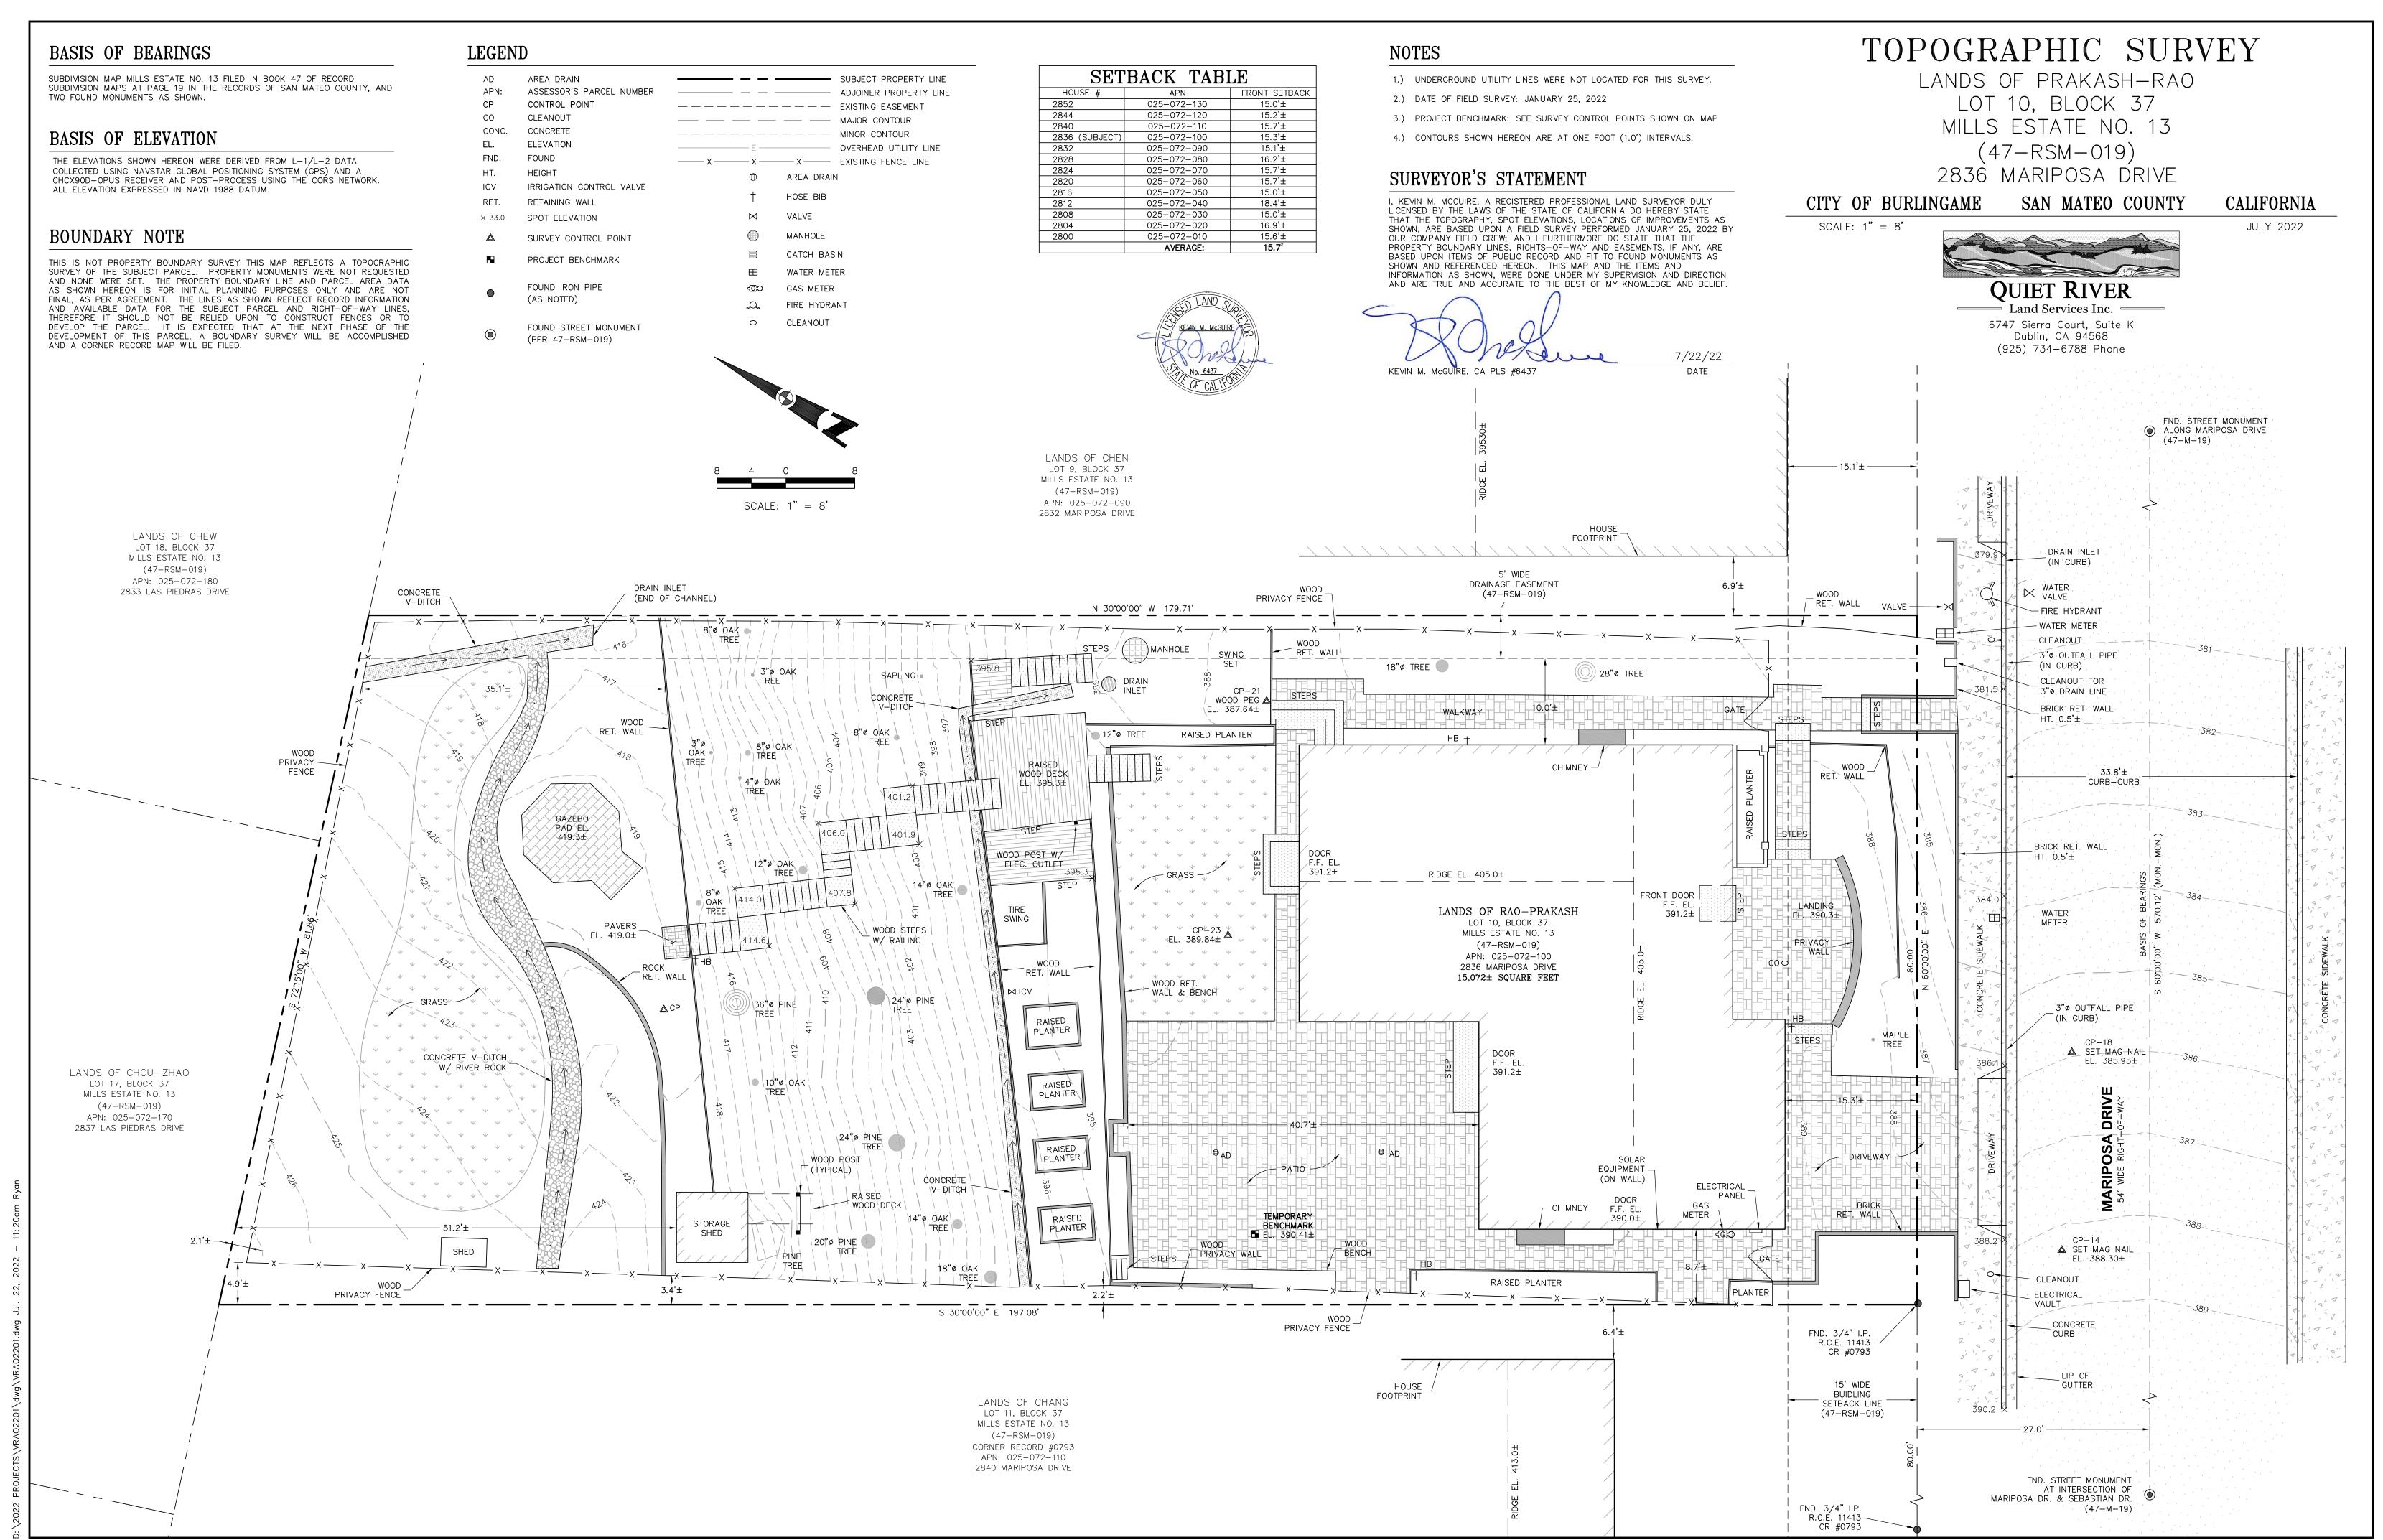

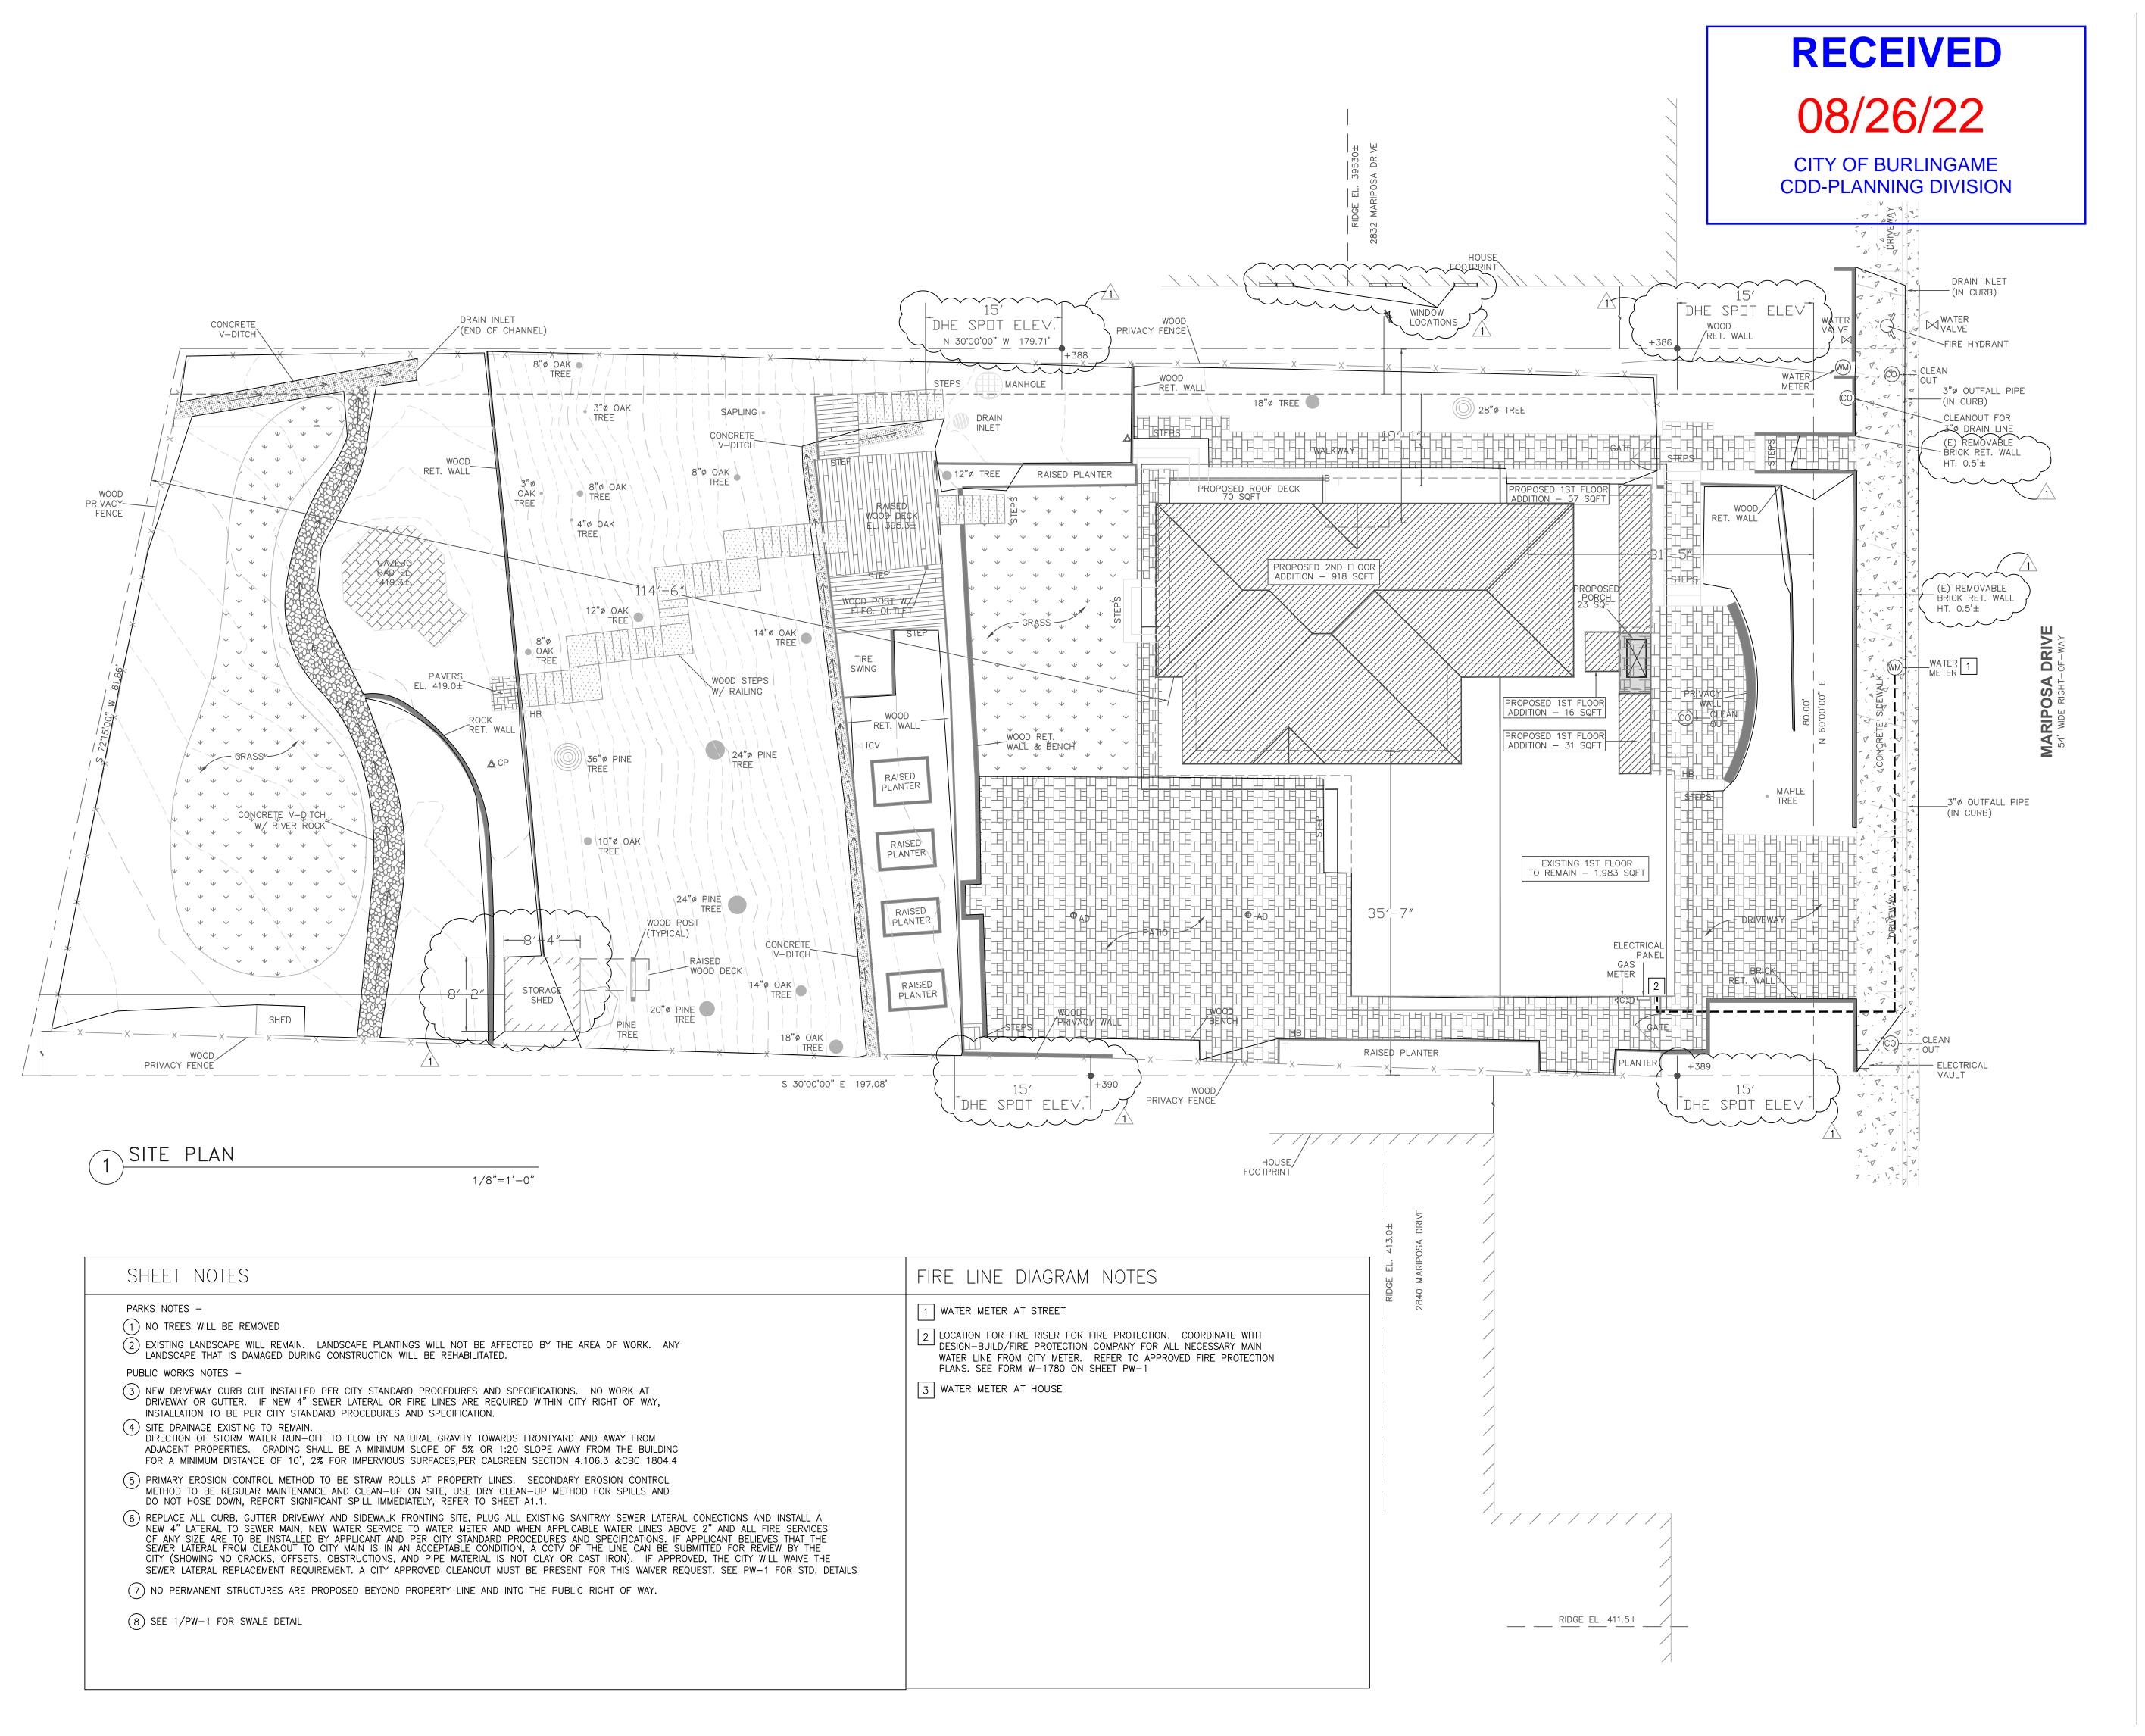

PRAKASH -RAO RESIDENCE

2836 MARIPOSA DR. BURLINGAME, CA

[inSite]

architecture design interiors

1534 PLAZA LN. #318 BURLINGAME, CA 94010 (650) 235-9566 tel. (650) 235-9569 fax

DESIGN REVIEW COMMENTS

7/25/22


SHEET TITLE SITE PLAN

PROJECT #: 2021-D
DRAWN BY: LL
DATE: 5/5/22

SCALE: 1/8" = 1'-0"

DRAWING NUMBER

A1.1

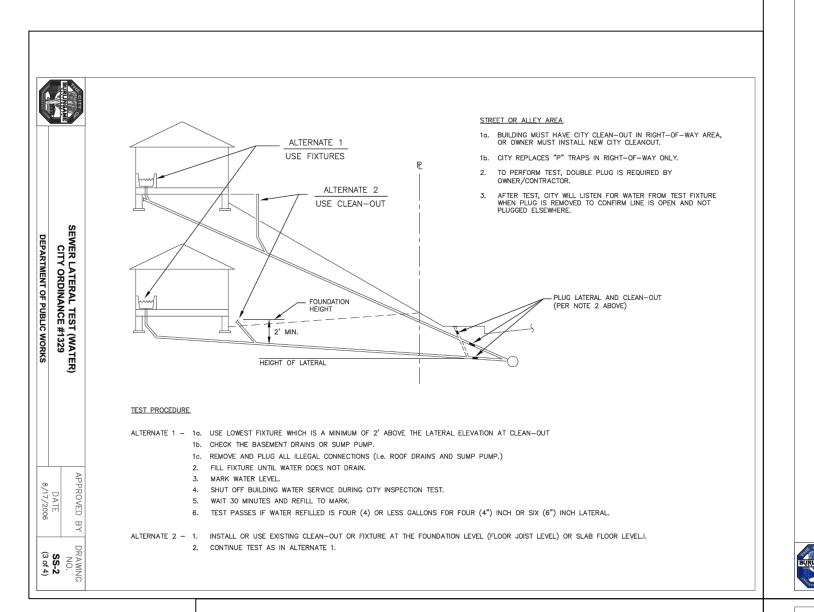

PRIVATE SEWER LATERAL AND TESTING PROCEDURE AND REQUIREMENTS

ORDINANCE NO. 1329, WHICH WAS ADOPTED JULY 7, 1986 AND BECAME EFFECTIVE AUGUST 7, 1986 AND WAS MODIFIED BY ORDINANCE 1623 ON MARCH 23, 2000, REQUIRES THE ABATEMENT OF SEWER LATERALS AND CLEANOUTS WHICH ARE FOUND TO CONTAIN LEAKS OR SEPARATIONS; LATERALS COVERED ARE FROM THE BUILDING SERVED TO THE CLEANOUT IN THE CITY RIGHT-OF-WAY. THE ORDINANCE ALSO REQUIRES THE TESTING AND REPAIR OF LATERALS PRIOR TO THE SALE OF THE PROPERTY IF THE BUILDING WAS CONSTRUCTED 25 YEARS OR MORE BEFORE THE DATE OF SALE. DATE OF CONSTRUCTION SHALL BE THE DATE THE BUILDING PERMIT WAS FINALED. IN ADDITION, TESTING IS REQUIRED IF TWO (2) OR MORE PLUMBING FIXTURE UNITS ARE ADDED TO A PROPERTY. THE FOLLOWING PROCEDURES AND REQUIREMENTS ARE ADOPTED TO IMPLEMENT ORDINANCE NO. 1329.

IT SHALL BE THE OWNER'S RESPONSIBILITY TO DETERMINE IF TESTING IS NEEDED. CONTACT THE BUILDING DEPARTMENT TO DETERMINE THE AGE OF THE STRUCTURE AND IF THE LATERAL HAD BEEN TESTED AND/OR REPAIRED WITHIN THE PAST TEN (10) YEARS. IT CAN BE ASSUMED THAT TESTING AND REPAIRS HAVE NOT BEEN DONE UNLESS THE PROPERTY HAS BEEN ALTERED OR SOLD AFTER AUGUST 1986. IF THE LATERAL NEEDS TESTING, THE PROPERTY OWNER SHOULD RETAIN A CONTRACTOR OR PLUMBER TO PERFORM THE TEST. THE TEST SHALL BE PERFORMED AS FOLLOWS:

- 1. THE TEST MUST BE WITNESSED BY A CITY REPRESENTATIVE TO MEET THE ORDINANCE REQUIREMENTS. THE CONTRACTOR OR OWNER SHALL FIRST OBTAIN AN ENCROACHMENT PERMIT FROM THE PUBLIC WORKS DEPARTMENT IN CITY HALL AND PAY AN ENCROACHMENT PERMIT FEE PER THE LATEST ENCROACHMENT PERMIT FEE SCHEDULE. OBTAINING THE PERMIT CAN BE DONE BEFORE OR CONCURRENTLY WITH SCHEDULING AN APPOINTMENT BUT IS REQUIRED AT THE TIME OF THE TEST. ALL ARRANGEMENTS AND SET UP SHOULD BE COMPLETED BY THE TIME THE CITY REPRESENTATIVE ARRIVES TO WITNESS THE TEST. CALL 650—558—7670 TO SCHEDULE AN APPOINTMENT.
- 2. EACH LATERAL IS TO HAVE A CLEANOUT LOCATED IN THE CITY RIGHT—OF—WAY. IF A CLEAN OUT DOES NOT EXIST THEN ONE WILL BE REQUIRED TO BE INSTALLED. THE OWNER'S CONTRACTOR WILL INSTALL THE CLEANOUT WITH AN ENCROACHMENT PERMIT FROM THE PUBLIC WORKS DEPARTMENT. CITY PERSONNEL CAN SPEND A LIMITED AMOUNT OF TIME TO ASSIST IN LOCATING AN EXISTING CLEANOUT OR LATERAL. A CLEANOUT LOCATED ADJACENT TO THE BUILDING WILL BE AN AID IN THE TESTING PROCESS OR LOCATING THE PIPE ROUTE FOR REPAIRS AND IS NOW REQUIRED IN THE UNIFORM PLUMBING CODE. A PLUMBING PERMIT FROM THE BUILDING DEPARTMENT IS REQUIRED FOR THE CLEANOUT ADJACENT TO THE BUILDING OR ANY WORK DONE ON PRIVATE PROPERTY.
- 3. TESTING WILL BE ACCOMPLISHED BY EITHER A WATER EXFILTRATION TEST OR AN AIR TEST.
 THE AIR TEST SHALL BE USED IN HILLSIDE AREAS WHERE THE HYDRAULIC HEAD PRESSURES
 COULD DAMAGE THE PIPE.
- A. WATER EXFILTRATION TEST. THE CONTRACTOR SHALL FURNISH ALL MATERIALS AND EQUIPMENT, EXCEPT THE CALIBRATED BUCKET. THE CONTRACTOR SHALL PLUG THE LATERAL AND RISER AT THE CITY CLEANOUT AND THEN SURCHARGE THE LINE WITH WATER TO A POINT EQUAL TO THE FOUNDATION'S GRADE (FLOOR JOIST LEVEL) OR CONCRETE SLAB, DEPENDING ON CONSTRUCTION. THE MINIMUM HEIGHT OF THE WATER LEVEL SHALL BE TWO FEET (2'-0") ABOVE THE FLOWLINE OF THE LATERAL AT THE CITY CLEANOUT. IF THERE IS ANY FIXTURE INSIDE THE STRUCTURE LOWER THAN THE TESTING WATER LEVEL, THE CONTRACTOR SHALL HAVE TO EITHER PLUG THE FIXTURE OR THE LATERAL AT THE BUILDING. AN APPROVED BACKWATER VALVE SHALL BE INSTALLED IF THERE ARE ANY PLUMBING FIXTURES BELOW THE LEVEL OF THE CITY CLEANOUT. A PLUMBING PERMIT IS REQUIRED FOR THIS WORK. THE CONTRACTOR MAY ALSO INSTALL OR USE AN EXISTING CLEANOUT NEAR THE STRUCTURE AT THE FOUNDATION GRADE (FLOOR JOIST LEVEL) OR CONCRETE SLAB FLOOR LEVEL TO ESTABLISH THE MINIMUM TWO FEET (2'-0") WATER LEVEL.
- THE LATERAL SHALL REMAIN SURCHARGED FOR A PERIOD OF 30 MINUTES AND THE AMOUNT OF WATER LOST SHALL BE MEASURED. THE LATERAL SHALL BE CONSIDERED ACCEPTABLE IF THE AMOUNT OF WATER LOST IS LESS THAN FOUR (4) GALLONS. NO INCREASE OR ALLOWANCE IS ALLOWED FOR LONG LATERALS OR FOR LATERALS LARGER THAN THE 4—INCH MINIMUM SIZE. SEE STANDARD DRAWING SS—2 (3 OF 5).

PRIVATE SEWER LATERAL AND TESTING


PROCEDURE AND REQUIREMENTS

DEPARTMENT OF PUBLIC WORKS

APPROVED BY DRAWING

DATE SS-2

8/17/2006 (1 of 4)

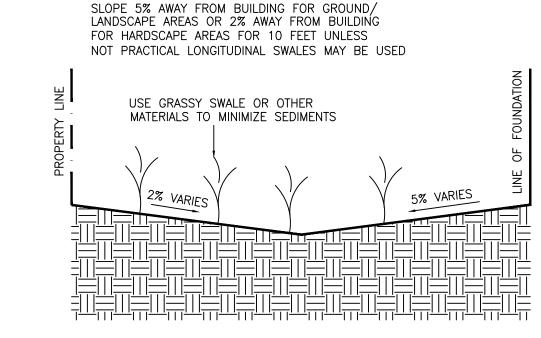

ALL BACKFLOW PREVENTION ASSEMBLIES MUST BE APPROVED BY THE UNIVERSITY OF SOUTHERN CALIFORNIA (USC) AND TESTED BY A SAN MATEO COUNTY CERTIFIED TESTER BEFORE APPROVAL

OF THE WATER SYSTEM. SEE THE SAN MATEO COUNTY WEB SITE FOR APPROVED LIST OF

SIZE. THE WORKSHEET IS AVAILABLE AT THE BUILDING DEPARTMENT OR ON THE CITY OF

CERTIFIED TESTER'S AT HTTP://SMCHEALTH.ORG/NODE/426. FOR ADDITIONAL INFORMATION ON USC APPROVED DEVICES PLEASE CALL THE WATER DIVISION AT (650) 558-7670. PLEASE COMPLETE THE "WATER DEMAND WORKSHEET" FOR DETERMINING THE WATER SERVICE AND METER

1 EARTHEN SWALE DETAIL

BURLINGAME WEB SITE AT HTTP://WWW.BURLINGAME.ORG/INDEX.ASPX?PAGE=125.

HOSE BIB WITH

PRESSURE REDUCING VALVE (IF NEEDED)

(AT RESIDENCE)

HOUSE VALVE ---

WATER METER SIZE:

TYPICAL RESIDENTIAL WATER SERVICE DETAIL

(WITH FIRE SYSTEM)

1. REMOVE DOUBLE CHECK VALVE HANDLES AND STORE IN SPARE HEAD BOX

PLAN VIEW

CONCRETE BLOCK & GRINNEL PIPE SUPPORT (FOR —

CONCRETE THRUST BLOCK (SEE STANDARD DETAIL W-1810 FOR DETAILS)

4" & LARGER VALVES)

 CONTROL VALVE TAMPER MONITORING SHALL BE PER REQUIREMENTS DETERMINED BY THE FIRE DEPARTMENT.

LINDERGROUND FIRE SERVICE

DOUBLE CHECK DETECTOR (ABOVE GRADE)

DEPARTMENT OF PUBLIC WORKS

a. NEW FIRE SPRINKLER SYSTEMS MUST BE ELECTRONICALLY MONITORED.
 b. EXISTING FIRE SPRINKLER SYSTEMS REQUIRE CONTROL VALVES TO BE CHAINED AND LOCKED IN OPEN POSITION, ELECTRONICALLY MONITORED, OR AS DIRECTED BY THE FIRE

VACUUM BREAKER

ADDRESS:

CITY PRESSURE

RESPONSIBILITY PROPERTY OWNER'S
AFTER RESPONSIBILITY AFTER
CONSTRUCTION CONSTRUCTION

SEE NOTES FOR -CONTROL VALVE REQUIREMENTS

WATER MAIN

[inSite]

PRAKASH -

RESIDENCE

2836 MARIPOSA DR.

BURLINGAME, CA

RAO

architecture design interiors

1534 PLAZA LN. #318 BURLINGAME, CA 94010 (650) 235-9566 tel.

DESIGN	REVIEW	6/1/22

FEB 2022 W-1780
NONE 1 OF 1

- APPLICANT AND INSTALLED BY CITY

APPROVED BY DRAWING

DATE W-2780 02/04/2020 (1 of 2)

TO IRRIGATION SYSTEM

TO FIRE SYSTEM

BACKFLOW PREVENTION

ASSEMBLY

BACKFLOW PREVENTION

TYPE: DOUBLE CHECK BRAND:

ASSEMBLY

MODEL#:_

FIRE PLANS SUPERSEDES

THIS SERVICE MATERIAL TYPE:_

TYPE:


SEE NOTE T

SHEET TITLE
PUBLIC WORKS
STANDARD DETAILS

PROJECT #: 2022-D
DRAWN BY: LL
DATE: 4/20/22
SCALE: N/A

DRAWING NUMBER

PW.1

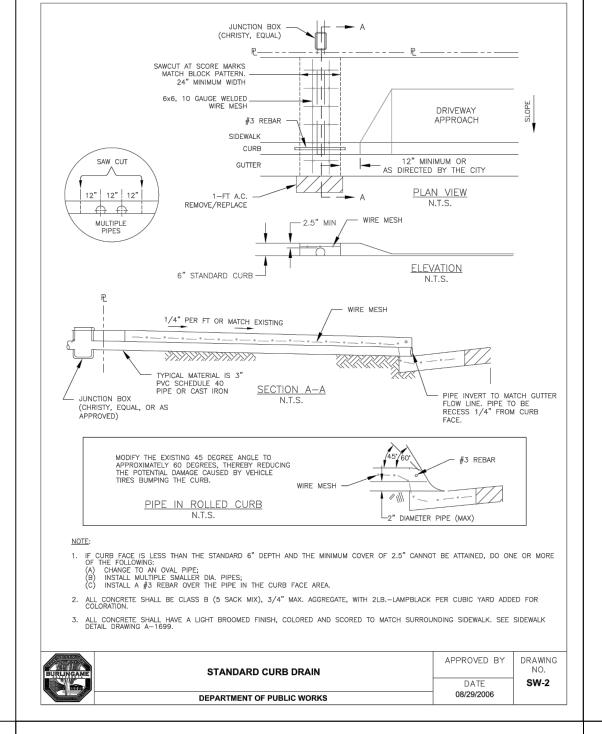

FACE OF CURB

SEE NOTE 18

DRIVEWAY (DETACHED) PLAN VIEW N.T.S.

SIDEWALK (5' WIDE OR AS DIRECTED BY CITY ENGINEER)

→ 3" - SEE NOTE 14

APPROVED BY DRAWING

8/9/2017 (1 of 3)

SW-1

DATE

#4 x12" DOWELS

WPJ 50'-0" MAX

SOIL OR ENGINEERED FILL, COMPACTED TO 90% RELATIVE COMPACTION

(SEE NOTES ON SHEET 3 OF 3)

10/03/2006 (1 of 6)

SOIL OR ENGINEERED FILL, COMPACTED TO 95% RELATIVE COMPACTION

SIDEWALK DETAIL, DRIVEWAY, CURB AND GUTTER

DEPARTMENT OF PUBLIC WORKS

B. AIR TEST. THE CONTRACTOR SHALL FURNISH ALL MATERIALS, EQUIPMENT AND LABOR FOR MAKING THE TEST, EXCEPT THE PRESSURE TEST GAUGE. AIR TEST EQUIPMENT SHALL BE APPROVED BY THE CITY. THE CONTRACTOR SHALL CLEAN PIPE AND PLUG THE LATERAL AT THE BUILDING LINE AND THE CITY CLEANOUT. (IF A CLEANOUT IS WITHIN TWO FEET (2'-0") OF THE BUILDING, THE LATERAL MAY BE PLUGGED AT THE CLEANOUT.)

THE LEAKAGE TEST OF THE LATERAL SHALL BE CONDUCTED IN THE PRESENCE OF THE CITY IN THE FOLLOWING MANNER:

AIR SHALL BE SLOWLY SUPPLIED TO THE PLUGGED LATERAL UNTIL THE INTERNAL AIR


AIR SHALL BE SLOWLY SUPPLIED TO THE PLUGGED LATERAL UNTIL THE INTERNAL AIR PRESSURE REACHES 4.0 POUNDS PER SQUARE INCH GREATER THAN THE AVERAGE BACK PRESSURE OF ANY GROUNDWATER THAT MAY SUBMERGE THE PIPE. THE AIR PRESSURE SHALL BE REGULATED BY A SUITABLE REGULATOR VALVE.

AT LEAST TWO MINUTES SHALL BE ALLOWED FOR TEMPERATURE STABILIZATION BEFORE PROCEEDING FURTHER. THE RATE OF AIR LOSS SHALL THEN BE DETERMINED BY MEASURING THE TIME INTERVAL FOR THE INTERNAL PRESSURE TO DECREASE FROM 3.5 TO 2.5 POUNDS PER SQUARE INCH GREATER THAN THE AVERAGE BACK PRESSURE OF ANY GROUNDWATER THAT MAY SUBMERGE THE PIPE.

THE LATERAL SHALL BE CONSIDERED ACCEPTABLE IF THE TIME INTERVAL MEASURED FOR THE INTERNAL PRESSURE TO DROP FROM 3.5 TO 2.5 POUNDS PER SQUARE INCH IS 10 SECONDS OR GREATER. SEE STANDARD DRAWING SS-2 (4 OF 5).


- 4. IF THE LATERAL PASSES THE TEST, IT SHALL BE CERTIFIED AS ACCEPTABLE AND THE SALE CAN TAKE PLACE WITHOUT ANY FURTHER ACTION. THE CERTIFICATION SHALL BE PLACED IN THE BUILDING DEPARTMENT FILE. THIS CERTIFICATION SHALL BE EFFECTIVE FOR TEN (10) YEARS.


 IF THE LATERAL FAILS THE TEST, THE LATERAL SHALL BE EITHER REPAIRED OR REPLACED AND RETESTED UNTIL THE LATERAL PASSES. THERE WILL BE NO ADDITIONAL FEE FOR RETEST ON REPAIRED OR REPLACED PIPING A PLUMBING PERMIT WILL BE REQUIRED FOR ANY REPAIRS OR REPLACEMENT, AN ENCROACHMENT PERMIT MAY ALSO BE REQUIRED DEPENDING ON THE LOCATION OF THE REPAIR. A COMPLETE REPLACEMENT FROM BUILDING TO CITY CLEANOUT IS EFFECTIVE FOR 25 YEARS. A REPAIRED AND TESTED LATERAL IS EFFECTIVE FOR TEN (10) YEARS.
- 5. THE CITY NEITHER HAS NOR WILL MAKE ANY DETERMINATION AS TO WHO WILL PAY FOR THE TESTING AND REPAIRING. THAT IS TO BE DECIDED BETWEEN THE PARTIES INVOLVED IN THE SALE.

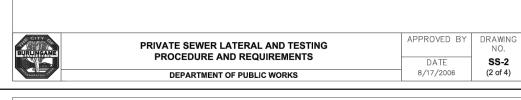

SEWER LATERAL TEST (AIR)
CITY ORDINANCE #1329
DEPARTMENT OF PUBLIC WORKS

APPROVED BY NO.
SNO.
SS-2
(4 of 4)

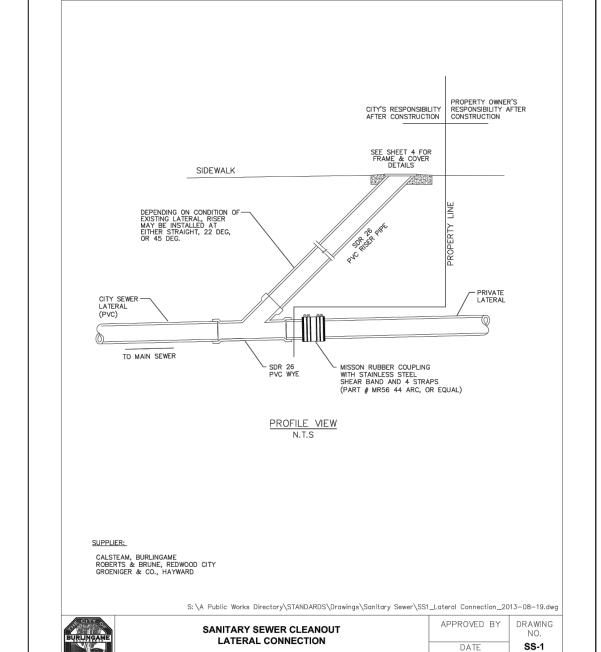

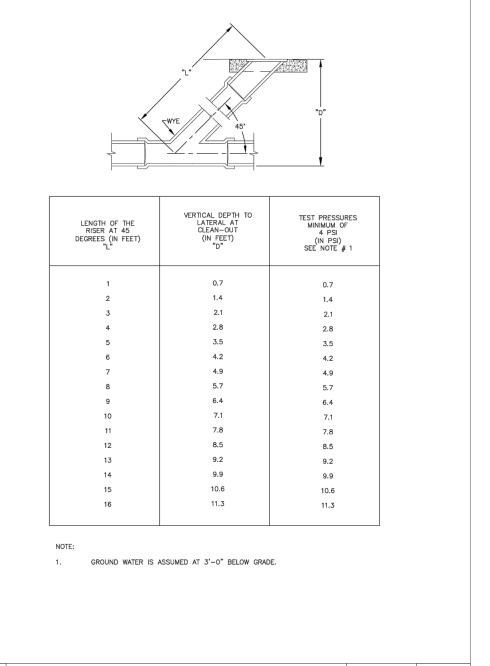




Construction Best Management Practices (BMPs)

Construction projects are required to implement the stormwater best management practices (BMP) on this page, as they apply to your project, all year long.

Clean Water. Healthy Community.

Materials & Waste Management

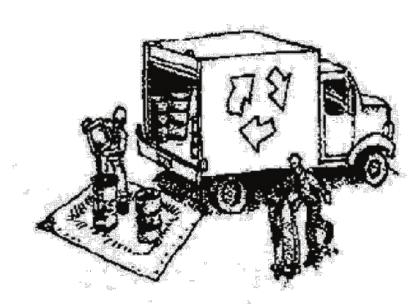

Non-Hazardous Materials

- ☐ Berm and cover stockpiles of sand, dirt or other construction material with tarps when rain is forecast or if not actively being used within
- ☐ Use (but don't overuse) reclaimed water for dust control.

Hazardous Materials

- ☐ Label all hazardous materials and hazardous wastes (such as pesticides, paints, thinners, solvents, fuel, oil, and antifreeze) in accordance with city, county, state and federal regulations.
- ☐ Store hazardous materials and wastes in water tight containers, store in appropriate secondary containment, and cover them at the end of every work day or during wet weather or when rain is forecast.
- ☐ Follow manufacturer's application instructions for hazardous materials and be careful not to use more than necessary. Do not apply chemicals outdoors when rain is forecast within 24 hours.
- ☐ Arrange for appropriate disposal of all hazardous wastes.

Waste Management

- ☐ Cover waste disposal containers securely with tarps at the end of every work day and during wet weather.
- ☐ Check waste disposal containers frequently for leaks and to make sure they are not overfilled. Never hose down a dumpster on the construction site.
- ☐ Clean or replace portable toilets, and inspect them frequently for leaks and spills.
- ☐ Dispose of all wastes and debris properly. Recycle materials and wastes that can be recycled (such as asphalt, concrete, aggregate base materials, wood, gyp board, pipe, etc.)
- ☐ Dispose of liquid residues from paints, thinners, solvents, glues, and cleaning fluids as hazardous waste.

Construction Entrances and Perimeter

- ☐ Establish and maintain effective perimeter controls and stabilize all construction entrances and exits to sufficiently control erosion and sediment discharges from site and tracking off site.
- ☐ Sweep or vacuum any street tracking immediately and secure sediment source to prevent further tracking. Never hose down streets to clean up tracking.

Equipment Management & Spill Control




Maintenance and Parking

- ☐ Designate an area, fitted with appropriate BMPs, for vehicle and equipment parking and storage.
- ☐ Perform major maintenance, repair jobs, and vehicle and equipment washing off site.
- ☐ If refueling or vehicle maintenance must be done onsite, work in a bermed area away from storm drains and over a drip pan or drop cloths big enough to collect fluids. Recycle or dispose of fluids as hazardous waste.
- ☐ If vehicle or equipment cleaning must be done onsite, clean with water only in a bermed area that will not allow rinse water to run into gutters, streets, storm drains, or surface waters.
- ☐ Do not clean vehicle or equipment onsite using soaps, solvents, degreasers, or steam cleaning equipment.

Spill Prevention and Control

- ☐ Keep spill cleanup materials (e.g., rags, absorbents and cat litter) available at the construction site at all times.
- ☐ Inspect vehicles and equipment frequently for and repair leaks promptly. Use drip pans to catch leaks until repairs are made.
- ☐ Clean up spills or leaks immediately and dispose of cleanup materials properly.
- ☐ Do not hose down surfaces where fluids have spilled. Use dry cleanup methods (absorbent materials, cat litter, and/or rags).
- ☐ Sweep up spilled dry materials immediately. Do not try to wash them away with water, or bury them.
- ☐ Clean up spills on dirt areas by digging up and properly disposing of contaminated soil.
- ☐ Report significant spills immediately. You are required by law to report all significant releases of hazardous materials, including oil. To report a spill: 1) Dial 911 or your local emergency response number, 2) Call the Governor's Office of Emergency Services Warning Center, (800) 852-7550 (24 hours).

Earthmoving

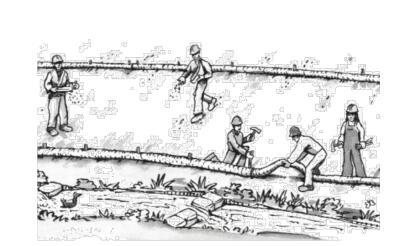


- ☐ Schedule grading and excavation work during dry weather.
- ☐ Stabilize all denuded areas, install and maintain temporary erosion controls (such as erosion control fabric or bonded fiber matrix) until vegetation is established.
- ☐ Remove existing vegetation only when absolutely necessary, and seed or plant vegetation for erosion control on slopes or where construction is not immediately
- ☐ Prevent sediment from migrating offsite and protect storm drain inlets, gutters, ditches, and drainage courses by installing and maintaining appropriate BMPs, such as fiber rolls, silt fences, sediment basins, gravel bags, berms, etc.
- ☐ Keep excavated soil on site and transfer it to dump trucks on site, not in the streets.

Contaminated Soils

- ☐ If any of the following conditions are observed, test for contamination and contact the Regional Water Quality Control Board:
- Unusual soil conditions, discoloration, or odor.
- Abandoned underground tanks.
 - Abandoned wells
 - Buried barrels, debris, or trash.

Paving/Asphalt Work

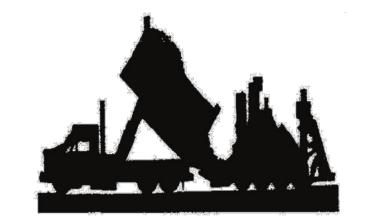


- ☐ Store concrete, grout, and mortar away Avoid paving and seal coating in wet weather or when rain is forecast, to prevent materials that have not cured from contacting stormwater runoff.
- ☐ Cover storm drain inlets and manholes when applying seal coat, tack coat, slurry seal, fog seal, etc.
- ☐ Collect and recycle or appropriately dispose of excess abrasive gravel or sand. Do NOT sweep or wash it into gutters.
- ☐ Do not use water to wash down fresh asphalt concrete pavement.

Sawcutting & Asphalt/Concrete Removal


- ☐ Protect nearby storm drain inlets when saw cutting. Use filter fabric, catch basin inlet filters, or gravel bags to keep slurry out of the storm drain system.
- ☐ Shovel, abosorb, or vacuum saw-cut slurry and dispose of all waste as soon as you are finished in one location or at the end of each work day (whichever is sooner!).
- ☐ If sawcut slurry enters a catch basin, clean it up immediately.

Painting & Paint Removal

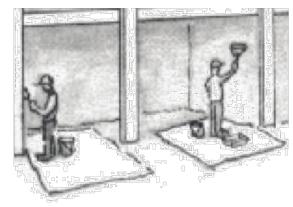

Painting Cleanup and Removal

- ☐ Never clean brushes or rinse paint containers into a street, gutter, storm
- ☐ For water-based paints, paint out brushes to the extent possible, and rinse into a drain that goes to the sanitary sewer. Never pour paint down a storm drain.
- ☐ For oil-based paints, paint out brushes to the extent possible and clean with thinner or solvent in a proper container. Filter and reuse thinners and solvents. Dispose of excess liquids as hazardous waste.
- ☐ Paint chips and dust from non-hazardous dry stripping and sand blasting may be swept up or collected in plastic drop cloths and disposed of as trash.
- ☐ Chemical paint stripping residue and chips and dust from marine paints or paints containing lead, mercury, or tributyltin must be disposed of as hazardous waste. Lead based paint removal requires a statecertified contractor.

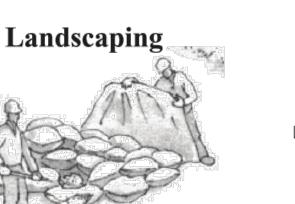

☐ Protect stockpiled landscaping materials from wind and rain by storing them under tarps all year-round.

Concrete, Grout & Mortar

Application

from storm drains or waterways, and on

pallets under cover to protect them from

☐ Wash out concrete equipment/trucks

offsite or in a designated washout

that will prevent leaching into the

☐ When washing exposed aggregate,

and disposed of properly.

area, where the water will flow into a

temporary waste pit, and in a manner

underlying soil or onto surrounding areas.

Let concrete harden and dispose of as

prevent washwater from entering storm

gutters, hose washwater onto dirt areas, or

drain onto a bermed surface to be pumped


drains. Block any inlets and vacuum

rain, runoff, and wind

garbage.

- ☐ Stack bagged material on pallets and
- ☐ Discontinue application of any erodible landscape material within 2 days before a forecast rain event or during wet weather.

Dewatering

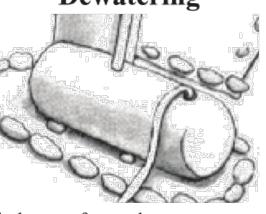

- ☐ Discharges of groundwater or captured runoff from dewatering operations must be properly managed and disposed. When possible send dewatering discharge to landscaped area or sanitary sewer. If discharging to the sanitary sewer call your local wastewater treatment plant.
- ☐ Divert run-on water from offsite away from all disturbed areas.
- ☐ When dewatering, notify and obtain approval from the local municipality before discharging water to a street gutter or storm drain. Filtration or diversion through a basin, tank, or sediment trap may be required.
- ☐ In areas of known or suspected contamination, call your local agency to determine whether the ground water must be tested. Pumped groundwater may need to be collected and hauled off-site for treatment and proper disposal.

Storm drain polluters may be liable for fines of up to \$10,000 per day!

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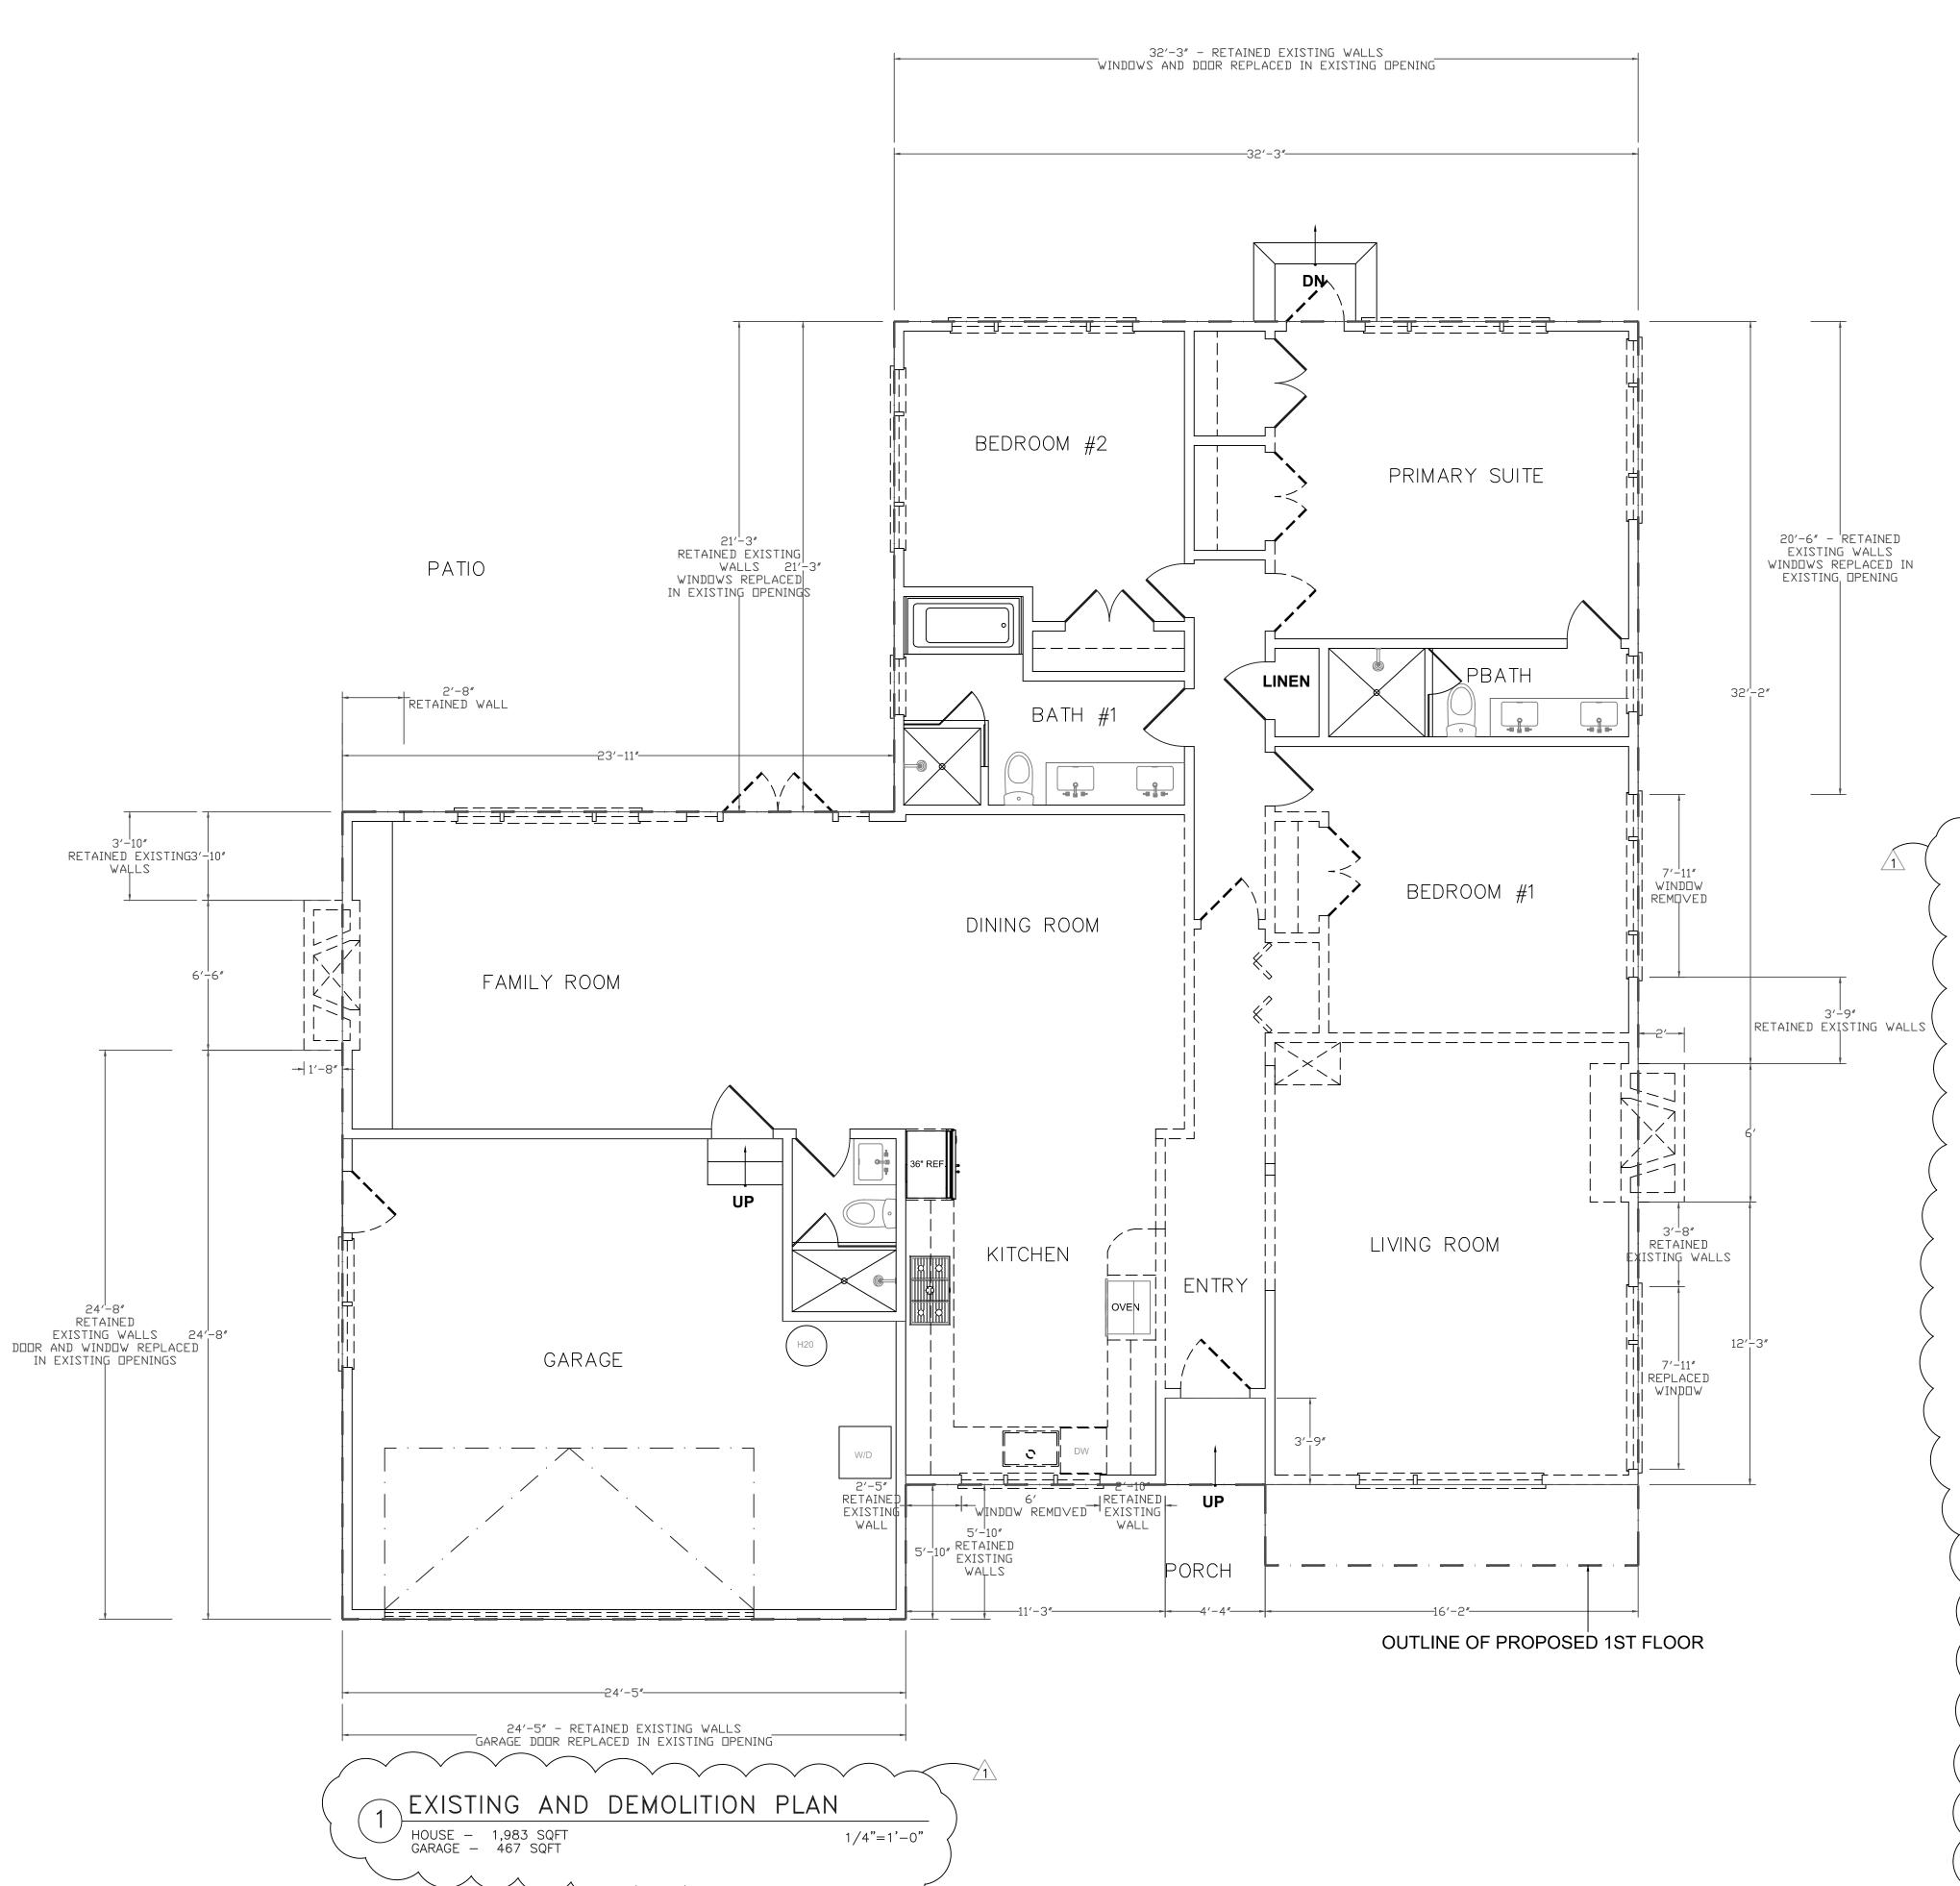
SHEET TITLE

CONSTRUCTION **BEST MANAGEMENT PRACTICES**

PROJECT #: 2021-D DRAWN BY: LL DATE: 5/6/22 SCALE: N/A

DRAWING NUMBER

A1.2



GENERAL/SHEET NOTES

- ALL RUBBISH AND DEMOLITION TO BE HAULED OFF SITE. COMPLY WITH LOCAL WASTE MANAGEMENT PROGRAMS. PERFORM DEMOLITION IN ACCORDANCE WITH APPLICABLE AUTHORITIES HAVING JURISDICTION. REMOVE EXISTING WINDOWS AS APPLICABLE AND PREPARE
- FOR INSTALLATION OF NEW WINDOWS. MODIFY OPENINGS TO ACCOMMODATE NEW ROUGH OPENINGS AS REQUIRED.
- DEMOLISH EXISTING WHERE SHOWN DASHED.
- PATCH AND PAINT EXTERIOR TO MATCH (E) AT (N) WINDOWS AND REPLACEMENT WINDOWS
- PROTECT ALL CONSTRUCTION TO REMAIN FROM DEMOLITION CREW.
- PROTECT ALL EXISTING FINISHES AND ITEMS TO REMAIN, WHERE CONDITIONS TO REMAIN ARE AFFECTED BY DEMOLITION, RELOCATION, NEW CONSTRUCTION, ETC. THE CONTRACTOR SHALL REPAIR, PATCH, REFINISH, OR REPLACE SAID ITEMS AS REQUIRED TO MATCH EXISTING AT NO CHARGE TO THE OWNER.
- ELECTRICIAN TO CAP AND PROVIDE COVER PLATE FOR ALL ELECTRICAL ITEMS TO BE REMOVED. CONSULT OWNER ON COLOR OF PLATE. 1) CONTRACTOR SHALL VERIFY FIELD CONDITIONS AND NOTIFY DESIGNER OF ALL DISCREPANCIES BEFORE PROCEEDING WITH WORK.
- PREVENT MOVEMENT OR SETTLEMENT OF STRUCTURES. PROVIDE AND PLACE BRACING OR SHORING AND BE RESPONSIBLE FOR SAFETY AND SUPPORT OF STRUCTURE, ASSUME LIABILITY FOR SUCH MOVEMENT, SETTLEMENT, DAMAGE OR INJURY.
- CEASE OPERATIONS AND NOTIFY THE OWNER IMMEDIATELY IF SAFETY OF THE STRUCTURE APPEARS TO BE ENDANGERED. TAKE PRECAUTIONS TO PROPERLY SUPPORT STRUCTURE. DO NOT RESUME OPERATIONS UNTIL SAFETY IS RESTORED.
- ARRANGE AND PAY FOR DISCONNECTING, REMOVING AND CAPPING UTILITY SERVICES WITHIN AREAS OF DEMOLITION. DISCONNECT AND STUB OFF. NOTIFY THE EFFECTED UTILITY COMPANY IN ADVANCE AND OBTAIN APPROVAL BEFORE STARTING WORK.
- PLACE MARKERS TO INDICATE LOCATION OF DISCONNECTED SERVICES. IDENTIFY SERVICES LINES AND CAPPING LOCATIONS AN PROJECT RECORD DOCUMENTS.
- EXCEPT WHERE NOTED OTHERWISE, MAINTAIN POSSESSION OF MATERIALS BEING DEMOLISHED. IMMEDIATELY REMOVE FROM SITE.
- DEMOLISH IN A ORDERLY AND CAREFUL MANNER AS REQUIRED TO ACCOMMODATE NEW WORK, INCLUDING THAT REQUIRED FOR CONNECTION TO THE EXISTING BUILDING. PROTECT THE EXISTING FOUNDATIONS AND SUPPORTING STRUCTURAL MEMBERS, PHASE DEMOLITION IN ACCORDANCE WITH CONSTRUCTION SCHEDULE.
- CONTRACTOR TO CAP ALL UNUSED PLUMBING AS REQUIRED TO PREVENT LEAKAGE. RETROFIT EXISTING AS REQUIRED FOR CONNECTION OF NEW PLUMBING

EXISTING WALL INVENTORY

LENGTH O	F EXISTING EXTERIOR WALLS
LENGTH	
32'-3"	
32'-2"	
2'-0"	
6'-0"	
2'-0"	
12'-3"	
16'-2"	
3'-9"	
4'-4"	
3'-9"	
11'-3"	
5'-10"	
24'-5"	
24'-8"	
1'-8"	
6'-6"	
1'-8"	
3'-10"	
23'-11"	
21'-3"	
239'-8"	TOTAL EXISTING EXT. WALLS

LENGTH OF RETAINED EXTERIOR WALLS WINDOWC DEMOVED IN DETAINED WALL

RETAINED EXT. WALLS PERCENTAGE OF EXISTING WALLS RETAINED

126.67'/239.67' = 53%

32'-3"	WINDOWS REMOVED IN RETAINED WALLS		
20'-6"	7'-11"		
3'-9"	7'-11"		
3'-8"	6'-0"		
2'-10"		TOTAL WINDOWS REMOVED	
2'-5"	21'-10"	IN RETAINED WALLS	
5'-10"			
24'-10"			
24'-8"			
3'-10"			
2'-8"			
21-3"			
148'-6"	RETAINED EXT. WALLS		
<21'-10">	MINUS WINDOWS REMOVED IN RETAINED WALLS		

DRAWING NUMBER

A2.0

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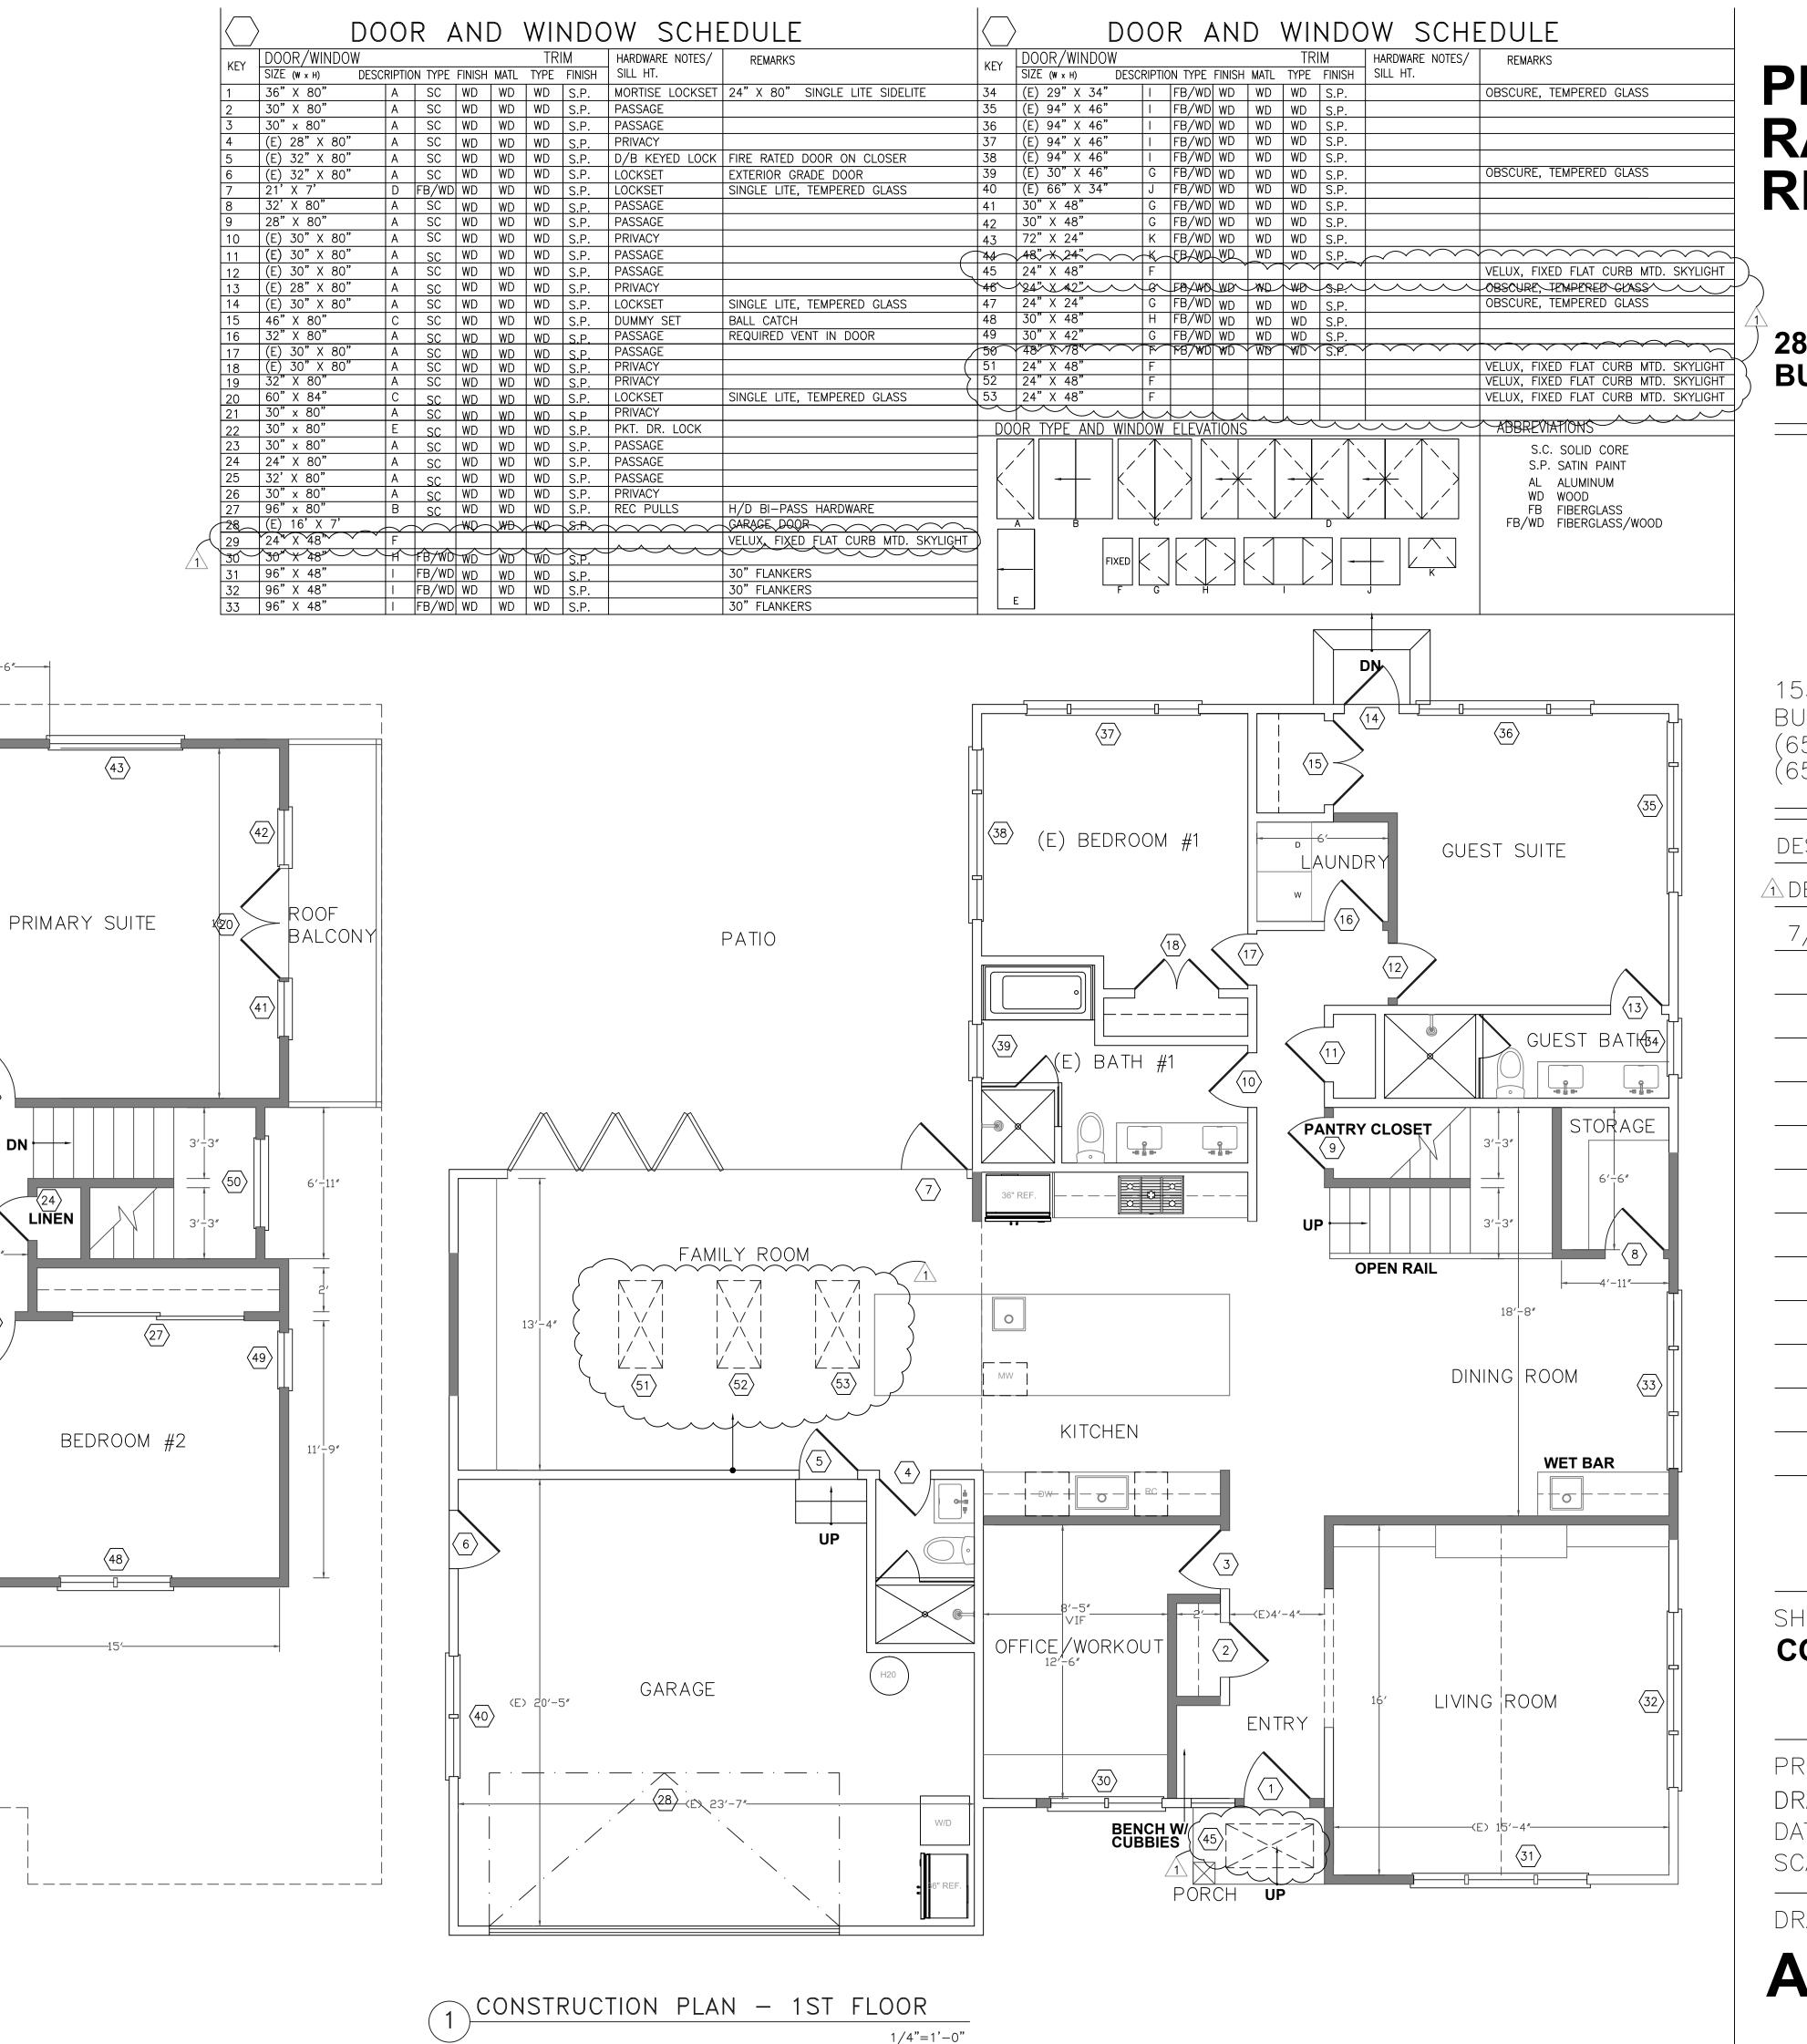
DESIGN REVIEW COMMENTS

7/25/22

SHEET TITLE

EXISTING AND DEMOLITION PLAN

PROJECT #: 2021-D RAWN BY: LL DATE: 3/11/22 SCALE: 1/4" = 1'-0"



4'-6"

44

WET ROOM

1/4"=1'-0"

2 CONSTRUCTION PLAN - 2ND FLOOR

LINE FO HOUSE BELOW

AN PRATH

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DESIGN REVIEW

DESIGN REVIEW COMMENTS

7/25/22

SHEET TITLE
CONSTRUCTION PLAN

PROJECT #: 2021-D

DRAWN BY: LL

DATE: 3/11/22

SCALE: 1/4" = 1'-0"

DRAWING NUMBER

A2.1

PROJECT DATA

ZONING DISTRICT: RS-6 CONSTRUCTION TYPE: V-B OCCUPANCY TYPE:

FLOOR AREA RATIO INFORMATION

LOT SIZE: 15,072 SF
ALLOWABLE FAR FOR THE HOUSE: 32% OF LOT PLUS 1100 SF
ALLOWABLE FAR FOR THE HOUSE: 4,823 SF + 1,100 SF = 5,923 SF
EXISTING FAR HOUSE: HOUSE = 1,983 SF
GARAGE = 467 SF

TOTAL EXISTING FAR HOUSE: 2,450 SF

PROPOSED FAR HOUSE: (E) HOUSE = 1,983 SF 1ST FLOOR ADDITION = 104 SF (E) GARAGE (NO CHANGE) = 467 SF 2ND FLOOR ADDITION = 918 SF

TOTAL PROPOSED FAR HOUSE: 3,472 SF


LOT COVERAGE INFORMATION

ALLOWABLE LOT COVERAGE - .40 X 15,072 SF = 6,029 SF

EXISTING LOT COVERAGE: 1,983 SF (HOUSE) + 467 SF (GAR) = 2,450 SF

PROPOSED LOT COVERAGE: 2,087 SF (HOUSE 1ST FLOOR) + 467 SF (GAR)

= 2,554 SF

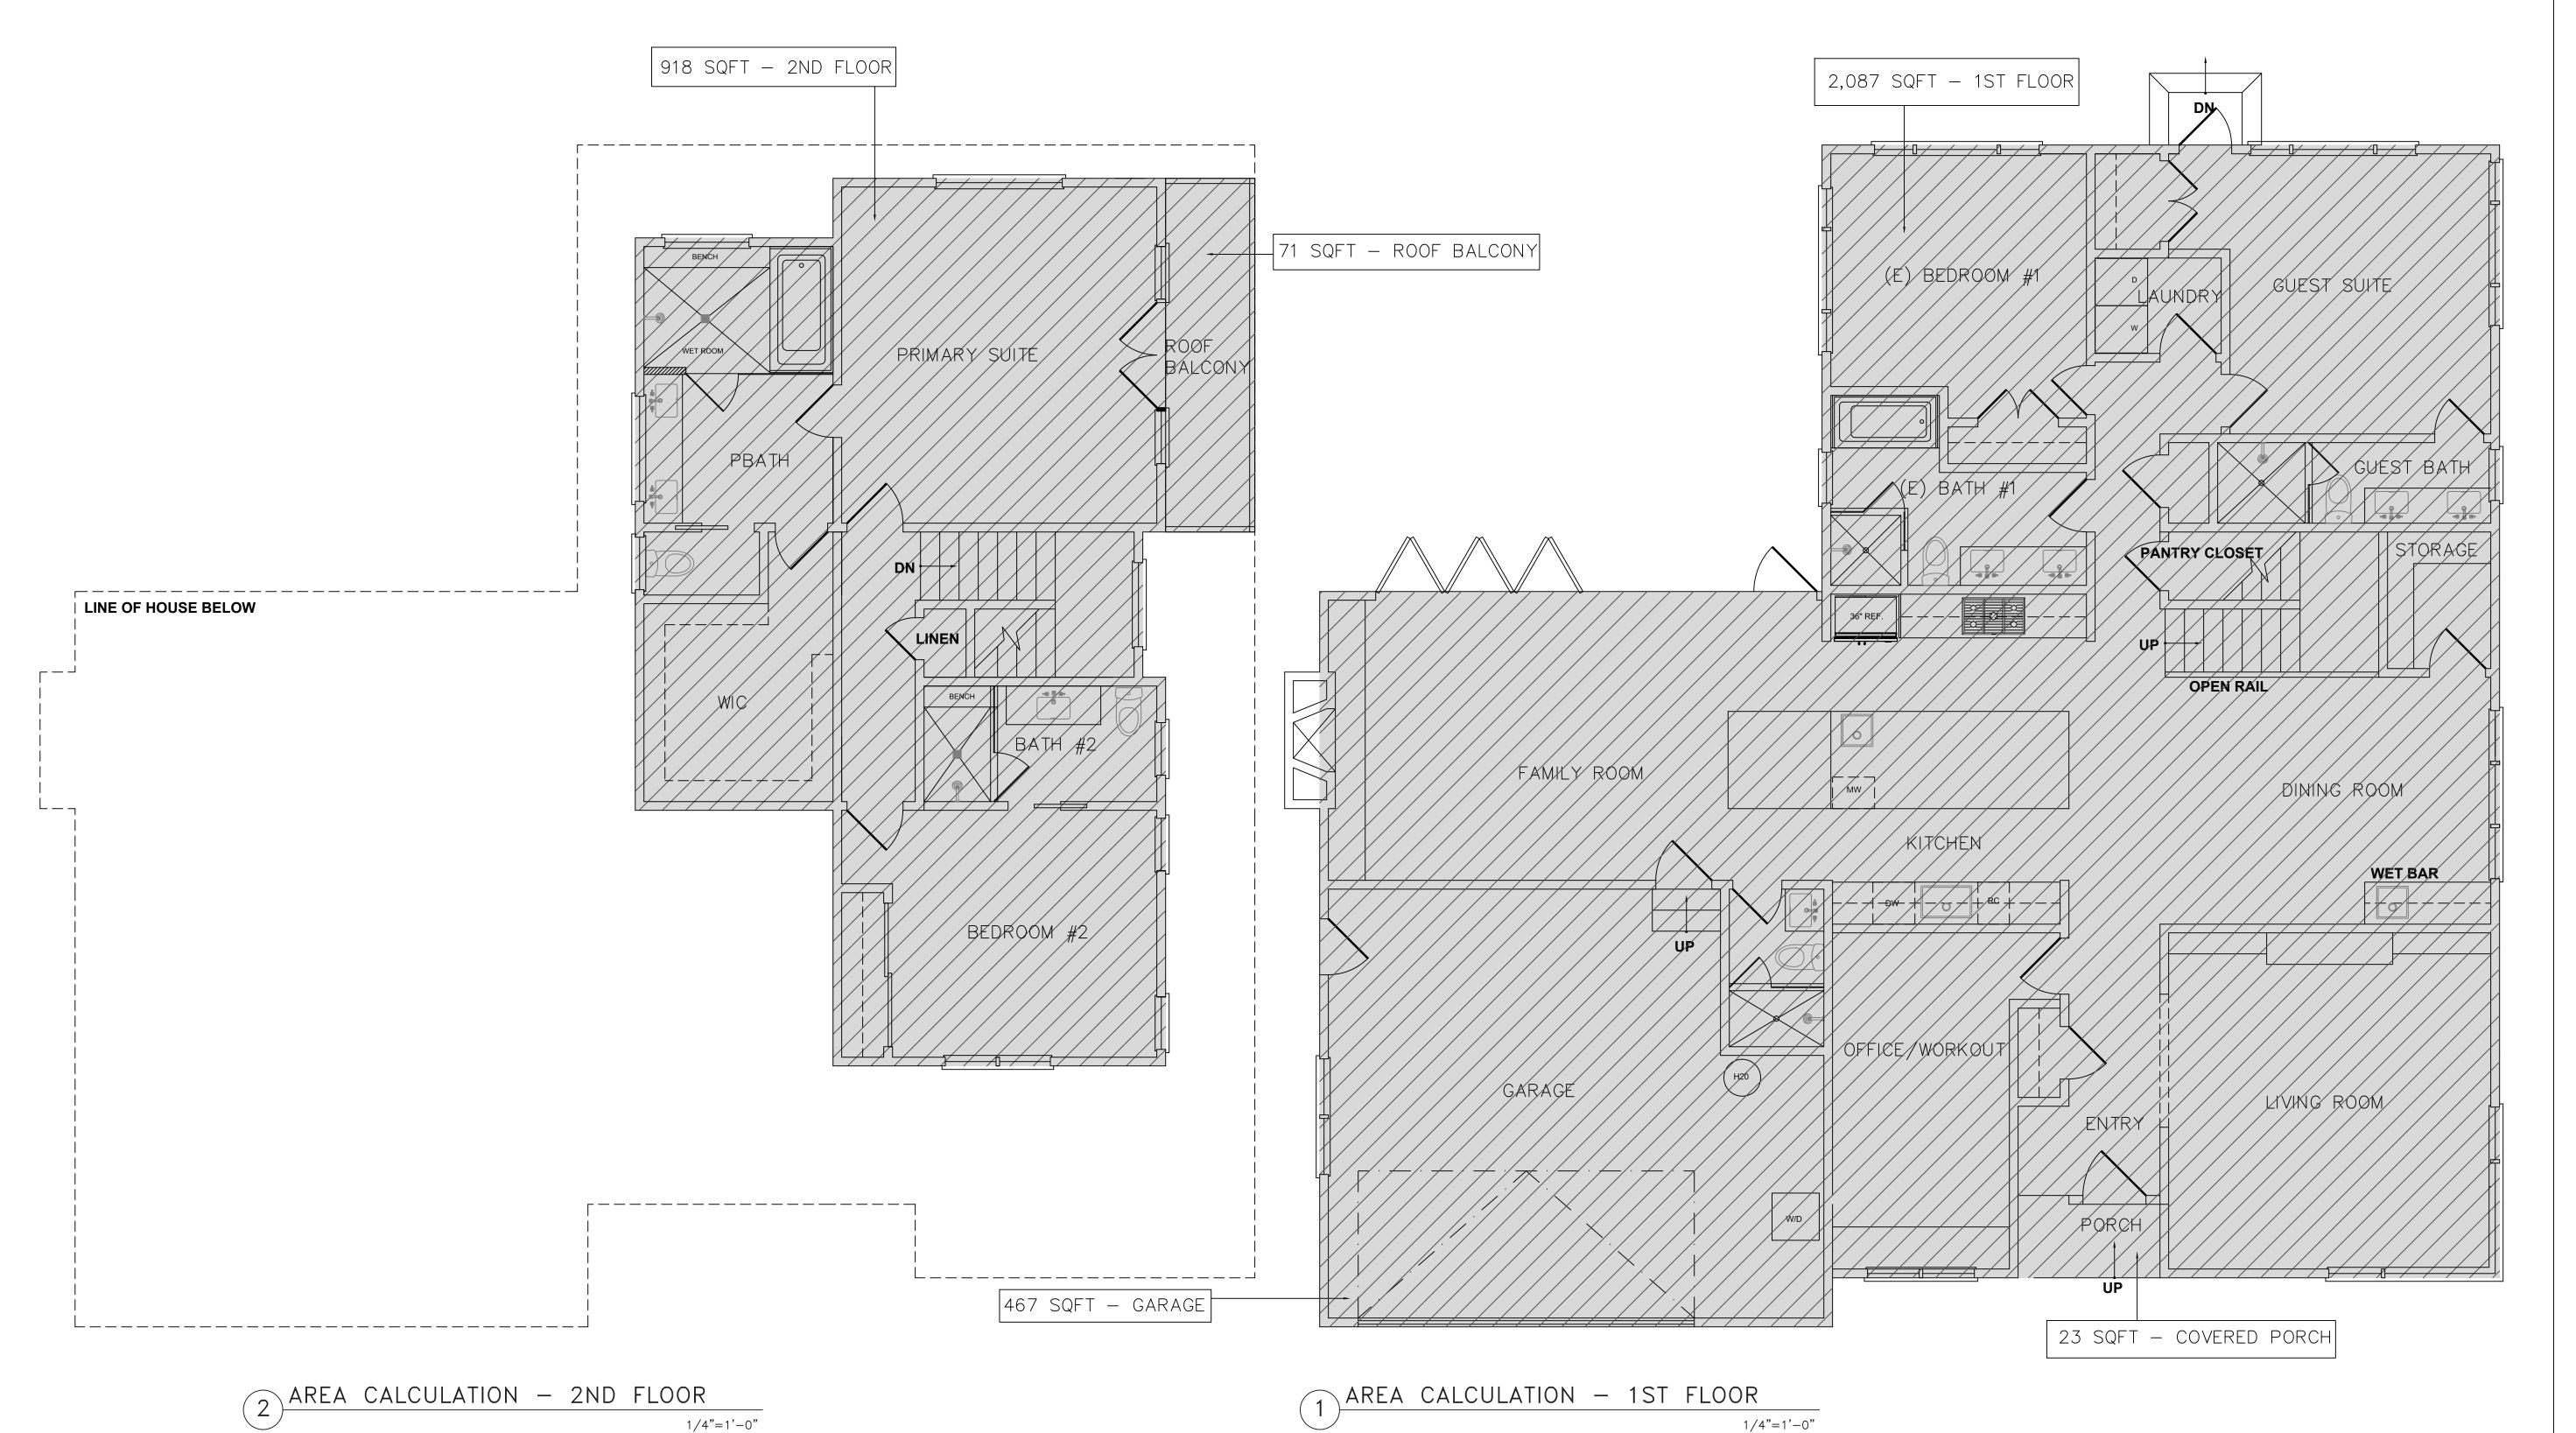

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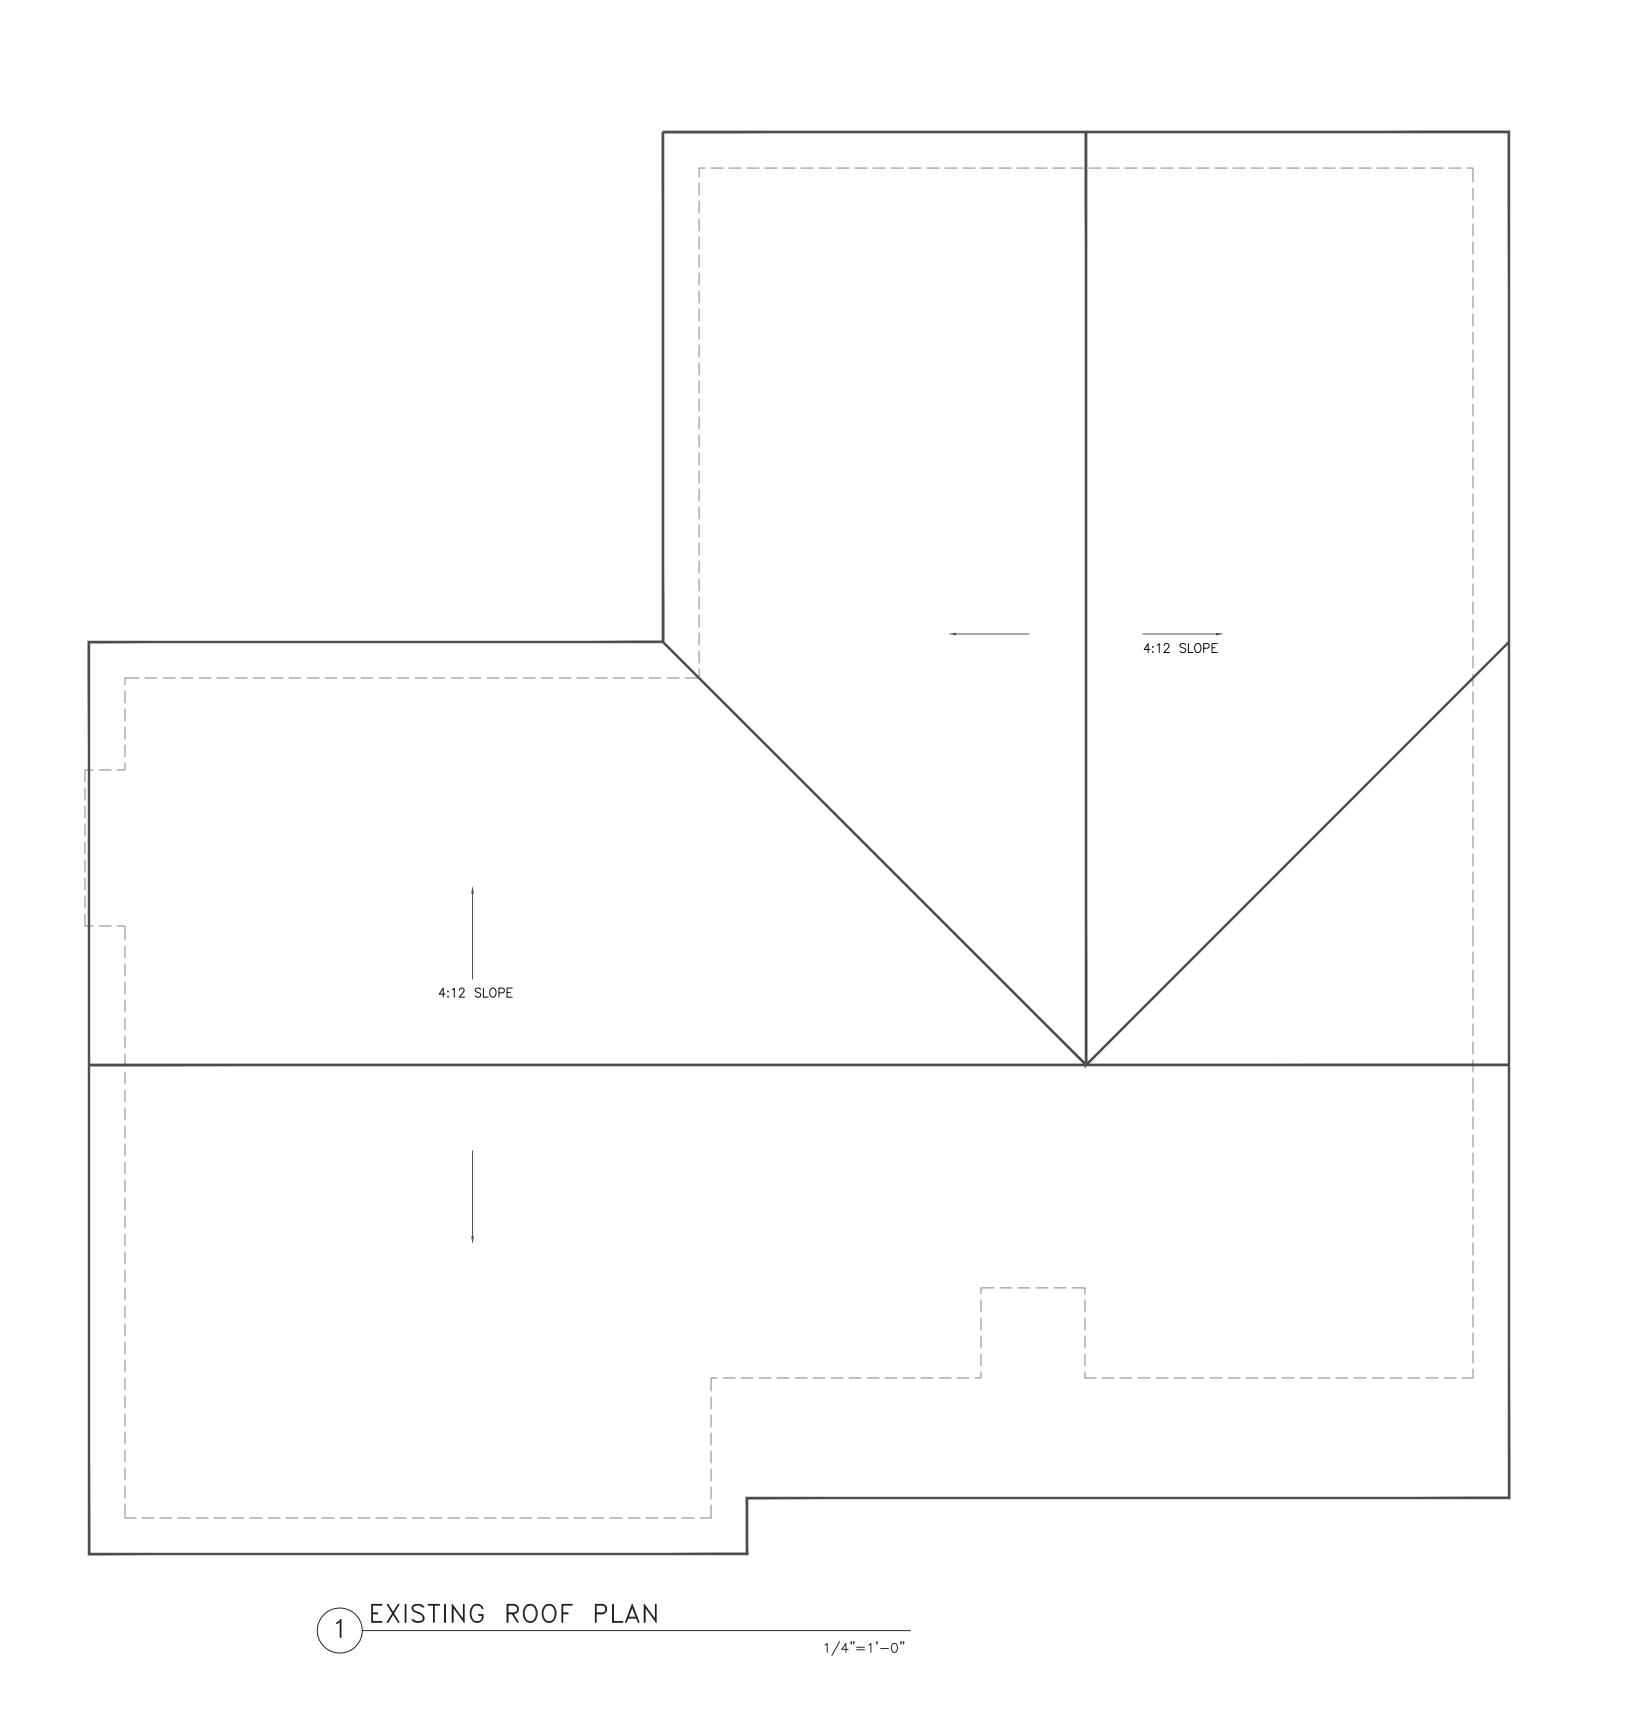
SHEET TITLE

AREA CALCULATIONS

PROJECT #: 2021-DDRAWN BY: LL
DATE: 5/6/22SCALE: 1/4" = 1'-0"

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DESIGN REVIEW 6/1/22

SHEET TITLE

EXISTING ROOF PLAN

PROJECT #: 2021-D


DRAWN BY: LL

DATE: 4/18/22

SCALE: 1/4" = 1'-0"

DRAWING NUMBER

A2.3

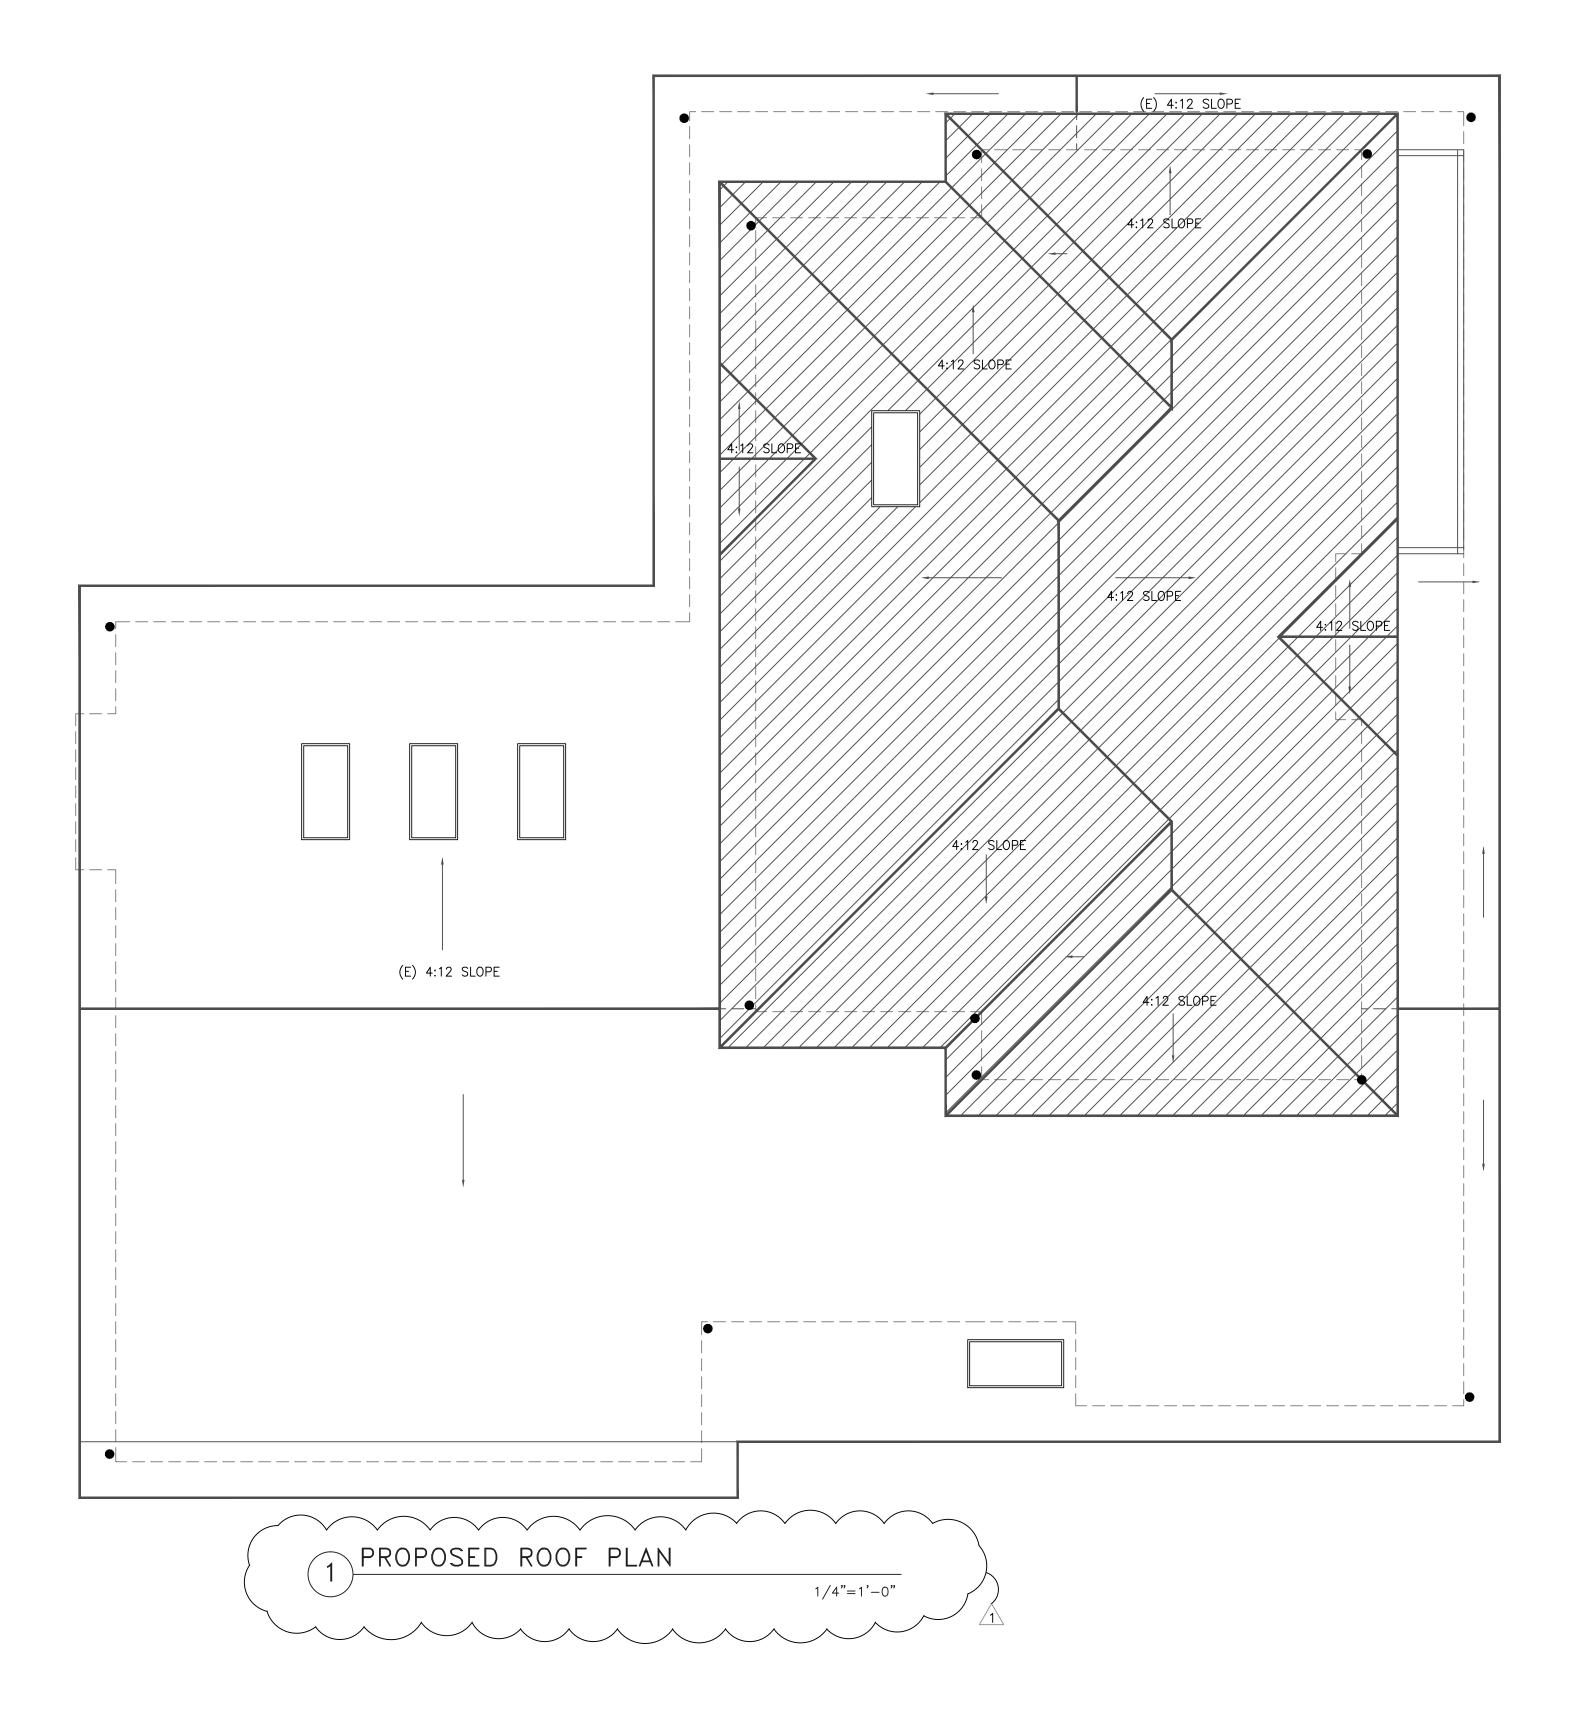

SHEET NOTES

- 1 ROOF EAVES WILL NOT PROJECT WITHIN TWO FEET OF PROPERTY LINE. 2019 CRC TABLE R302.1(1). EAVES THAT DO PROJECT WITHIN 2 FEET OF THE PROPERTY LINE ARE REQUIRED TO BE CONSTRUCTED OF ONE—HOUR FIRE—RESISTANCE RATED CONSTRUCTION. 2019 CRC R302.1(1)
- 2) HATCHED AREA INDICATES NEW ROOF
- MATCH (E) ROOF MATERIAL
- 4 - DOWNSPOUTS, TIE INTO (E) DOWNSPOUT AND STORM DRAINAGE SYSTEM
- 5) ROOF MATERIAL: 50 YEAR COMPOSITE SHINGLE ROOF WITH DOUBLE UNDERLAYMENT APPLICATION PER CRC 308.4
- 6 COMPLY WITH 2019 CALIFORNIA ENERGY FOR COOL ROOF REQUIREMENTS.

ATTIC VENTILATION

ATTIC VENTILATION CALCULATION —
AREA OF PROPOSED NEW ATTIC SPACE
1 SQUARE FOOT FOR 150 SQFT OF ATTIC SPACE

1ST FLOOR ATTIC SPACE REQUIRED VENTILATION - SQFT/150 SQFT = SQFT

PROVIDE-12X24 DORMER ATTIC VENTS - 1 VENT = .69 SQFT VENTILATION PROVIDE- ATTIC VENTS = SQFT VENTILATION

2ND FLOOR ATTIC SPACE — REQUIRED VENTILATION — SQFT/150 SQFT = SQFT

PROVIDE-12X24 DORMER ATTIC VENTS - 1 VENT = .69 SQFT VENTILATION PROVIDE- ATTIC VENTS = SQFT VENTILATION

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1 DESIGN	REVIEW	COMMENTS
7/25/2	22	

SHEET TITLE

PROPOSED ROOF PLAN

PROJECT #: 2021-D DRAWN BY: LL DATE: 5/3/22

DATE: 5/3/22SCALE: 1/4" = 1'-0"


DRAWING NUMBER

A2.4

RIDGE HEIGHT TOP PLATE - 1ST FLOOR WINDOW TO BE REMOVED FINISHED FLOOR - 1ST FLOOR EXISTING FRONT ELEVATION

1/4"=1'-0"

1/4"=1'-0"

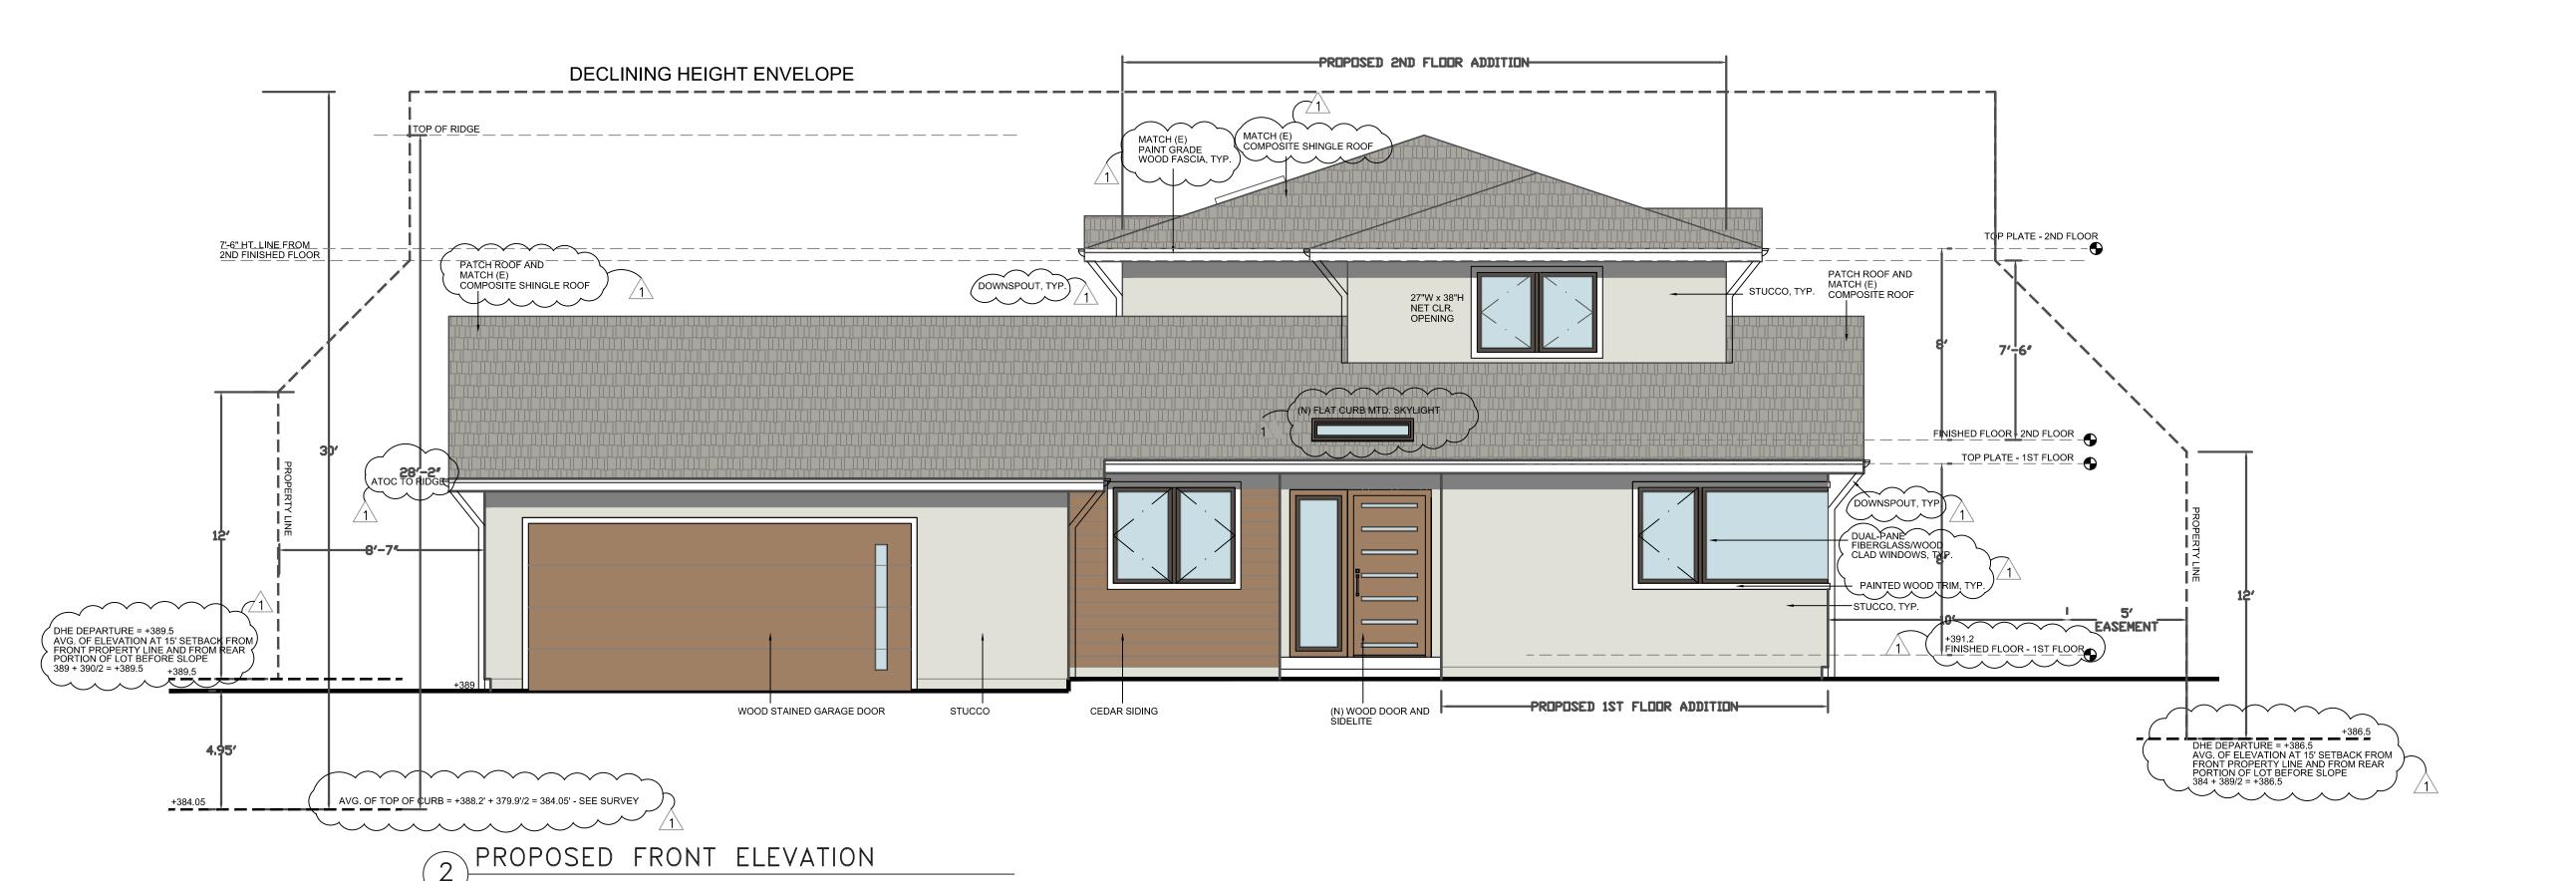

EXTERIOR FINISHES

- 1. (N) WINDOWS AND EXTERIOR DOORS (FIBERGLASS/WOOD CLAD WINDOWS)
- 2. (N) FRONT DOOR STAINED GRADE EXTERIOR WOOD
- 3. (N) 4 PANEL ROLL-UP GARAGE DOOR STAIN GRADE EXTERIOR WOOD
- 4. EXTERIOR FINISH #1 STAINED CEDAR SIDING
- 5. EXTERIOR FINISH #2 INTEGRATED COLOR STUCCO
 6. TRIM PAINTED WOOD TRIM WINDOW TRIM, FASCIA
 7. ROOF COMPOSITE SHINGLE TO MATCH EXISTING DARK GREY
- 8. MAIN HOUSE FRONT PORCH (N) STONE TILES
- 9. ROOF BALCONY RAIL DARK BRONZE POST AND HORIZONTAL FLAT BARS

CRAWL SPACE VENTILATION

CRAWL SPACE VENTILATION CALCULATION

AREA OF CRAWL SPACE = 2,006 SQFT 1 SQUARE FOOT FOR 150 SQFT OF CRAWL SPACE REQUIRED VENTILATION - 2,006 SQFT/150 SQFT = 13.37 SQFT

PROVIDE - 14 - 6X24 CRAWL SPACE VENTS - 1 VENT = 1 SQFT VENTILATION

TOTAL VENTILATION PROVIDED - 14 SQFT

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7/25/22


SHEET TITLE

EXISTING AND PROPOSED FRONT **ELEVATION**


PROJECT #: 2022-D DRAWN BY: LL DATE: 4/21/22 SCALE: 1/4" = 1'-0"

DRAWING NUMBER

A4.0

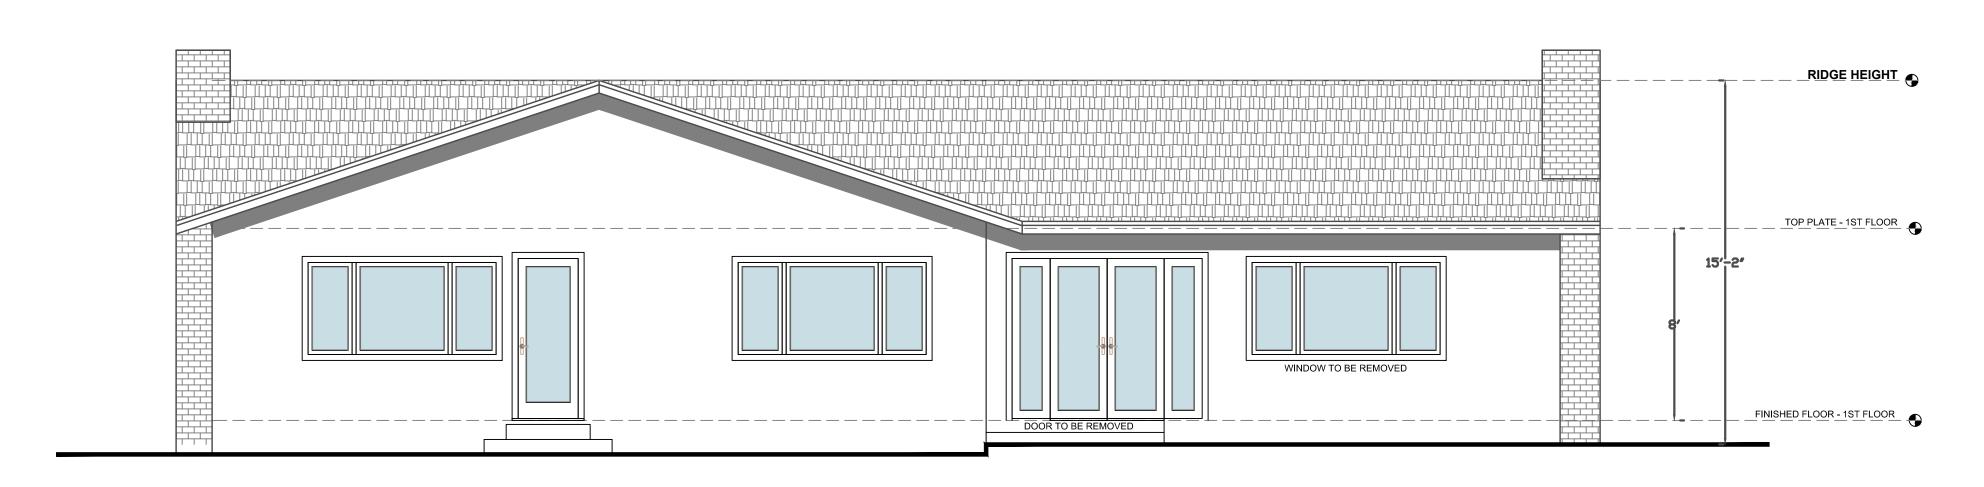



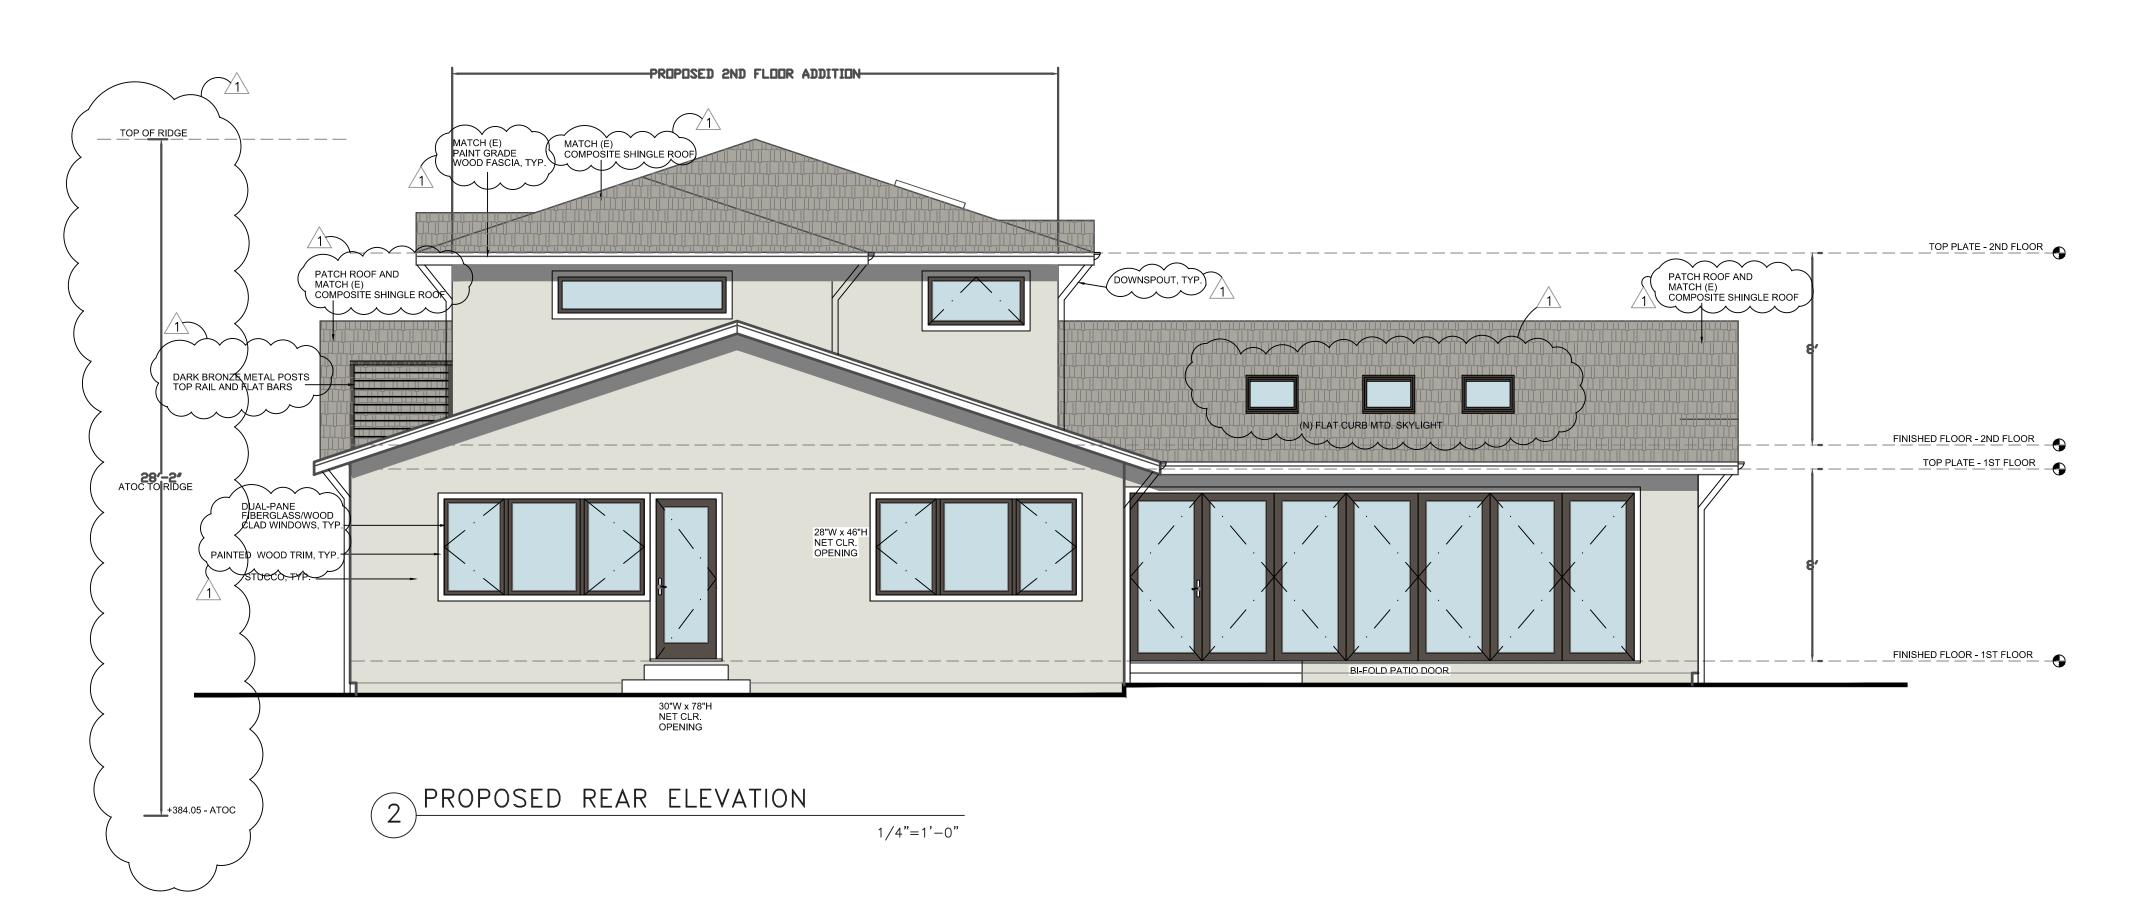

EXTERIOR FINISHES

- 1. (N) WINDOWS AND EXTERIOR DOORS (FIBERGLASS/WOOD CLAD WINDOWS)
- 2. (N) FRONT DOOR STAINED GRADE EXTERIOR WOOD
- 3. (N) 4 PANEL ROLL-UP GARAGE DOOR STAIN GRADE EXTERIOR WOOD
- 4. EXTERIOR FINISH #1 STAINED CEDAR SIDING
- 5. EXTERIOR FINISH #2 INTEGRATED COLOR STUCCO
 6. TRIM PAINTED WOOD TRIM WINDOW TRIM, FASCIA
 7. ROOF COMPOSITE SHINGLE TO MATCH EXISTING DARK GREY

- 8. MAIN HOUSE FRONT PORCH (N) STONE TILES 9. ROOF BALCONY RAIL DARK BRONZE POST AND HORIZONTAL FLAT BARS

CRAWL SPACE VENTILATION

CRAWL SPACE VENTILATION CALCULATION

AREA OF CRAWL SPACE = 2,006 SQFT

1 SQUARE FOOT FOR 150 SQFT OF CRAWL SPACE

REQUIRED VENTILATION — 2,006 SQFT/150 SQFT = 13.37 SQFT

PROVIDE - 14 - 6X24 CRAWL SPACE VENTS - 1 VENT = 1 SQFT VENTILATION

TOTAL VENTILATION PROVIDED - 14 SQFT

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7/25/22


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EXISTING AND PROPOSED REAR **ELEVATION**

PROJECT #: 2022-D DRAWN BY: LL DATE: 4/21/22 SCALE: 1/4" = 1'-0"

DRAWING NUMBER

A4.1

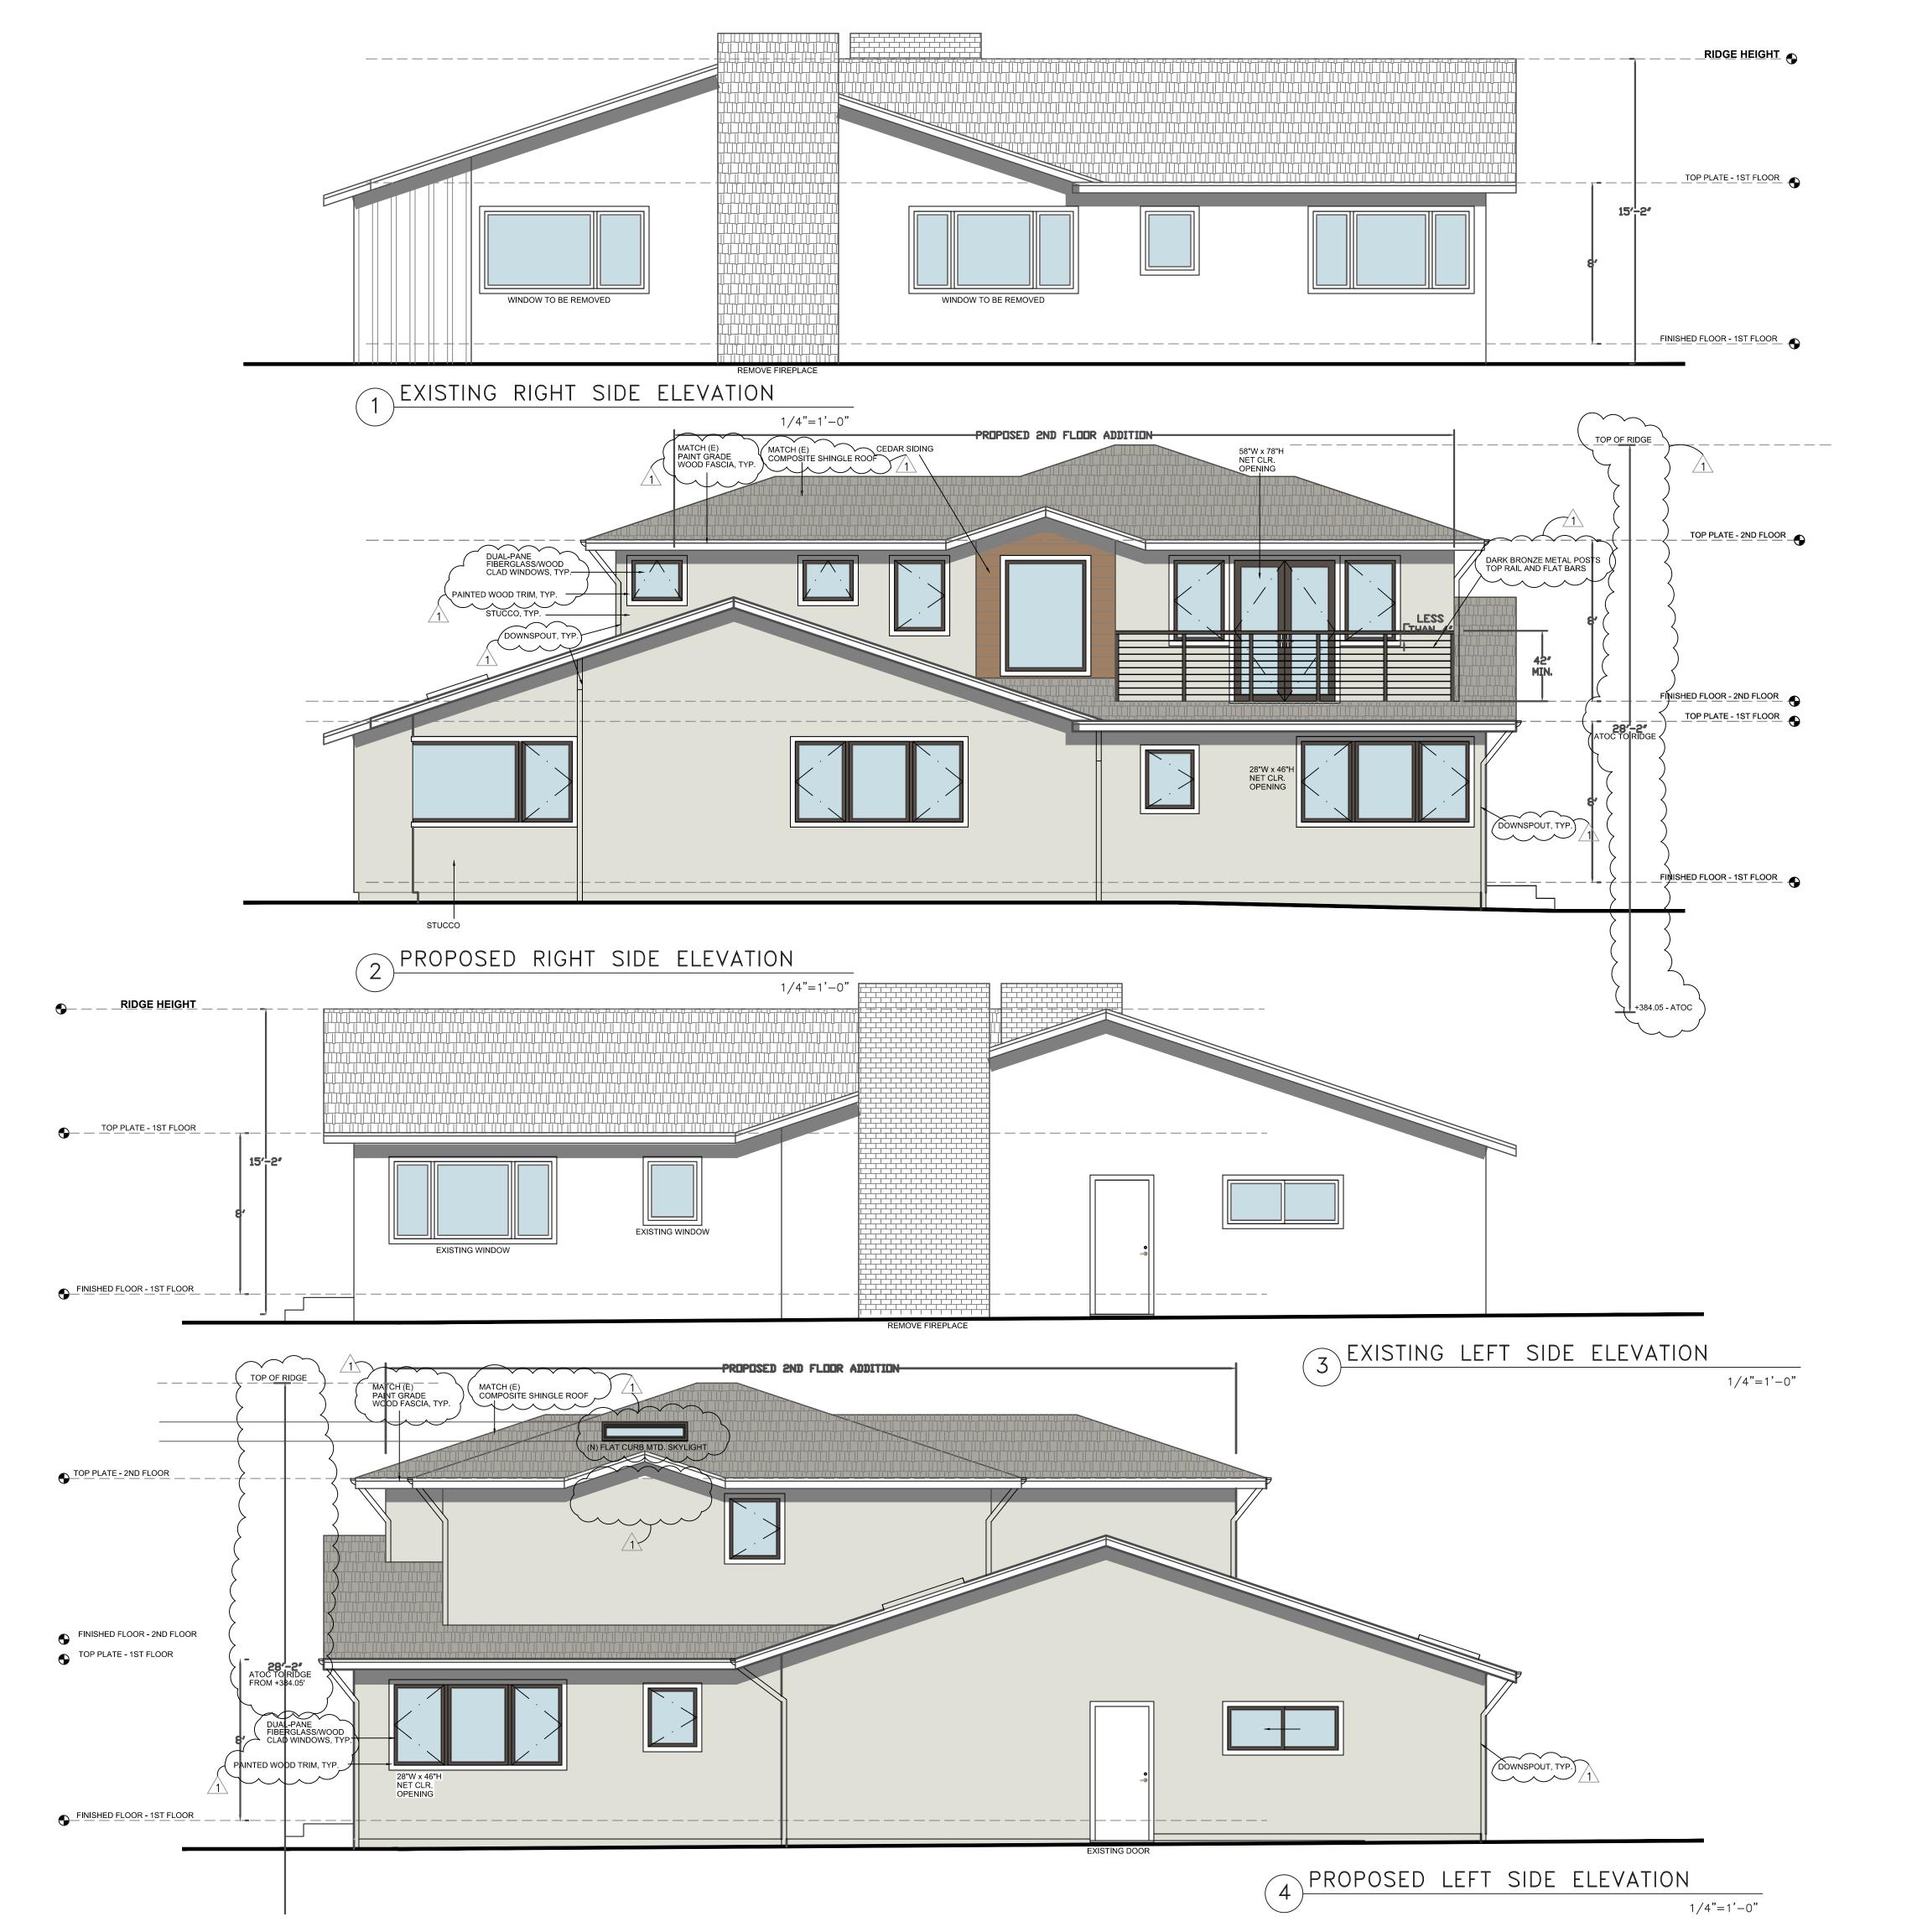

EXTERIOR FINISHES

- 1. (N) WINDOWS AND EXTERIOR DOORS FIBERGLASS/WOOD CLAD WINDOWS
- 2. (N) FRONT DOOR STAINED GRADE EXTERIOR WOOD
- 3. (N) 4 PANEL ROLL-UP GARAGE DOOR STAIN GRADE EXTERIOR WOOD
- 4. EXTERIOR FINISH #1 STAINED CEDAR SIDING
- EXTERIOR FINISH #2 INTEGRATED COLOR STUCCO
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CRAWL SPACE VENTILATION

CRAWL SPACE VENTILATION CALCULATION

AREA OF CRAWL SPACE = 2,006 SQFT

1 SQUARE FOOT FOR 150 SQFT OF CRAWL SPACE
REQUIRED VENTILATION — 2,006 SQFT/150 SQFT = 13.37 SQFT

PROVIDE - 14 - 6X24 CRAWL SPACE VENTS - 1 VENT = 1 SQFT VENTILATION

TOTAL VENTILATION PROVIDED - 14 SQFT

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	7/25/2	22	
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SHEET TITLE

EXISTING AND PROPOSED SIDE ELEVATIONS

PROJECT #: 2022-D

DRAWN BY: LL

DATE: 4/21/22

SCALE: 1/4" = 1'-0"

DRAWING NUMBER

A4.2