
36 BLOOMFIELD RD.

BURLINGAME, CA 94010

VICINITY MAP:

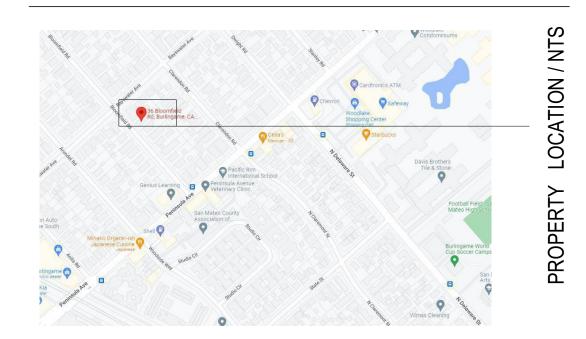

PROJECT DATA:

ASSESSOR'S PARCEL NUMBER: PROJECT TYPE: PROJECT LOCATION:

OCCUPANCY GROUP:

CONSTRUCTION TYPE:

NUMBER OF FLOORS:

NEW CONSTRUCTION
36 BLOOMFIELD RD.
BURLINGAME, CA., 94010
R1
R - 3 / U
V - B
TWO(2)
SPRINKLERED

029293260

THE SCOPE OF RENOVATION (COMBINATION OF ADDITION AND INTERIOR REMODEL) EXCEEDS 750 SQUARE FEET, THEREFORE A FIRE SPRINKLER SYSTEM IS REQUIRED TO BE INSTALLED THROUGHOUT THE RESIDENCE.

570 SF DETACHED ADU WILL BE REVIEWED UNDER A SEPARATE BUILDING PERMIT.

CODE EDITIONS:

A. CALIFORNIA B. CALIFORNIA C. CALIFORNIA D. CALIFORNIA E. CALIFORNIA F. CALIFORNIA G. CALIFORNIA H. CALIFORNIA	BUILDING: MECHANICAL PLUMBING: ELECTRICAL: ENERGY: FIRE: GREEN BUILD	: ING:					2022 2022 2022 2022 2022 2022 2022 202	EDITIO EDITIO EDITIO EDITIO EDITIO EDITIO EDITIO EDITIO	
I. ANY OTHER			AND	STATE	LAWS	AND	REGUL	ATIONS	S.

AREA CALCULATION:

LOT AREA:	7875	SQF
"E" 1ST FLOOR:	1616	SQF
"N" ADDITION TO 1ST FLOOR:	246	SQF
"N" 1ST FLOOR:	1862	SQF
"N" 2ND FLOOR:	1145	SQF
"N" COVERED PORCH:	65	SQF
"E" DETACHED GARAGE :	570	SQF
"N" TOTAL BUILDING:	3007	SOF

MAX. FAR: 32% X 7875 + 1100 + 400 = 4020 SF

LOT COVERAGE: 1ST FLOOR BLDG AREA (1862) SQF COVERED PORCH 65 SQF TOTAL % 1927/7875= 24.4%

AVERAGE TOP OF CURB: (27.88' + 28.36')/2 = 28.12'
ALLOWED HEIGHT: 28.12' + 30' = 58.12' (30'-0" ABOVE AVERAGE TOP OF CURB)
EXISTING: 28.12' + 16.583' = 44.75'
PROPOSED: 28.12' + 26.583' = 54.75'

SCOPE OF WORK:

-ADDITION AND REMODELING AT REAR SIDE OF THE HOUSE TO HAVE A NEW LARG KITCHEN FAMILY.

-ADDITION AT FRONT SIDE OF THE HOUSE TO HAVE A NEW ENTRY INCLUDING POWDER AND CLOSET AND CONVERT THE LIVING ROOM TO OFFICE -ADDITION AT LEFT SIDE OF THE HOUSE TO HAVE A BATHROOM FOR OFFICE. -BUILD A NEW 2ND STORY TO HAVE MASTER BEDROOM INCLUDING MASTER BATH AND WALK-IN CLOSET, TWO BEDROOMS, BATHROOM, AND LAUNDRY.

PROJECT CONTACT:

OWNER: NASIM NOVIN NNOVIN@GMAIL.COM

DESIGNER: AMS DESIGN (415) 254-1606

4010 MOORPARK AVE#101, SAN JOSE, CA 95117

AZADEH@AMSDESIGNLLP.COM

STRUCTURAL: AMS DESIGN (415) 254-2634

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ARMIN@AMSDESIGNLLP.COM

AMS DESIGN (415) 254-1606

4010 MOORPARK AVE#101, SAN JOSE, CA 95117

4010 MOORPARK AVE#101, SAN JOS OFFICE@AMSDESIGNLLP.COM

DRAWING INDEX:

T24 & ENERGY:

A-00.01:	COVER SHEET / PROPOSED SITE PLAN
T-1:	BOUNDRY AND TOPOGRAPHIC SURVEY MAP
A-00.02:	BLOCK AVERAGE FOR FRONT SETBACK
C-1:	COVER SHEET (G&D)
C-2:	GRADING & DRAINAGE PLAN
C-3:	DETAILS
C-4:	EROSION CONTROL PLAN
C-5:	CONSTRUCTION BMP
L-1::	LANDSCAPE PLAN
L-2::	IRRIGATION PLAN
L-3::	IRRIGATION NOTES
L-4::	NOTES
L-5::	TRELLIS AND FIREPLACE DETAIL
RA-01.01:	EXISTING FLOOR PLAN(MAIN HOUSE)
RA-02.01:	EXISTING ELEVATIONS(MAIN HOUSE)
RA-02.02:	EXISTING PLAN & ELEVATIONS (ADU)
A-01.01:	PROPOSED 1ST FLOOR PLAN

PROPOSED ELEVATIONS

SETBACK INFORMATION:

SETBACKS	EXISTING/PROPOSED 1ST	PROPOSED 2ND
FRONT	15'	28'-9"
REAR	80'-6"	86'-3"
RIGHT	12'-8"	12'-8"
LEFT	5'	5'-8"
MAIN HOUSE TO ADU	32'-8"	

FLOOR AREA DIAGRAM / EXTERIOR MATERIAL SCHEDULE


EXISTING FOOT PRINT PLAN / DEMOLITION PLAN


GENERAL NOTES:

ALL WORK DESCRIBED IN THE DRAWINGS SHALL BE VERIFIED FOR DIMENSION, GRADE, EXTENT AND COMPATIBILITY TO THE EXISTING SITE. ANY DISCREPANCIES AND UNEXPECTED CONDITIONS THAT AFFECT OR CHANGE THE WORK DESCRIBED IN THE CONTRACT DOCUMENTS SHALL BE BROUGHT TO THE AMS DESIGN'S ATTENTION IMMEDIATELY. DO NOT PROCEED WITH THE WORK IN THE AREA OF DISCREPANCIES UNTIL ALL SUCH DISCREPANCIES ARE RESOLVED. IF THE CONTRACTOR CHOOSES TO DO SO HE SHALL BE PRECEDING AT HIS OWN RISK.

OMISSIONS FROM THE DRAWINGS AND SPECIFICATIONS OR THE MISDESCRIPTION OF THE WORK WHICH IS MANIFESTLY NECESSARY TO CARRY OUT THE INTENT OF THE DRAWINGS AND SPECIFICATIONS, OR WHICH IS CUSTOMARILY REFORMED, SHALL NOT RELIEVE THE CONTRACTOR FROM PERFORMING SUCH OMITTED OR MIS-DESCRIBED DETAILS OF THE WORK AS IF FULLY AND COMPLETELY SET FORTH AND DESCRIBED IN THE DRAWINGS AND SPECIFICATIONS.

SITE CONDITIONS: ALL CONTRACTORS AND SUB-CONTRACTORS SHALL VERIFY DIMENSIONS AND CONDITIONS AT THE SITE PRIOR TO COMMENCEMENT OF THEIR WORK. FAILURE TO DO SO SHALL NOT RELEASE THEM FROM THE RESPONSIBILITY OF ESTIMATING THE WORK. IF ANY VARIATION, DISCREPANCY OR OMISSION (BETWEEN THE INTENT OF THESE CONTRACT DOCUMENTS AND THE EXISTING CONDITIONS ARE FOUND, THE CONTRACTOR OR SUB-CONTRACTOR SHALL NOTIFY AMS DESIGN IN WRITING AND OBTAIN WRITTEN RESOLUTION FROM AMS DESIGN PRIOR TO PROCEEDING WITH ANY RELATED WORK.

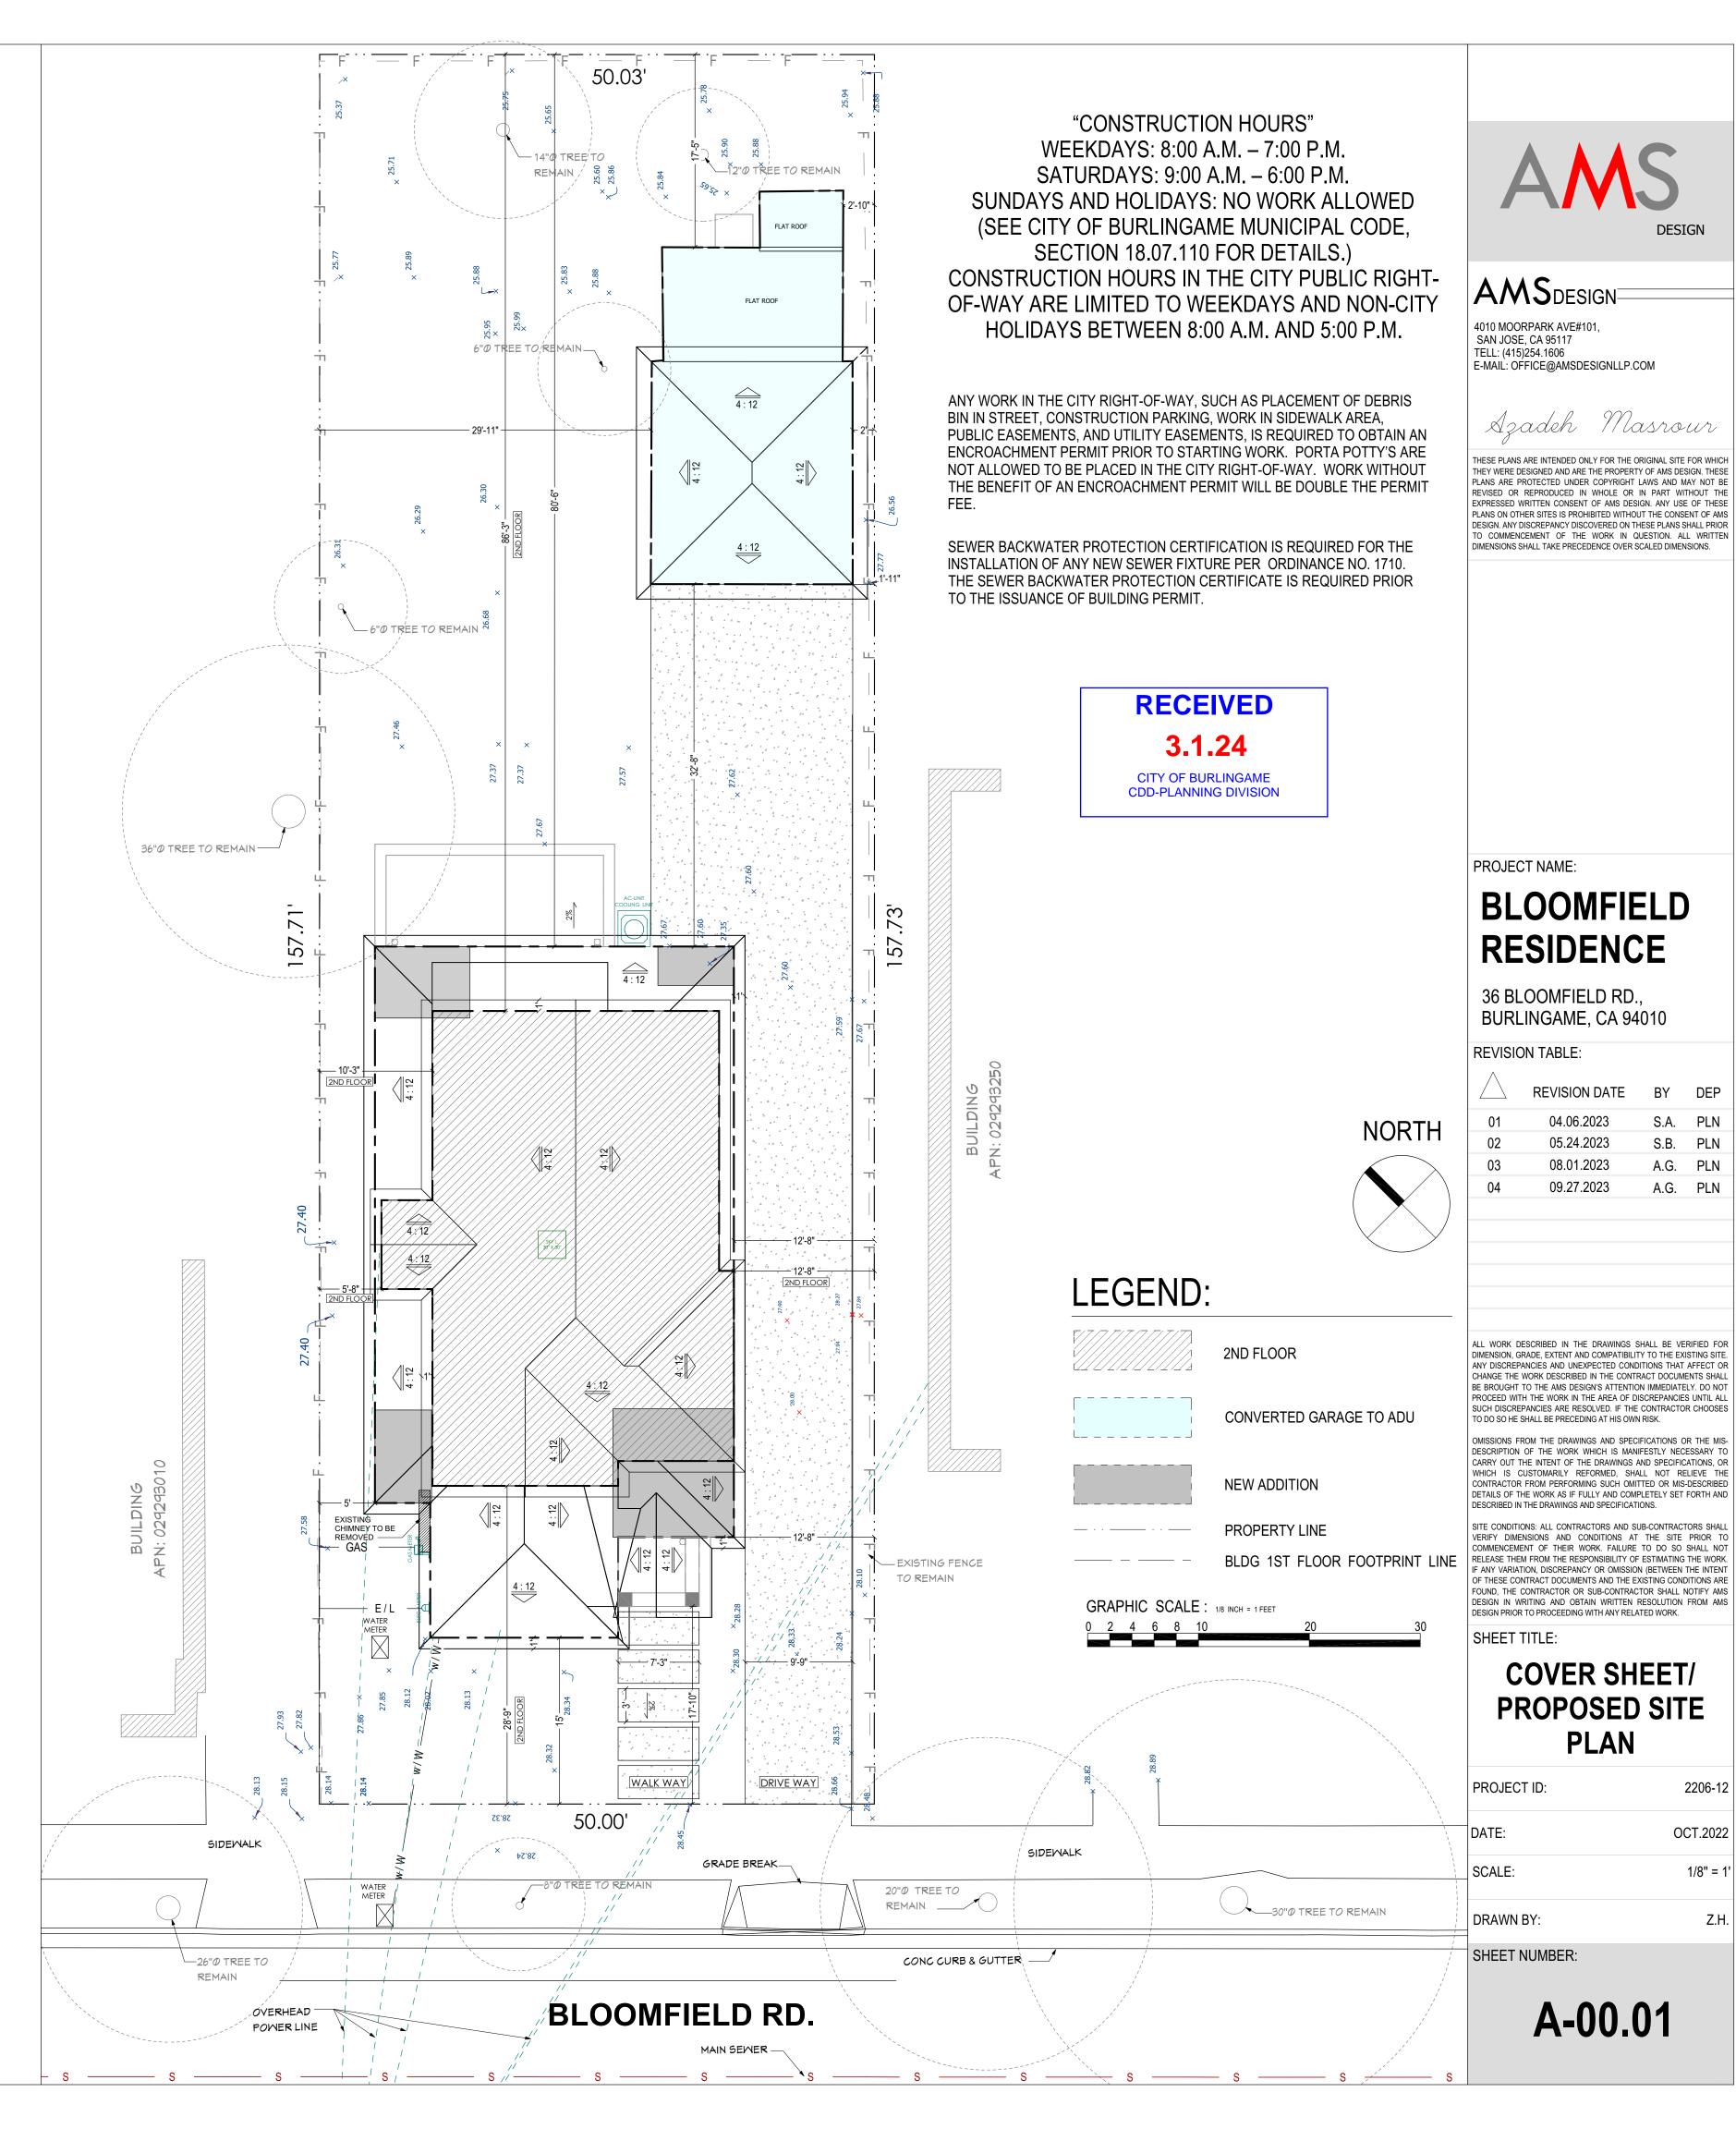

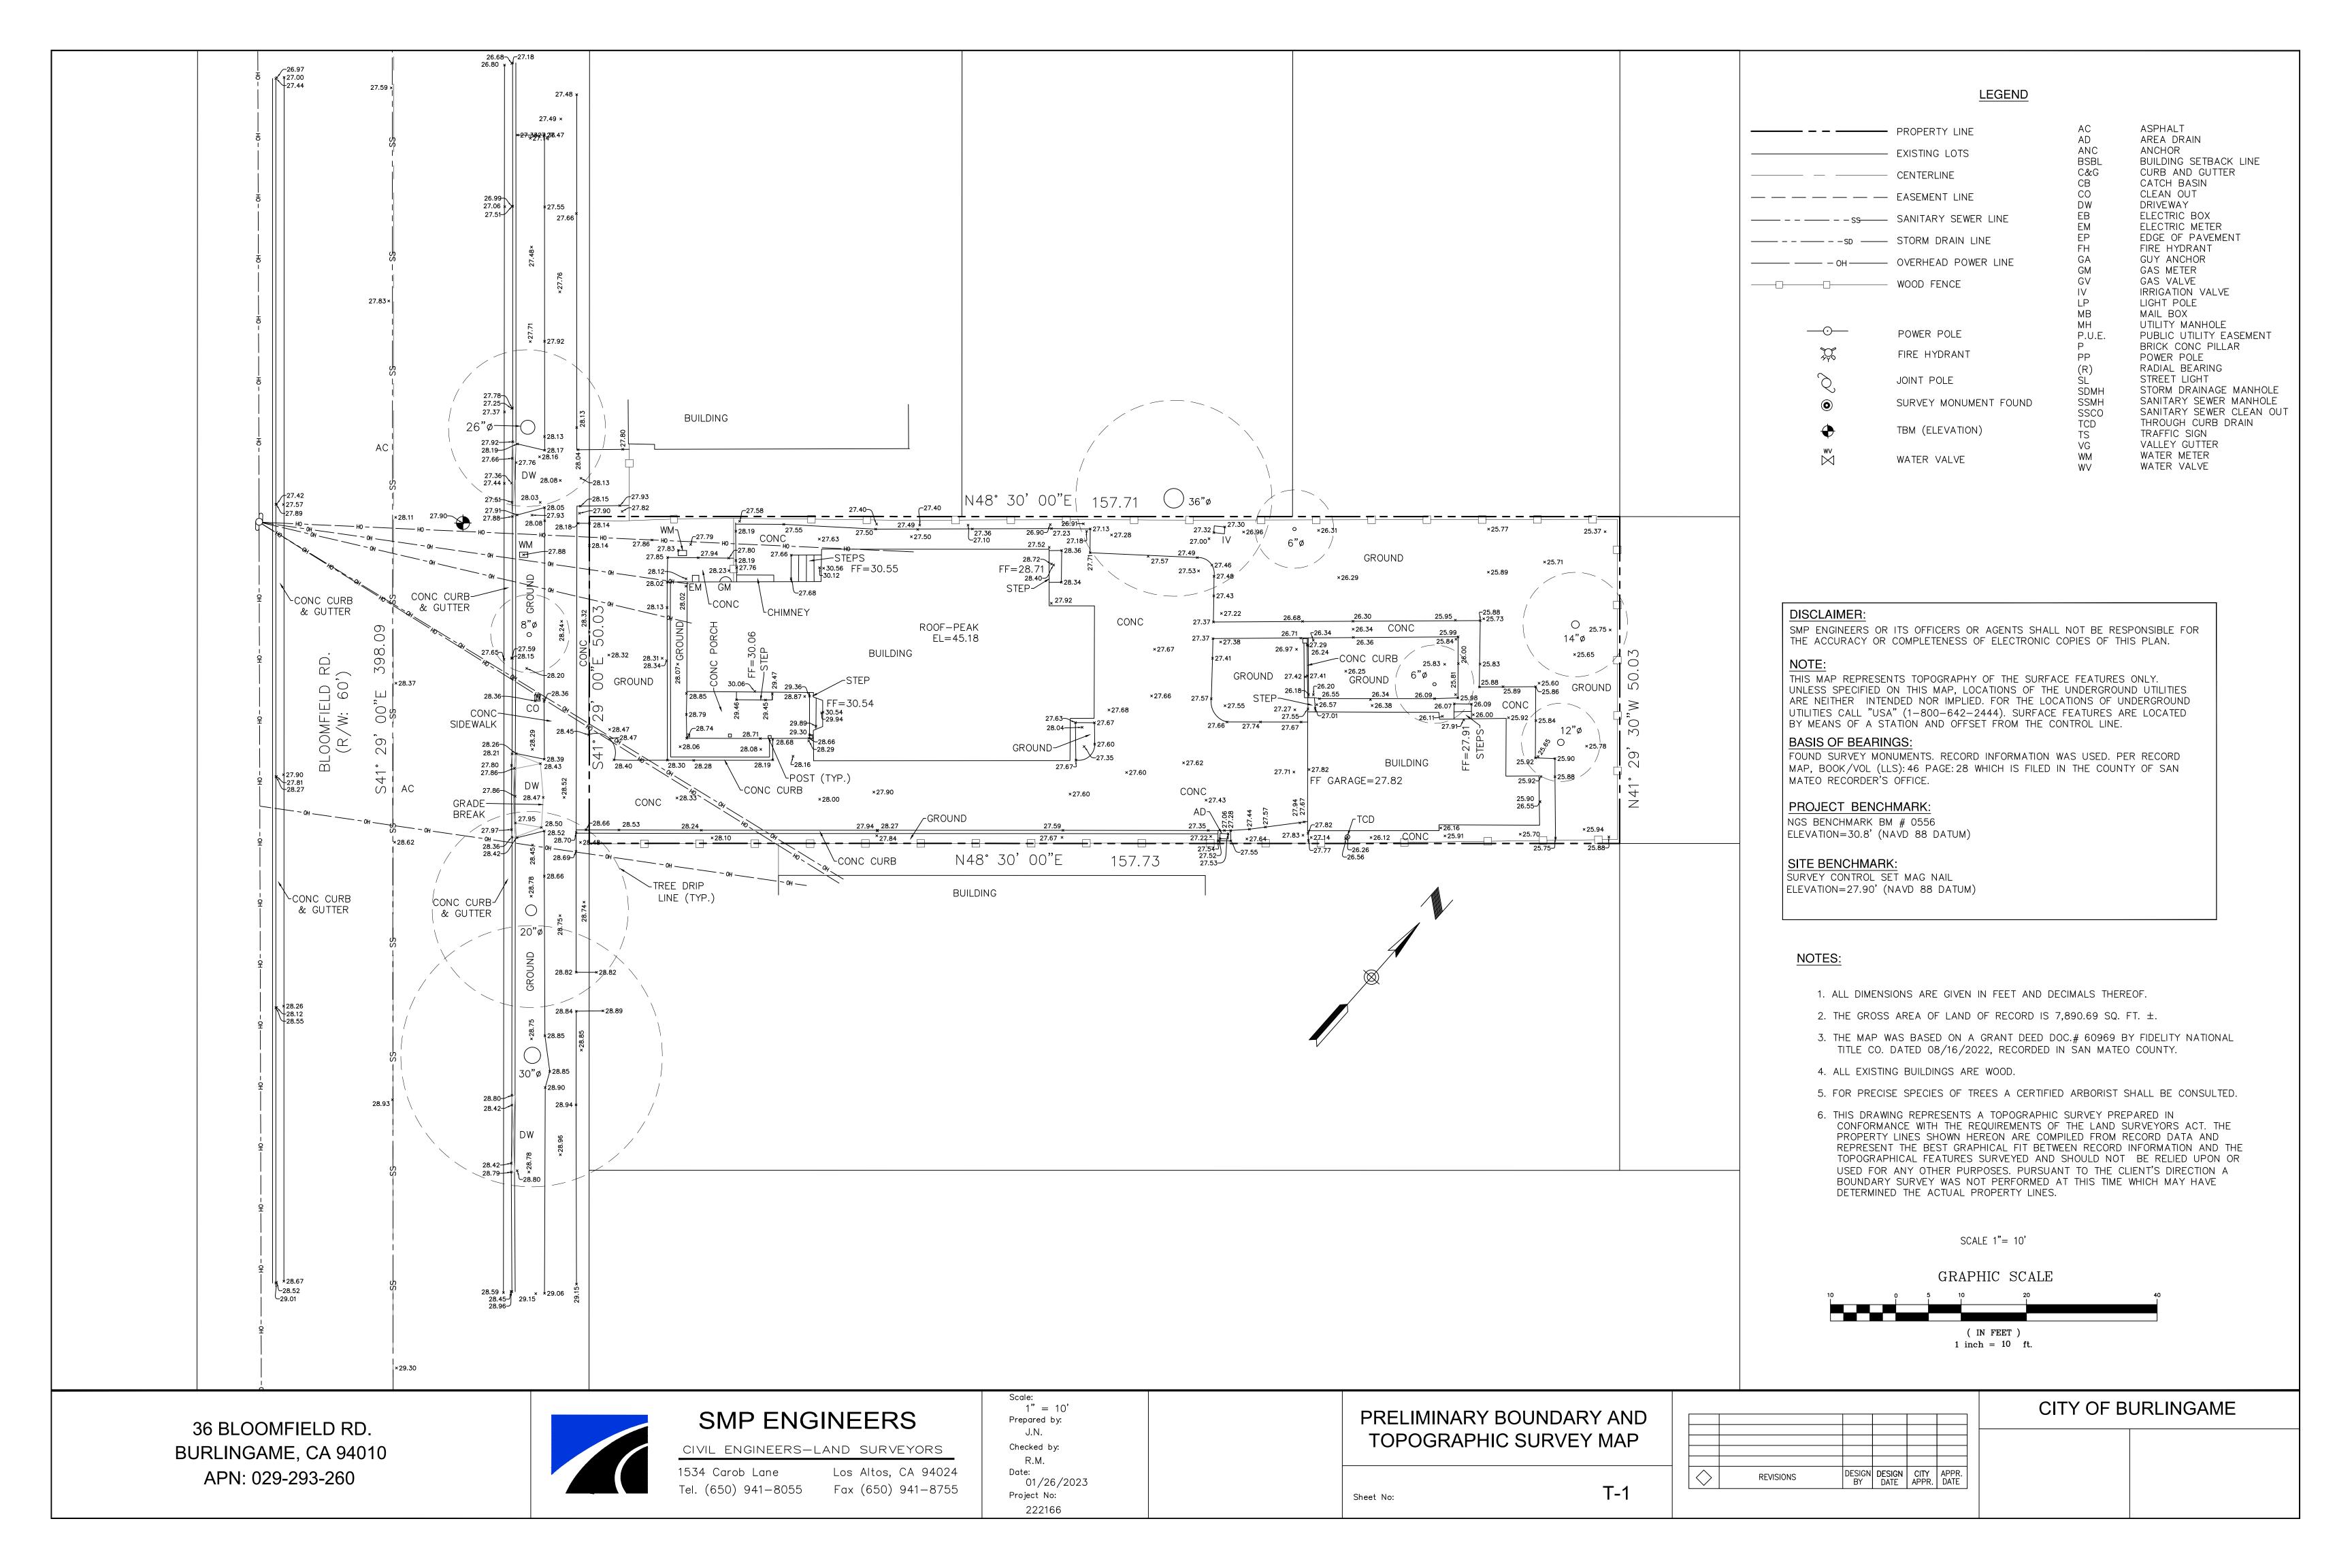



AMS DESIGN

4010 MOORPARK AVE#101, SAN JOSE, CA 95117 TELL: (415)254.1606 E-MAIL: OFFICE@AMSDESIGNLLP.COM

Tradoh Marrous

THESE PLANS ARE INTENDED ONLY FOR THE ORIGINAL SITE FOR WHICH THEY WERE DESIGNED AND ARE THE PROPERTY OF AMS DESIGN. THESE PLANS ARE PROTECTED UNDER COPYRIGHT LAWS AND MAY NOT BE REVISED OR REPRODUCED IN WHOLE OR IN PART WITHOUT THE EXPRESSED WRITTEN CONSENT OF AMS DESIGN. ANY USE OF THESE PLANS ON OTHER SITES IS PROHIBITED WITHOUT THE CONSENT OF AMS DESIGN. ANY DISCREPANCY DISCOVERED ON THESE PLANS SHALL PRIOR TO COMMENCEMENT OF THE WORK IN QUESTION. ALL WRITTEN DIMENSIONS SHALL TAKE PRECEDENCE OVER SCALED DIMENSIONS.

PROJECT NAME:

BLOOMFIELD RESIDENCE

36 BLOOMFIELD RD., BURLINGAME, CA 94010

REVISION TABLE:

	REVISION DATE	BY	DEP
01	04.06.2023	S.A.	PLN
02	05.24.2023	S.B.	PLN
03	08.01.2023	A.G.	PLN
04	09.27.2023	A.G.	PLN

ALL WORK DESCRIBED IN THE DRAWINGS SHALL BE VERIFIED FOR DIMENSION, GRADE, EXTENT AND COMPATIBILITY TO THE EXISTING SITE. ANY DISCREPANCIES AND UNEXPECTED CONDITIONS THAT AFFECT OR CHANGE THE WORK DESCRIBED IN THE CONTRACT DOCUMENTS SHALL BE BROUGHT TO THE AMS DESIGN'S ATTENTION IMMEDIATELY. DO NOT PROCEED WITH THE WORK IN THE AREA OF DISCREPANCIES UNTIL ALL SUCH DISCREPANCIES ARE RESOLVED. IF THE CONTRACTOR CHOOSES TO DO SO HE SHALL BE PRECEDING AT HIS OWN RISK.

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SHEET TITLE:

NORTH

LEGEND:

SUBJECT PARCEL


PROPERTY LINE

BLDG 1ST FLOOR FOOTPRINT LINE

BLOCK AVERAGE FOR FRONT SETBACK

PROJECT ID:	2206-12
DATE:	OCT.2022
SCALE:	1/18" = 1
DRAWN BY:	Z.H
SHEET NUMBER:	

A-00.02

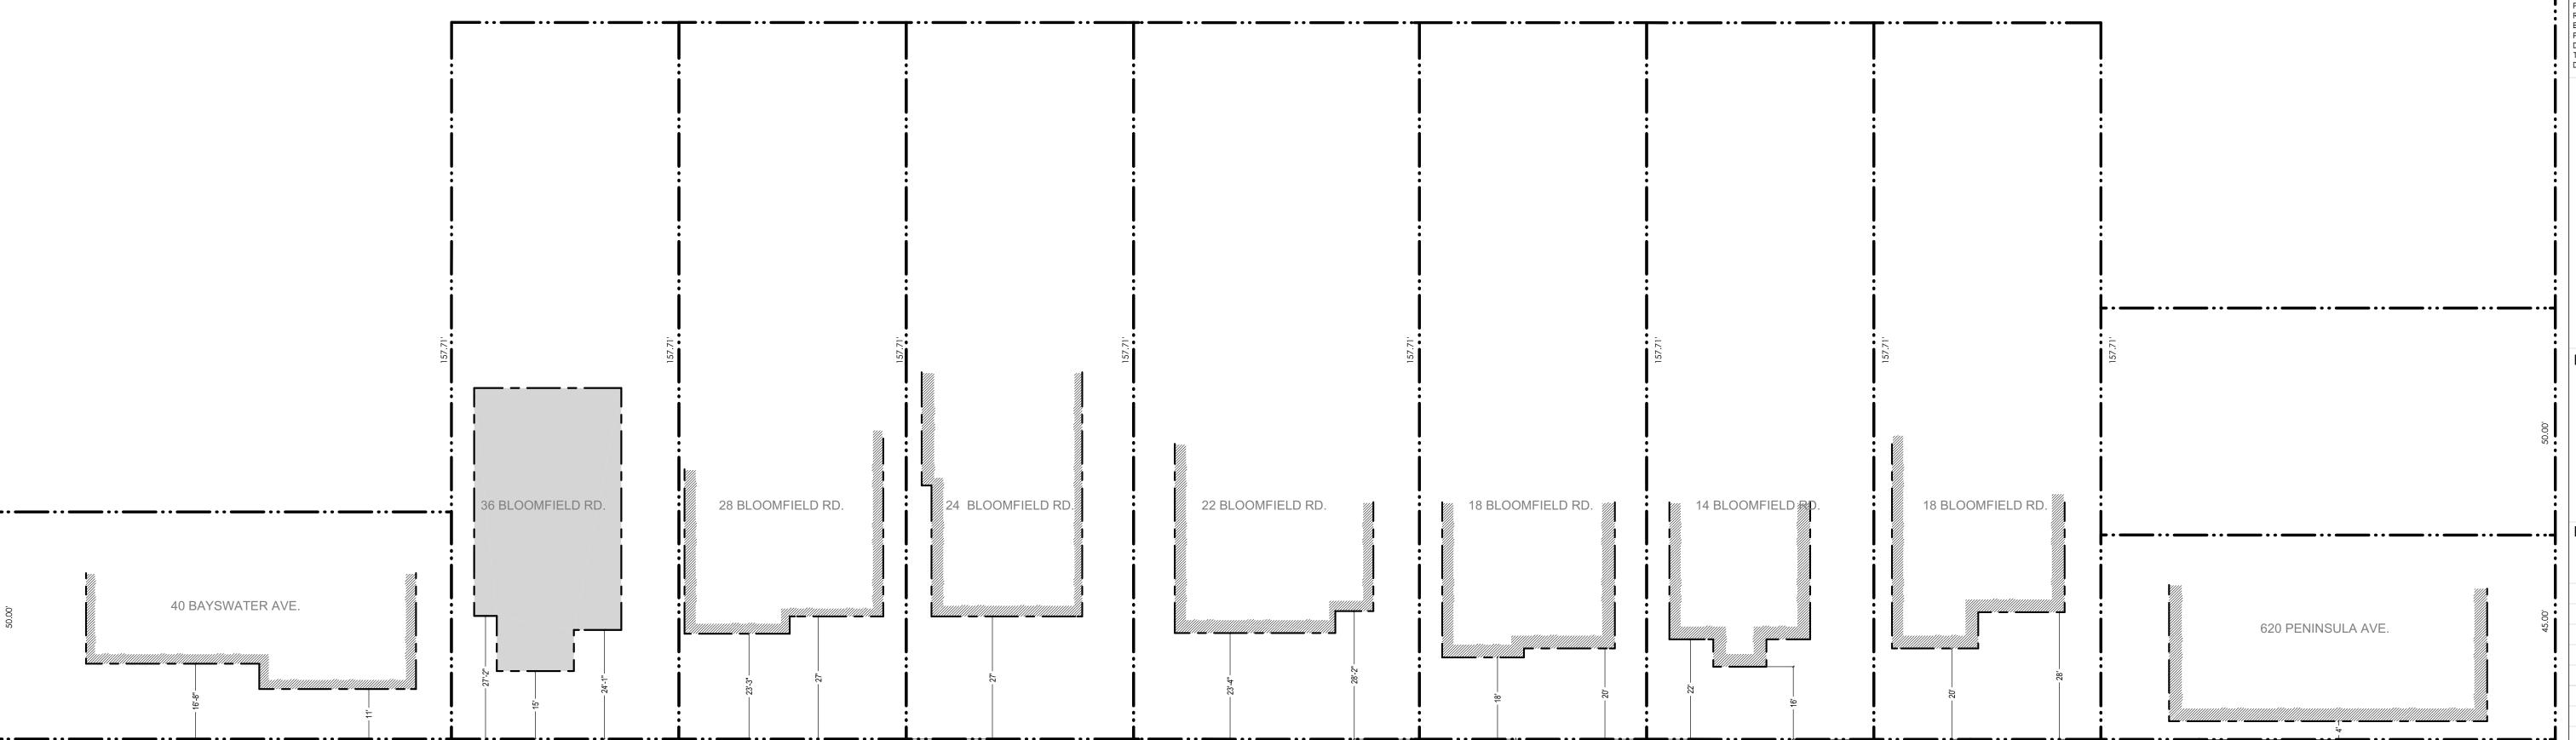

BLOOMFIELD RD.

BLOCK AVERAGE FOR FRONT SETBACK

SETBACK INFORMATION:

SETBACKS	EXISTING	PROPOSED 1ST / PROPOSED 2ND	ALLOWED 1ST FLR. / ALLOWED 2ND FLR.
FRONT	15'	15' / 28'-9"	20' AVERAGE BLOCK
REAR	80'-6"	80'-6" / 86'-6"	4' / 4'
RIGHT	12'-8"	12'-8" / 12'-8"	4' / 4'
LEFT	5'	5' / 5'-8"	15' / 20'
MAIN HOUSE TO ADU		32'-8"	

	ABBREVIATIONS				
	DESCRIPTION		DESCRIPTION		
AB AC AD BFOW BOW CCCCCCCCCCCCCCCCCCCCCCCCCCCCCCCCCCCC	CENTERLINE SWALE CLEANOUT CONTROL POINT DRIVEWAY DROP INLET DETAIL ELECTRIC EDGE OF PAVEMENT ELEVATION EUCALYPTUS TREE	IP N N N N N N N N N N N N N N N N N N N	PROPERTY LINE POWER POLE PLASTIC PERFORATED PIPE PUBLIC SERVICE EASEMENT POLYVINYL CHLORIDE RIGHT OF WAY REINFORCED CONCRETE PIPE STORM DRAIN STORM DRAIN MANHOLE STANDARD SANITARY SEWER		

LEGEND

EXISTING	PROPOSED	DESCRIPTION
		PROPERTY LINE
——— F———	——— F———	FILL AREA LIMIT
C	C	CUT AREA LIMIT
		CONTOUR
W	W	WATER LINE
———SD— —	———SD— —	STORM DRAIN PIPE (SOLID)
SS	———— SS ————	SANITARY SEWER PIPE
SUD -	——SUD →	SUBDRAIN PIPE (PERFORATED)
— ⊖ OH e,T,TV	─────────────────────────────────────	OVERHEAD UTILITIES WITH POLE
———— G ———	——— G ———	GAS LINE
——— E ———	——— E ———	ELECTRIC LINE (UNDERGROUND)
JT ——— SLV	——— JT ———	JOINT TRENCH (UNDERGROUND) STREET LIGHT VAULT
○ SSCO	● SSCO	SANITARY SEWER CLEANOUT
	•	SANITARY SEWER MANHOLE
\odot	lacktriangle	STORM DRAIN MANHOLE
		SURVEY CITY MONUMENT
	\swarrow	ELECTROLIER
WM	⋈ wм	WATER METER
		TREE WITH TRUNK
— x — x —	— x — x —	6' WOODEN FENCE
×102.23	102.23	SPOT ELEVATION
		TREE PROTECTION FENCE 5' TALL CHAIN LINK
		EARTHSWALE
		CONCRETE SWALE
		AREA DRAIN/ INLET
	\Rightarrow	OVERLAND RELEASE PATH
		GRADE TO DRAIN, 2% MIN. AWAY FROM HOUSE 1% MIN. FROM PROPERTY LINE TO SWALE
		(E) TREE TO BE REMOVE
	8	DOWN-SPOUT
	•	POP-UP EMITTER
	0	ROOF DOWN-SPOUT, CONNECTED TO STORM DRAIN SYSTEM

GRADING AND DRAINAGE PLANS ADDITION SINGLE FAMILY HOUSE 36 BLOOMFIELD RD., BURLINGAME, CA 94010

APN: 029-293-260

GRADING AND DRAINAGE NOTES:

- 1. SURFACE WATER SHALL BE DIRECTED AWAY FROM ALL BUILDINGS INTO DRAINAGE SWALES, GUTTERS, STORM DRAIN INLETS AND DRAINAGE SYSTEMS.
- 2. ALL ROOF DOWNSPOUTS SHALLI BE DISCONNECTED TO ON SITE INLETS.
- 3. ON SITE STORM DRAIN LINES SHALL CONSIST OF SOLID PVC-SDR35 MINIMUM OR BETTER.
 4. STORM DRAIN INLETS SHALL BE PRECAST CONCRETE, CHRISTY U23 TYPE OR EQUIVALENT.

UTILITY NOTES:

- 1. UTILITY POINTS OF CONNECTION ARE 5' OUTSIDE OF BUILDING. SEE MECHANICAL AND PLUMBING DRAWINGS FOR UTILITY CONNECTION.
- 2. CONTRACTOR SHALL BE RESPONSIBLE FOR THE VERIFICATION OF LOCATIONS OF ALL EXISTING UTILITIES IN THE FIELD. ALL CONTRACTORS SHALL CALL U.S.A. (1-800-227-2600) 48 HOURS BEFORE DIGGING AND OBTAIN AN IDENTIFICATION NUMBER.
- 3. COORDINATE UTILITIES SHOWN ON THESE SHEETS WITH INSTALLATION OF ELECTRICAL, TELEPHONE, CABLE TV AND GAS.
- 4. COORDINATE WATER LINE CONNECTION WITH CITY WATER COMPANY PRIOR TO CONNECTION TO WATER SYSTEM.
- 5. FOR GAS AND ELECTRICAL LOCATIONS, SEE PG&E MAPS.
- 6. ALL UTILITY TRENCHES SHOULD BE BACKFILLED WITH COMPACTED FILL IN ACCORDANCE WITH LOCAL REQUIREMENTS OR THE RECOMMENDATIONS IN THE SOILS REPORT. FILL MATERIAL SHOULD BE PLACED IN LIFTS NOT EXCEEDING 8 INCHES IN UNCOMPACTED THICKNESS AND SHOULD BE COMPACTED TO AT LEAST 90 PERCENT RELATIVE COMPACTION (ASTM D-1557, LATEST EDITION) BY MECHANICAL MEANS ONLY, EXCEPT WHERE LOCAL REQUIREMENTS SPECIFY HIGHER REQUIREMENTS. IF IMPORTED SAND IS USED AS BACKFILL, THE UPPER THREE FEET IN BUILDING AND PAVEMENT AREAS SHALL BE COMPACTED TO 95 PERCENT. THE UPPER 6 INCHES OF BACKFILL IN ALL PAVEMENT AREAS SHALL BE COMPACTED TO AT LEAST 95 PERCENT RELATIVE COMPACTION.
- 7. SANITARY SEWER PIPE SHALL BE PVC SDR26 FOR ON SITE LINES. STORM DRAIN PIPE SHALL BE 12" REINFORCED CONCRETE PIPE (UNLESS OTHERWISE SHOWN).
- 8. SANITARY SEWER LATERAL SHALL BE 4" PVC AT MINIMUM SLOPE OF 0.02 WITH CLEANOUT.
- 9. WATER MAINS, SERVICES, METERS, FIRE SERVICES AND FIRE HYDRANTS BY CITY WATER COMPANY.
- 10. THE CONTRACTOR IS RESPONSIBLE TO HAVE ALL INSTALLATIONS INSPECTED AND APPROVED BY THE RESPECTIVE UTILITY COMPANY, MUNICIPALITY, OR SOILS ENGINEER PRIOR TO ANY BACK FILLING. (48 HOUR NOTICE).
- 11. CONSULT PARTICIPATING UTILITIES, SOILS ENGINEER, AND THE CITY FOR APPROVED BACK FILL MATERIAL. COMPACTION TO MEET LOCAL AGENCIES REQUIREMENTS.
- 12. THE CONTRACTOR IS RESPONSIBLE FOR COORDINATION OF CONSTRUCTION WITH THE RESPECTIVE UTILITY AGENCIES, ALLOWING 48 HOURS PRIOR TO THE NEED FOR INSTALLATIONS.
- 13. ALL TRENCHES, CONDUITS, AND BOXES ARE SHOWN SCHEMATICALLY.
- 14. CONTRACTOR TO VERIFY ALL INVERTS AND LOCATIONS OF UTILITIES PRIOR TO CONSTRUCTION.

GEOTECHNICAL REVIEW:

GRADING AND DRAINAGE PLANS SHALL BE REVIEWED AND APPROVED BY THE PROJECT GEOTECHNICAL/ SOILS ENGINEER. GEOTECHNICAL/ SOILS ENGINEER TO PROVIDE AND FURNISH LETTER OF APPROVAL TO CITY.

UTILITY NOTE:

THE UTILITIES EXISTING ON THE SURFACE AND SHOWN ON THIS DRAWING HAVE BEEN LOCATED BY FIELD SURVEY. ALL UNDERGROUND UTILITIES SHOWN ON THIS DRAWING ARE FROM RECORDS OF THE VARIOUS UTILITY COMPANIES AND THE SURVEYOR DOES NOT ASSUME RESPONSIBILITY FOR THEIR COMPLETENESS, INDICATED LOCATION, OR SIZE. RECORD UTILITY LOCATION SHOULD BE CONFIRMED BY EXPOSING THE UTILITY.

NOTE:

CONSTRUCTION HOURS IN THE CITY PUBLIC RIGHT-OF-WAY ARE LIMITED TO WEEKDAYS AND NON-CITY HOLIDAYS BETWEEN 8:00 A.M. AND 5:00 P.M.



INDEX OF DRAWINGS

<u>TITLE</u>	SHEET
COVER SHEET	C - 1
GRADING AND DRAINAGE PLAN	C-2
DETAILS	C-3
EROSION CONTROL PLAN	C-4
CONSTRUCTION BMP	C-5

BASIS OF BEARINGS:

FOUND SURVEY MONUMENTS. RECORD INFORMATION WAS USED. PER RECORD MAP, BOOK/VOL (LLS): 46 PAGE: 28 WHICH IS FILED IN THE COUNTY OF SAN MATEO RECORDER'S OFFICE.

PROJECT BENCHMARK:

NGS BENCHMARK BM # 0556
ELEVATION=30.8' (NAVD 88 DATUM)

SITE BENCHMARK:

SURVEY CONTROL SET MAG NAIL ELEVATION=27.90' (NAVD 88 DATUM)

GEOTECHNICAL NOTES:

- 1. For compacted fill material and placement specifications see "GRADING" section, pages 7 and 8, of project Geotechnical report, (file no. SV1303), dated September 23,2014 by Silicon Valley Soils Engineering.
- 2. Provide special inspection for compacted fill.

EARTHWORK TABLE

	FILL (CY)	CUT (CY)	IMPORT (CY)	EXPORT (CY)
MAIN HOUSE	1	0		
DRIVEWAY	0	24		
PORCH	2	0		
PATIO/WKY	0	9		
SITE	5	0		
TOTAL	8	33	0	25

NOTE:

1. EARTHWORK QUANTITIES ON THIS TABLE ARE FOR INFORMATION ONLY. CONTRACTORS ARE TO PERFORM THEIR OWN QUANTITY TAKE OFFS.

NOTICE TO CONTRACTORS

CONTRACTOR TO NOTIFY U.S.A. (UNDERGROUND SERVICE ALERT) AT 800-227-2600 A MINIMUM OF 2 WORKING DAYS BEFORE BEGINNING UNDERGROUND WORK FOR VERIFICATION OF THE LOCATION AND DEPTH OF UNDERGROUND UTILITIES.



SNIP ENGINEERS CIVIL ENGINEERS LAND SURVEYORS

1534 CAROB LANE LOS ALTOS, CA 94024 TEL: (650) 941-8055 FAX: (650) 941-8755

OWNER / DEVELOPER:


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CIVIL ENGINEERS

SE , CA 94010

MFIELD RD, BURLINGAME, CAMPIELD RD, BURLINGAME, CAMPIELD RD, 293-260

Revision

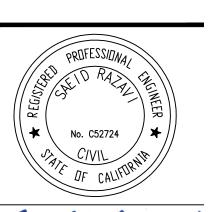

Gueid Razam


Date: 06/09/2023 Scale: AS SHOWN


PREPARED BY: S.S. CHECKED BY: S.R.

Sheet:

223011

C-1

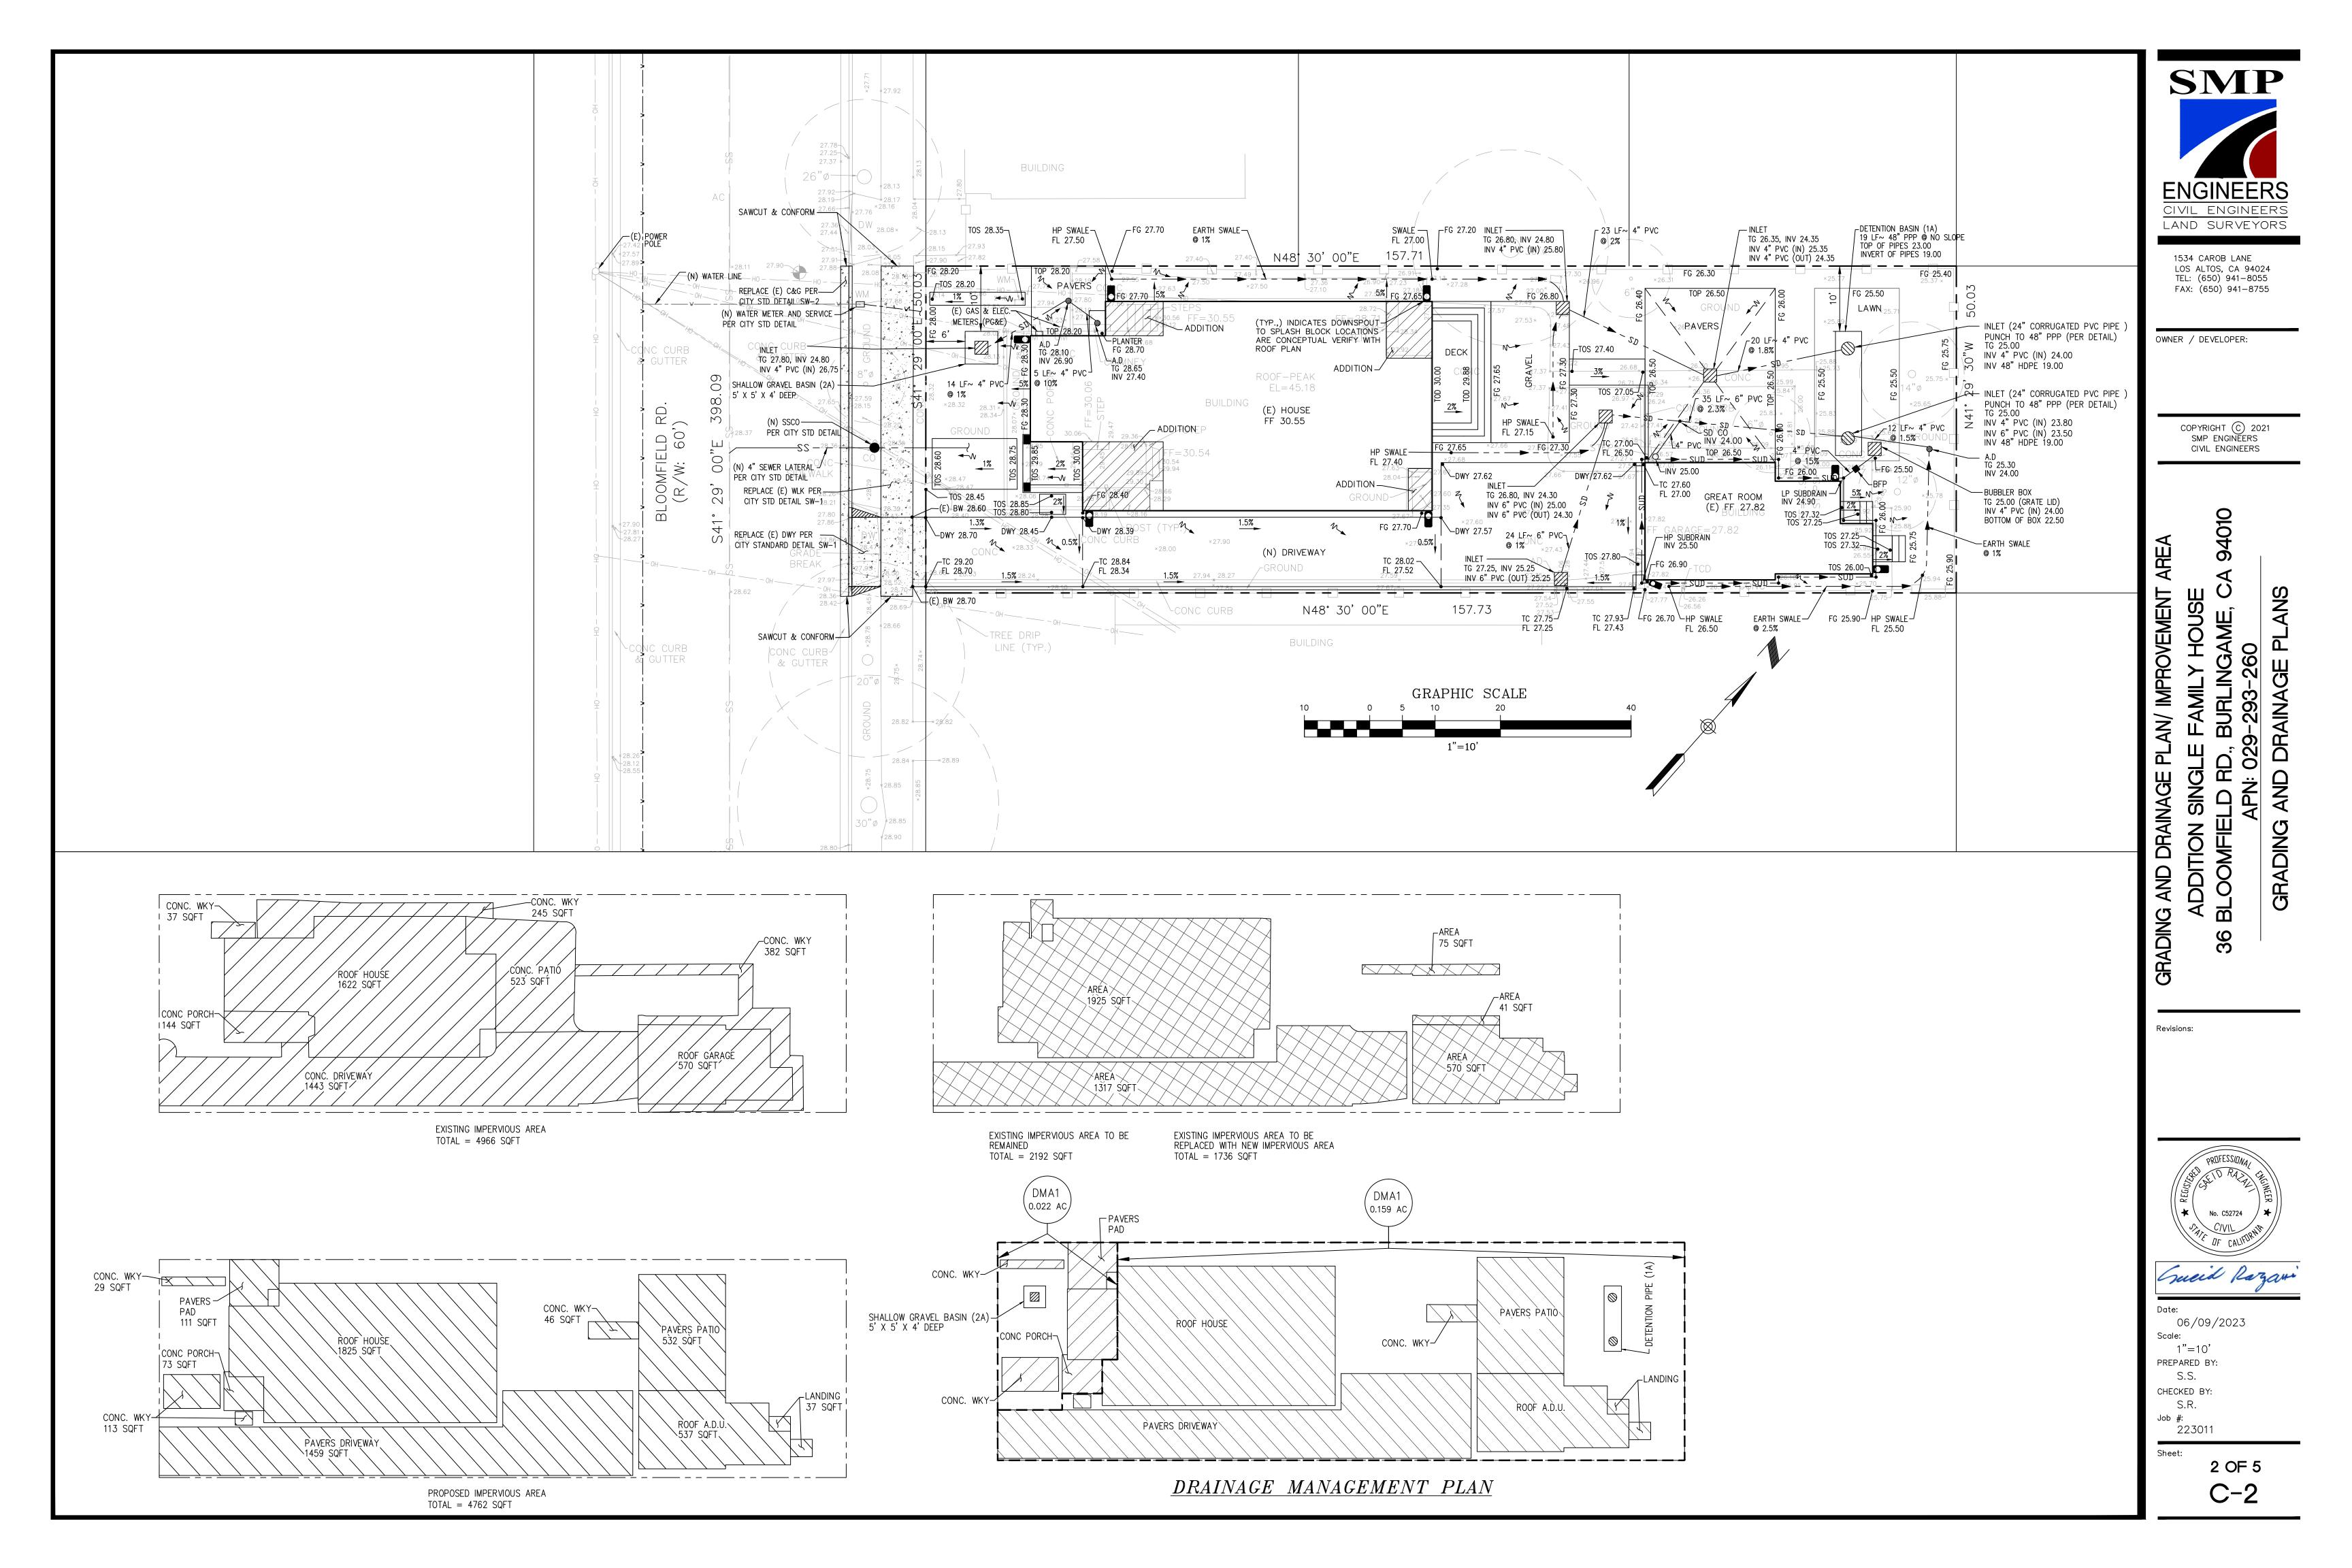

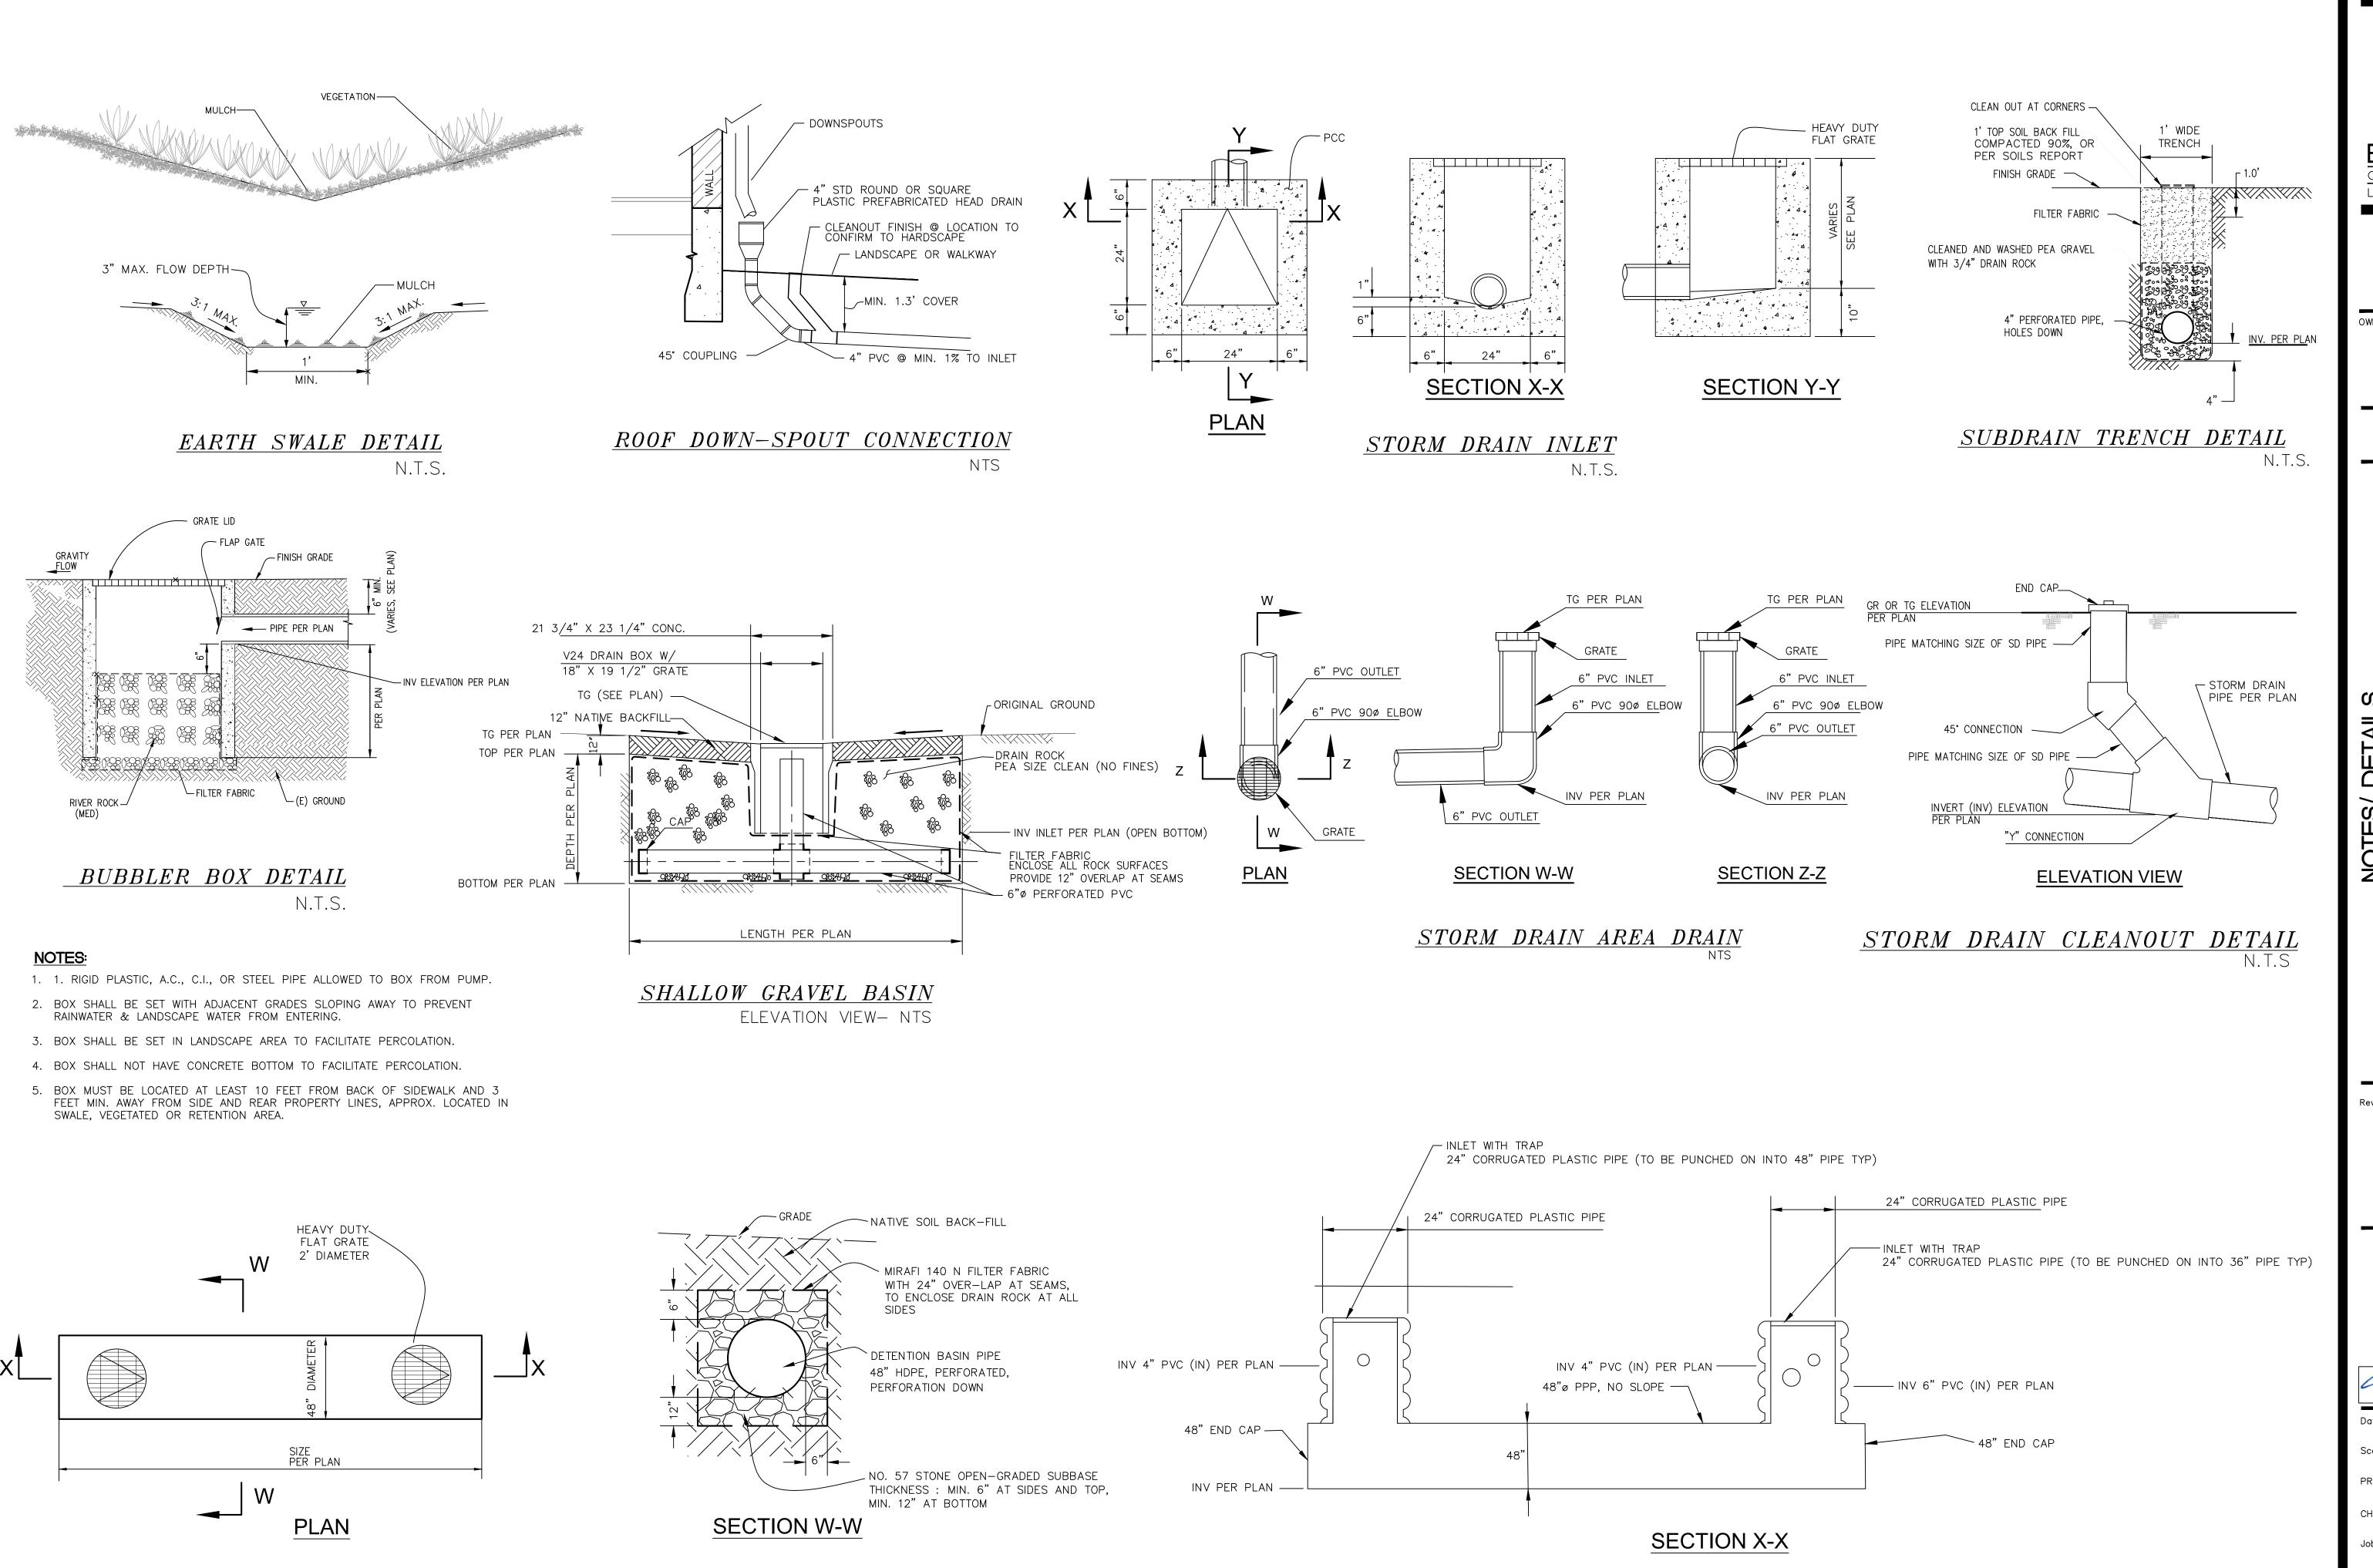

STORM DRAIN INLET & DETENTION PIPE

SMP CIVIL ENGINEERS LAND SURVEYORS

> 1534 CAROB LANE LOS ALTOS, CA 94024 TEL: (650) 941-8055 FAX: (650) 941-8755

OWNER / DEVELOPER:

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Sucid Razani

06/09/2023 AS SHOWN PREPARED BY:


S.S. CHECKED BY: S.R.

223011

N.T.S.

Sheet:

3 OF 5 C-3

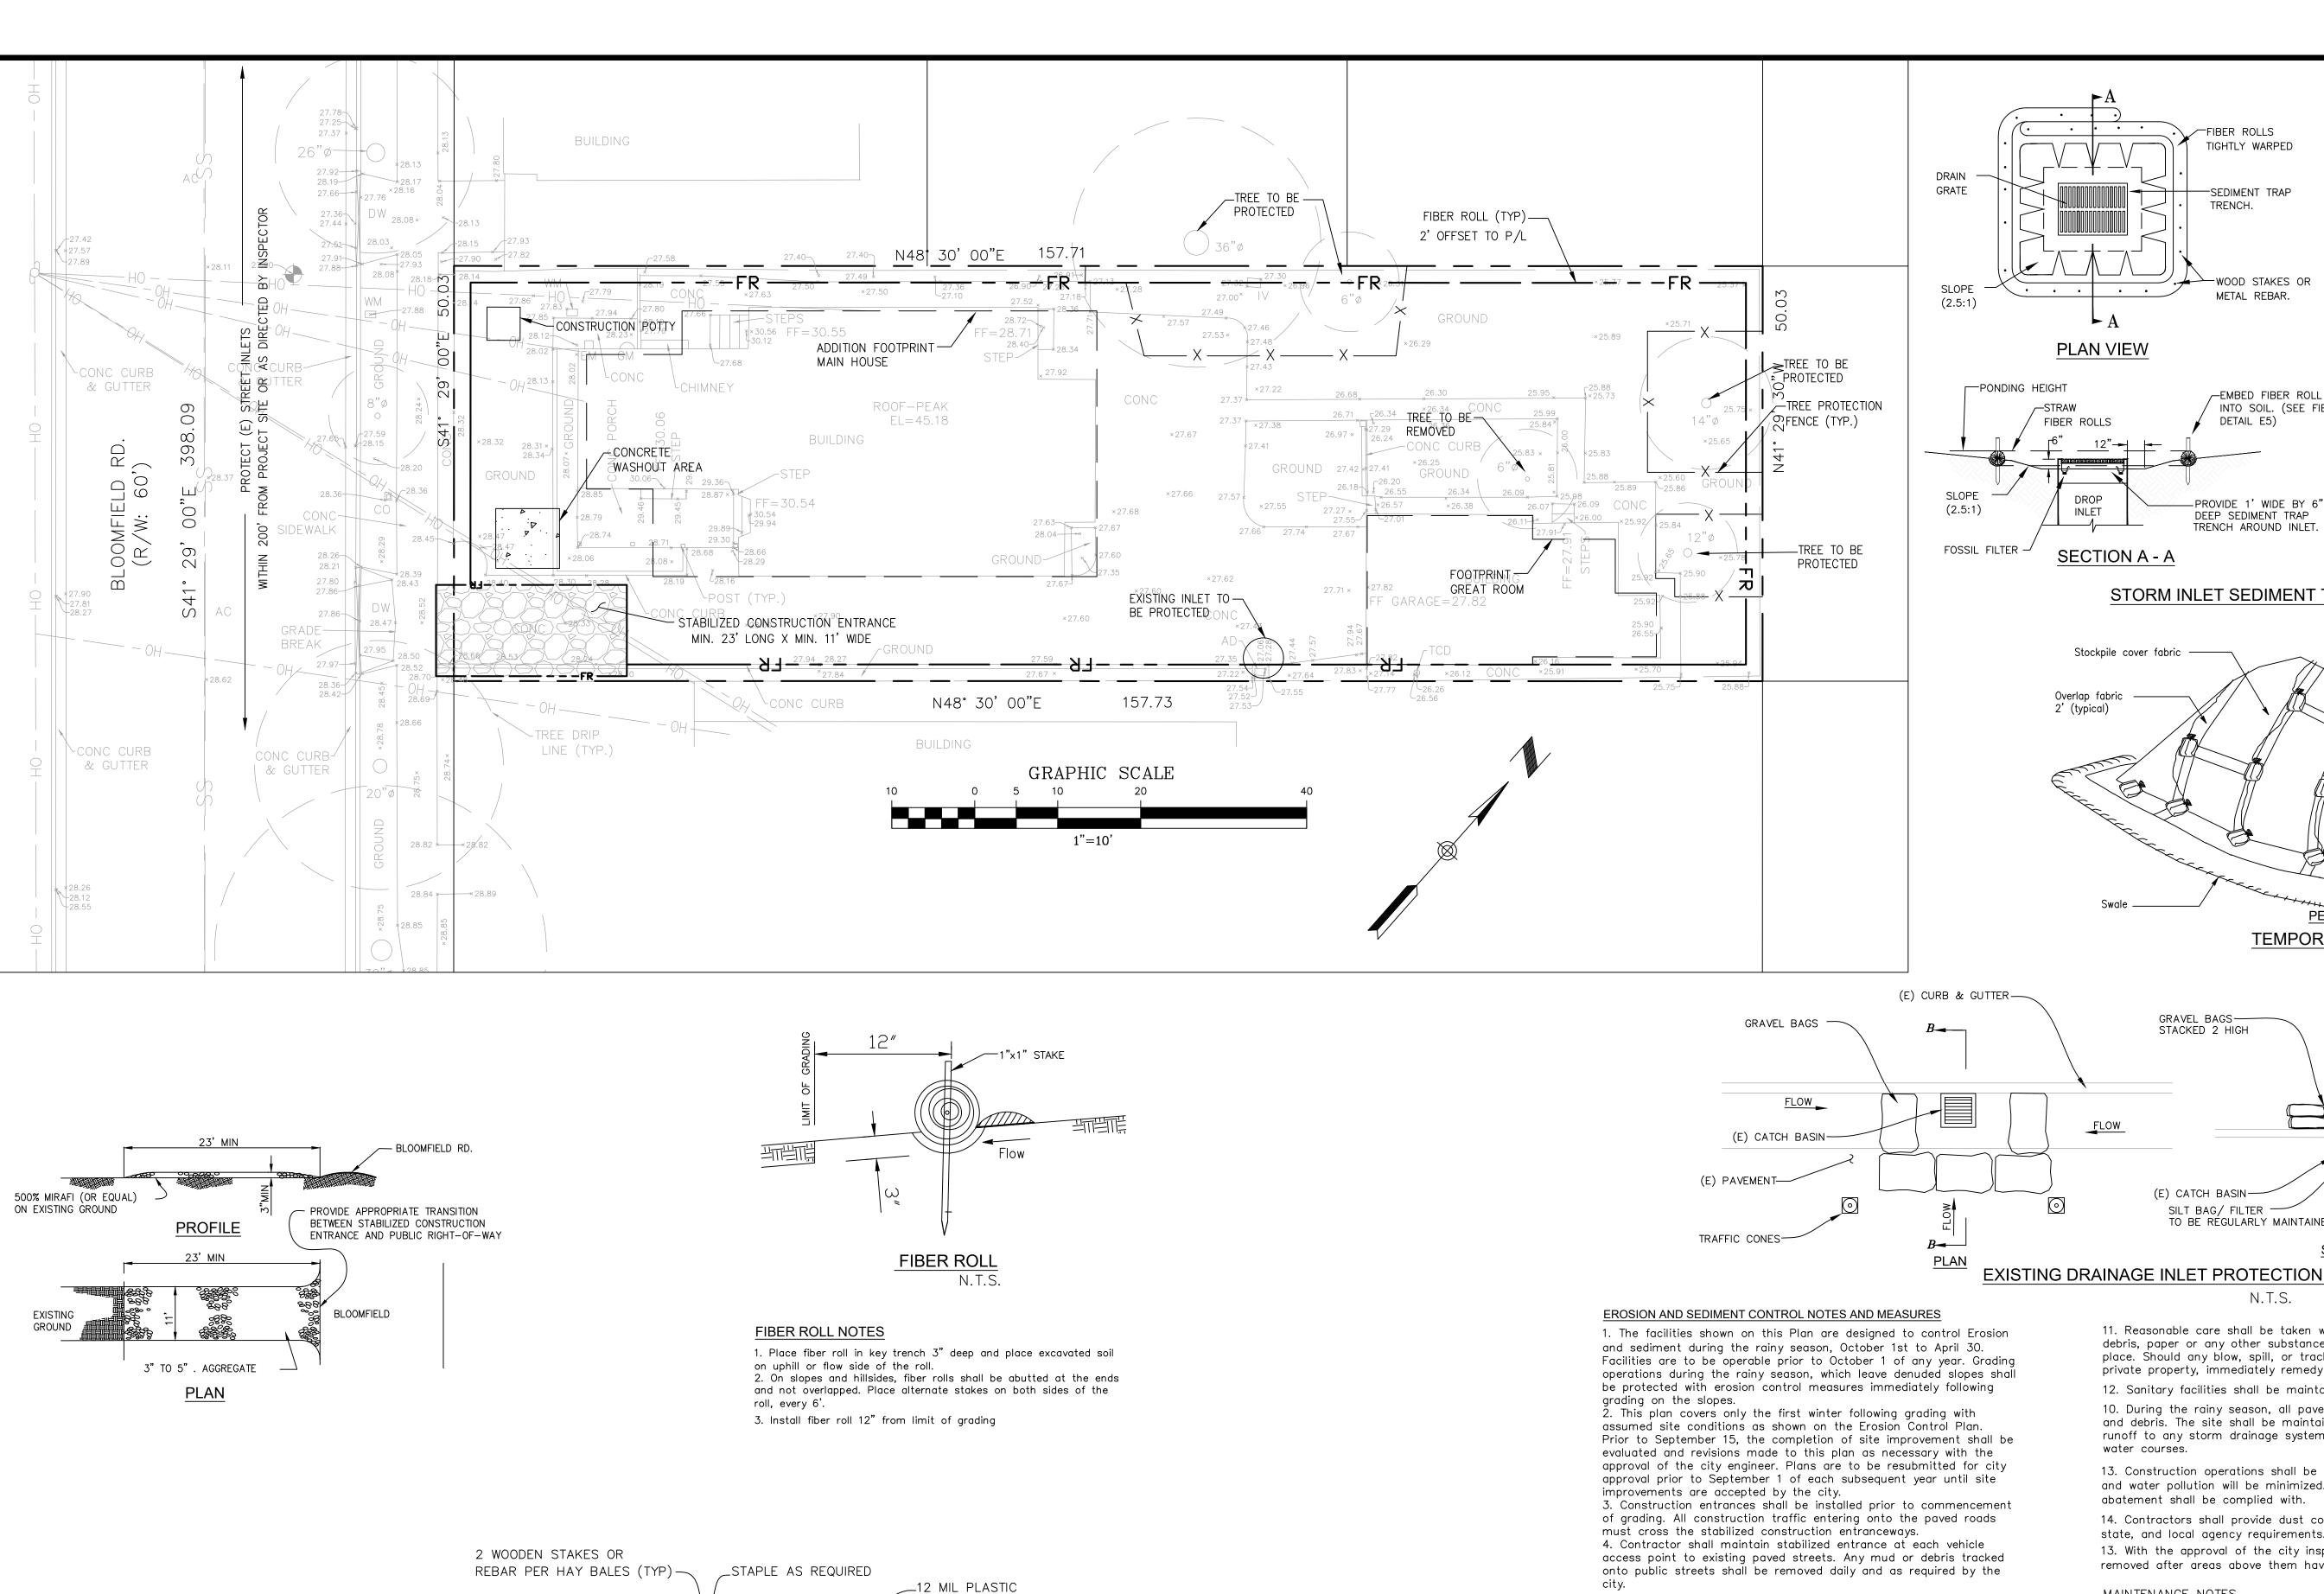

STACKED HAY BALES (2)

— The entrance shall be maintained in a condition that will prevent

tracking or flowing sediment onto public rights—of—way. This may

demand, and repair and/or clean out any measures used to trap

require periodic top dressing with additional stone as conditions

- All sediment spilled, dropped, washed, or tracked onto public

- When necessary, wheels shall be cleaned to remove sediment

prior to entrance onto public rights—of—way. This shall be done at an area stabilized with crushed stone, which drains into an

STABILIZED CONSTRUCTION ENTRANCE

(TO BE MAINTAINED)

rights—of—way shall be removed immediately.

approved sediment trap or sediment basin.

WEIGHT IN CORNERS

CONCRETE WASHOUT AREA

WEDGE LOOSE STRAW —

BETWEEN HAY BALES

12 MIL PLASTIC LINING —

WEIGHT IN CORNERS ____

ROUGH WOODEN FRAME

NATIVE MATERIAL -


-STACKED HAY BALES

-REUSABLE ROUGH

WOODEN FRAME

FIBER ROLLS TIGHTLY WARPED -SEDIMENT TRAP TRENCH. -WOOD STAKES OR METAL REBAR.

PLAN VIEW

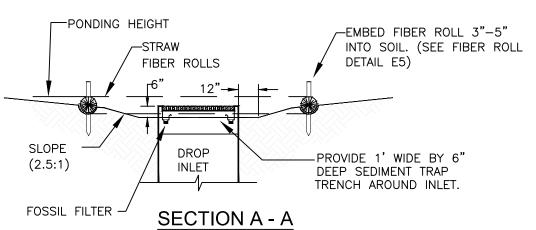

Stockpile cover fabric

Overlap fabric

FLOW

2' (typical)

STORM INLET SEDIMENT TRAP-FIBER ROLLS

1. PLACE FIBER ROLLS AROUND THE INLET CONSISTENT WITH BASIN SEDIMENT BARRIER DETAIL ON THIS SHEET. FIBER ROLLS ARE TUBES MADE FROM STRAW BOUND W/ PLASTIC NETTING. THEY ARE APPROX. 8" DIA. AND 20 -16 FT. LONG

2. FIBER ROLL INSTALLATION REQUIRES THE PLACEMENT AND SECURE STAKING OF THE FIBER ROLL IN A TRENCH, 3" DEEP, DUG ON CONTOUR. RUNOFF MUST NOT BE ALLOWED TO RUN UNDER OR AROUND FIBER ROLL.

3. THE TOP OF THE STRUCTURE (PONDING HEIGHT) MUST BE WELL BELOW THE GROUND ELEVATION DOWNSLOPE TO PREVENT RUNOFF FROM BY-PASSING 1 INLET. EXCAVATION OF A BASIN ADJACENT TO THE DROP INLET OR A TEMPORARY DIKE ON THE DOWNSLOPE OF THE STRUCTURE MAY BE NECESSARY.

Secure fabric with

staples, rock bags, or similar weight

4. FOSSIL FILTERS SHALL BE INCORPORATED IN ALL CATCH BASINS AND FIELD INLETS 24" AND LARGER AND SHALL BE INSTALLED PER MANUFACTURER SPECIFICATIONS. FOSSIL FILTERS ARE AVAILABLE FROM KRISTAR ENTERPRISES INC., 422 LARKFIELD CENTER, SUITE 271 SANTA ROSA, CA 95403, PHONE (800) 579-8819.

N.T.S.

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CIVIL ENGINEERS

SMP

CIVIL ENGINEERS

LAND SURVEYORS

1534 CAROB LANE

OWNER / DEVELOPER:

LOS ALTOS, CA 94024

TEL: (650) 941-8055

FAX: (650) 941-8755

TEMPORARY COVER ON STOCK PILE

GRAVEL BAGS-STACKED 2 HIGH GRAVEL BAGS (PEA SIZE, CLEAN) STACKED ONE HIGH AT WEIR OPENING

PERSPECTIVE

No. C52724

06/09/2023 Scale: AS NOTED

PREPARED BY: S.S. CHECKED BY:

S.R.

223011

Sheet: 4 OF 5

1. The facilities shown on this Plan are designed to control Erosion Facilities are to be operable prior to October 1 of any year. Grading operations during the rainy season, which leave denuded slopes shall

Prior to September 15, the completion of site improvement shall be approval of the city engineer. Plans are to be resubmitted for city approval prior to September 1 of each subsequent year until site

access point to existing paved streets. Any mud or debris tracked onto public streets shall be removed daily and as required by the

5. If hydroseeding is not used or or is not effectively 10/10, then

other immediate methods shall be implemented, such as Erosion

control blankets, or a three—step application of: 1) seed, mulch, fertilizer 2) blown straw 3) tackifier and mulch. 6. Inlet protection shall be installed at open inlets to prevent sediment from entering the storm drain system. Inlets not used in

conjunction with erosion control are to be blocked to prevent entry of sediment. 7. Lots with houses under construction will not be hydroseeded Erosion protection for each lot with a house under construction shall

control prior, during, and after storm events.

confirm to the Typical Lot Erosion Control Detail shown on this sheet. 8. This erosion and sediment control plan may not cover all the situations that may arise during construction due to unanticipated field conditions. Variations and additions may be made to this plan in the field. Notify the city representative of any field changes.

9. This plan is intended to be used for interim erosion and sediment control only and is not to be used for final elevations or permanent improvements. 10. Contractor shall be responsible for monitoring erosion and sediment

11. Reasonable care shall be taken when hauling any earth, sand, gravel, stone, debris, paper or any other substance over any public street, alley or other public place. Should any blow, spill, or track over and upon said public or adjacent private property, immediately remedy shall occur.

SECTION B-B

12. Sanitary facilities shall be maintained on the site. 10. During the rainy season, all paved areas shall be kept clear of earth material and debris. The site shall be maintained so as to minimize sediment laden

runoff to any storm drainage systems, including existing drainage swales and water courses. 13. Construction operations shall be carried out in such a manner that erosion and water pollution will be minimized. State and local laws concerning pollution

abatement shall be complied with. 14. Contractors shall provide dust control as required by the appropriate federal,

state, and local agency requirements. 13. With the approval of the city inspector, erosion and sediment controls maybe

removed after areas above them have been stabilized.

MAINTENANCE NOTES

1. Maintenance is to be performed as follows:

(E) CATCH BASIN-

SILT BAG/ FILTER -

TO BE RÉGULARLY MAINTAINED

N.T.S.

A. Repair damages caused by soil erosion or construction at the end of each working day.

B. Swales shall be inspected periodically and maintained as needed. C. Sediment traps, berms, and swales are to be inspected after each storm and repairs made as needed.

D. Sediment shall be removed and sediment traps restored to its original dimensions when sediment has accumulated to a depth of

E. Sediment removed from trap shall be deposited in a suitable area and in such a manner that it will not erode.

F. Rills and gullies must be repaired. 2. All existing drainage inlets on St. George Lane within the limit of the project , shall be protected with sand bags during construction. See

detail. Sand bag inlet protection shall be cleaned out whenever sediment

depth is one half the height of one sand bag. 3. Existing concrete ditch sediment trap shall be cleaned out routinely during construction.




Construction Best Management Practices (BMPs)

Construction projects are required to implement the stormwater best management practices (BMP) on this page, as they apply to your project, all year long.

Clean Water. Healthy Community.

Materials & Waste Management

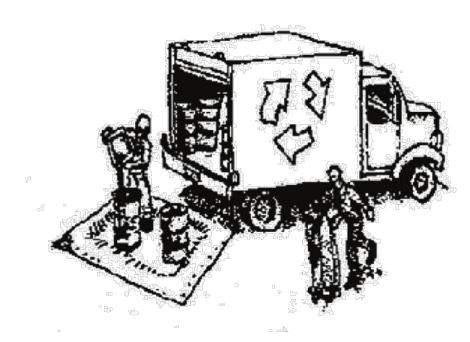

Non-Hazardous Materials

- ☐ Berm and cover stockpiles of sand, dirt or other construction material with tarps when rain is forecast or if not actively being used within
- ☐ Use (but don't overuse) reclaimed water for dust control.

Hazardous Materials

- ☐ Label all hazardous materials and hazardous wastes (such as pesticides, paints, thinners, solvents, fuel, oil, and antifreeze) in accordance with city, county, state and federal regulations.
- ☐ Store hazardous materials and wastes in water tight containers, store in appropriate secondary containment, and cover them at the end of every work day or during wet weather or when rain is forecast.
- ☐ Follow manufacturer's application instructions for hazardous materials and be careful not to use more than necessary. Do not apply chemicals outdoors when rain is forecast within 24 hours.
- ☐ Arrange for appropriate disposal of all hazardous wastes.

Waste Management

- ☐ Cover waste disposal containers securely with tarps at the end of every work day and during wet weather.
- ☐ Check waste disposal containers frequently for leaks and to make sure they are not overfilled. Never hose down a dumpster on the construction site.
- ☐ Clean or replace portable toilets, and inspect them frequently for leaks and spills.
- ☐ Dispose of all wastes and debris properly. Recycle materials and wastes that can be recycled (such as asphalt, concrete, aggregate base materials, wood, gyp board, pipe, etc.)
- ☐ Dispose of liquid residues from paints, thinners, solvents, glues, and cleaning fluids as hazardous waste.

Construction Entrances and Perimeter

- ☐ Establish and maintain effective perimeter controls and stabilize all construction entrances and exits to sufficiently control erosion and sediment discharges from site and tracking off site.
- ☐ Sweep or vacuum any street tracking immediately and secure sediment source to prevent further tracking. Never hose down streets to clean up tracking.

Equipment Management & Spill Control




Maintenance and Parking

- ☐ Designate an area, fitted with appropriate BMPs, for vehicle and equipment parking and storage.
- ☐ Perform major maintenance, repair jobs, and vehicle and equipment washing off site.
- ☐ If refueling or vehicle maintenance must be done onsite, work in a bermed area away from storm drains and over a drip pan or drop cloths big enough to collect fluids. Recycle or dispose of fluids as hazardous waste
- ☐ If vehicle or equipment cleaning must be done onsite, clean with water only in a bermed area that will not allow rinse water to run into gutters, streets, storm drains, or surface waters.
- ☐ Do not clean vehicle or equipment onsite using soaps, solvents, degreasers, or steam cleaning equipment.

Spill Prevention and Control

- ☐ Keep spill cleanup materials (e.g., rags, absorbents and cat litter) available at the construction site at all times.
- ☐ Inspect vehicles and equipment frequently for and repair leaks promptly. Use drip pans to catch leaks until repairs are made.
- ☐ Clean up spills or leaks immediately and dispose of cleanup materials properly.
- ☐ Do not hose down surfaces where fluids have spilled. Use dry cleanup methods (absorbent materials, cat litter, and/or rags).
- ☐ Sweep up spilled dry materials immediately. Do not try to wash them away with water, or bury them.
- ☐ Clean up spills on dirt areas by digging up and properly disposing of contaminated soil.
- ☐ Report significant spills immediately. You are required by law to report all significant releases of hazardous materials, including oil. To report a spill: 1) Dial 911 or your local emergency response number, 2) Call the Governor's Office of Emergency Services Warning Center, (800) 852-7550 (24 hours).

Earthmoving

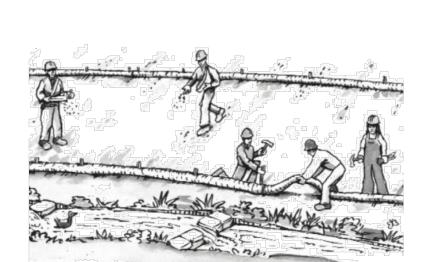


- ☐ Schedule grading and excavation work during dry weather.
- ☐ Stabilize all denuded areas, install and maintain temporary erosion controls (such as erosion control fabric or bonded fiber matrix) until vegetation is established.
- ☐ Remove existing vegetation only when absolutely necessary, and seed or plant vegetation for erosion control on slopes or where construction is not immediately planned.
- ☐ Prevent sediment from migrating offsite and protect storm drain inlets, gutters, ditches, and drainage courses by installing and maintaining appropriate BMPs, such as fiber rolls, silt fences, sediment basins, gravel bags, berms, etc.
- ☐ Keep excavated soil on site and transfer it to dump trucks on site, not in the streets.

Contaminated Soils

- ☐ If any of the following conditions are observed, test for contamination and contact the Regional Water Quality Control Board:
- Unusual soil conditions, discoloration, or odor.
- Abandoned underground tanks.
- Abandoned wells
 - Buried barrels, debris, or trash.

Paving/Asphalt Work

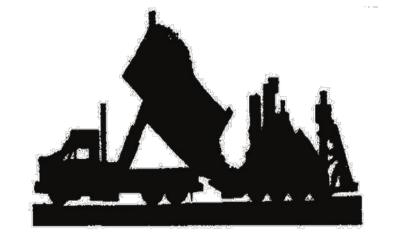


- ☐ Avoid paving and seal coating in wet weather or when rain is forecast, to prevent materials that have not cured from contacting stormwater runoff.
- ☐ Cover storm drain inlets and manholes when applying seal coat, tack coat, slurry seal, fog seal, etc.
- ☐ Collect and recycle or appropriately dispose of excess abrasive gravel or sand. Do NOT sweep or wash it into gutters.
- ☐ Do not use water to wash down fresh asphalt concrete pavement.

Sawcutting & Asphalt/Concrete Removal


- ☐ Protect nearby storm drain inlets when saw cutting. Use filter fabric, catch basin inlet filters, or gravel bags to keep slurry out of the storm drain system.
- ☐ Shovel, abosorb, or vacuum saw-cut slurry and dispose of all waste as soon as you are finished in one location or at the end of each work day (whichever is sooner!).
- ☐ If sawcut slurry enters a catch basin, clean it up immediately.

Concrete, Grout & Mortar

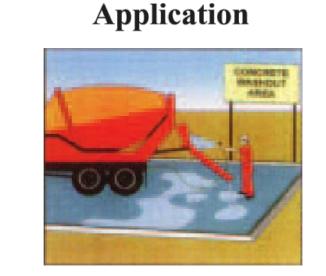


- ☐ Store concrete, grout, and mortar away from storm drains or waterways, and on pallets under cover to protect them from rain, runoff, and wind.
- ☐ Wash out concrete equipment/trucks offsite or in a designated washout area, where the water will flow into a temporary waste pit, and in a manner that will prevent leaching into the underlying soil or onto surrounding areas. Let concrete harden and dispose of as garbage.
- ☐ When washing exposed aggregate, prevent washwater from entering storm drains. Block any inlets and vacuum gutters, hose washwater onto dirt areas, or drain onto a bermed surface to be pumped and disposed of properly.

Landscaping

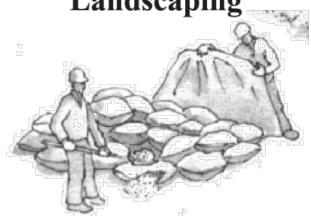

- ☐ Protect stockpiled landscaping materials from wind and rain by storing them under tarps all year-round.
- ☐ Stack bagged material on pallets and under cover.
- ☐ Discontinue application of any erodible landscape material within 2 days before a forecast rain event or during wet weather.

Painting & Paint Removal

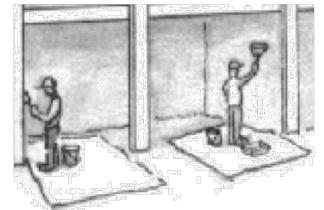


Painting Cleanup and Removal

- ☐ Never clean brushes or rinse paint containers into a street, gutter, storm drain, or stream.
- ☐ For water-based paints, paint out brushes to the extent possible, and rinse into a drain that goes to the sanitary sewer. Never pour paint down a storm drain.
- ☐ For oil-based paints, paint out brushes to the extent possible and clean with thinner reuse thinners and solvents. Dispose of excess liquids as hazardous waste.
- dry stripping and sand blasting may be swept up or collected in plastic drop cloths and disposed of as trash.
- ☐ Chemical paint stripping residue and chips and dust from marine paints or paints containing lead, mercury, or tributyltin must be disposed of as hazardous waste. certified contractor.




- ☐ Discharges of groundwater or captured runoff from dewatering operations must be properly managed and disposed. When possible send dewatering discharge to landscaped area or sanitary sewer. If discharging to the sanitary sewer call your local wastewater treatment plant.
- ☐ Divert run-on water from offsite away
- ☐ When dewatering, notify and obtain approval from the local municipality before discharging water to a street gutter or storm drain. Filtration or diversion through a basin, tank, or sediment trap may be required.

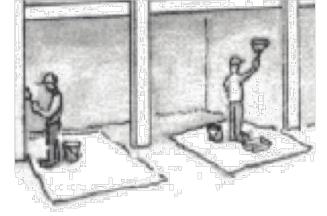

- or solvent in a proper container. Filter and
- ☐ Paint chips and dust from non-hazardous
- Lead based paint removal requires a state-

Dewatering

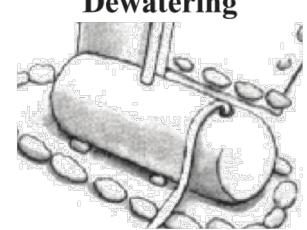

from all disturbed areas.

- ☐ In areas of known or suspected contamination, call your local agency to determine whether the ground water must be tested. Pumped groundwater may need to be collected and hauled off-site for treatment and proper disposal

Storm drain polluters may be liable for fines of up to \$10,000 per day!

CIVIL ENGINEERS LAND SURVEYORS 1534 CAROB LANE LOS ALTOS, CA 94024

SMP

FAX: (650) 941-8755

OWNER / DEVELOPER

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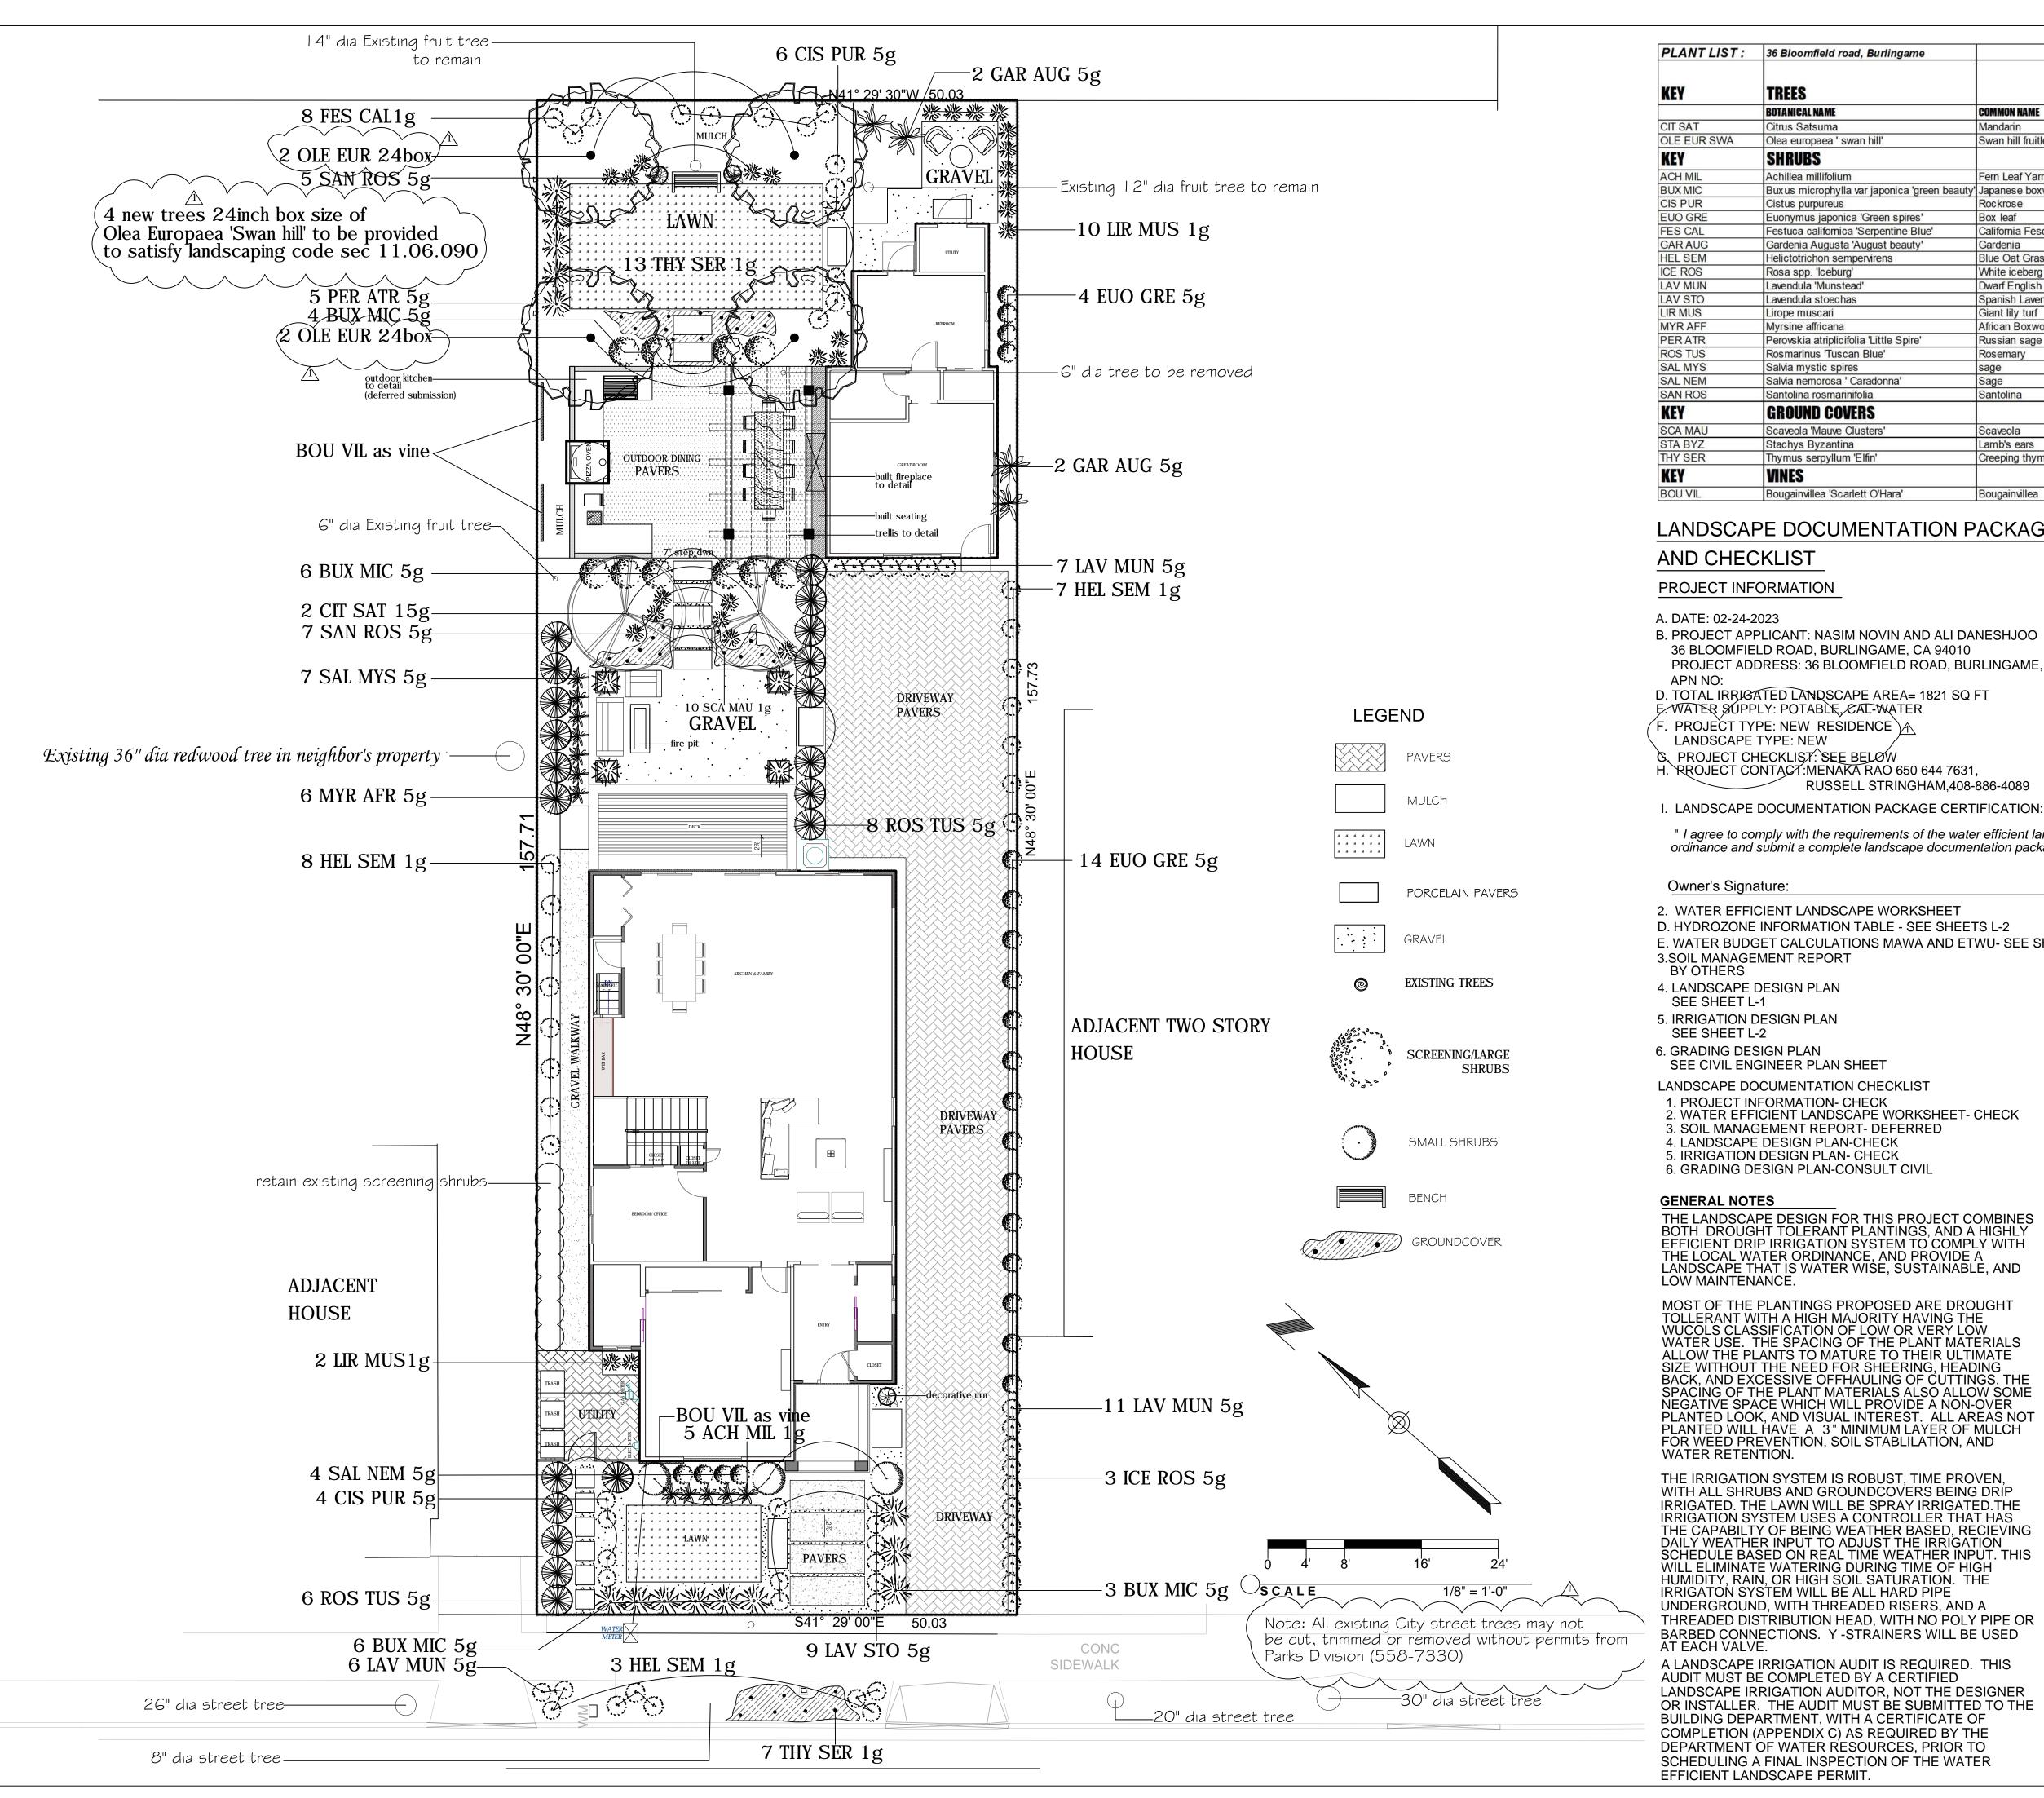


06/09/2023

PREPARED BY: S.S. CHECKED BY S.R.

223011

5 OF 5



PLANT LIST:	36 Bloomfield road, Burlingame		
			WUCOLS
KEY	TREES		Region 1
	BOTANICAL NAME	COMMON NAME	
CIT SAT	Citrus Satsuma	Mandarin	MOD
OLE EUR SWA	Olea europaea ' swan hill'	Swan hill fruitless olive	LOW
KEY	SHRUBS		
ACH MIL	Achillea millifolium	Fern Leaf Yarrow (Pink)	LOW
BUX MIC	Bux us microphylla var japonica 'green beauty'	Japanese boxwood	LOW
CIS PUR	Cistus purpureus	Rockrose	LOW
EUO GRE	Euonymus japonica 'Green spires'	Box leaf	LOW
FES CAL	Festuca californica 'Serpentine Blue'	California Fescue	LOW
GAR AUG	Gardenia Augusta 'August beauty'	Gardenia	MOD
HEL SEM	Helictotrichon sempervirens	Blue Oat Grass	LOW
ICE ROS	Rosa spp. 'lceburg'	White iceberg shrub rose	LOW
LAV MUN	Lavendula 'Munstead'	Dwarf English Lavender	LOW
LAV STO	Lavendula stoechas	Spanish Lavender	LOW
LIR MUS	Lirope muscari	Giant lily turf	MOD
MYR AFF	Myrsine affricana	African Boxwood	LOW
PERATR	Perovskia atriplicifolia 'Little Spire'	Russian sage	MOD
ROS TUS	Rosmarinus 'Tuscan Blue'	Rosemary	LOW
SAL MYS	Salvia mystic spires	sage	LOW
SAL NEM	Salvia nemorosa ' Caradonna'	Sage	LOW
SAN ROS	Santolina rosmarinifolia	Santolina	LOW
KEY	GROUND COVERS		
SCA MAU	Scaveola 'Mauve Clusters'	Scaveola	LOW
STA BYZ	Stachys Byzantina	Lamb's ears	LOW
THY SER	Thymus serpyllum 'Elfin'	Creeping thyme	LOW
KEY	VINES		
BOU VIL	Bougainvillea 'Scarlett O'Hara'	Bougainvillea	LOW
		Transport of the Control of the Cont	300 F 3 1 1 2 5 5 5

LANDSCAPE DOCUMENTATION PACKAGE

- B. PROJECT APPLICANT: NASIM NOVIN AND ALI DANESHJOO 36 BLOOMFIELD ROAD, BURLINGAME, CA 94010 PROJECT ADDRESS: 36 BLOOMFIELD ROAD, BURLINGAME, CA 94010
- D. TOTAL IRRIGATED LANDSCAPE AREA= 1821 SQ FT E. WATER SUPPLY: POTABLE, CAL-WATER
- F. PROJEČT TYPE: NEW RESIDENCE 🗽
- LANDSCAPE TYPE: NEW
- PROJECT CHECKLIST: SEE BELØW 1. RROJECT CONTACT:MENAKA RAO 650 644 7631,
- RUSSELL STRINGHAM,408-886-4089
- " I agree to comply with the requirements of the water efficient landscape ordinance and submit a complete landscape documentation package"

Owner's Signature: Date:

- 2. WATER EFFICIENT LANDSCAPE WORKSHEET
- D. HYDROZONE INFORMATION TABLE SEE SHEETS L-2
- E. WATER BUDGET CALCULATIONS MAWA AND ETWU- SEE SHEET L-3 3.SOIL MANAGEMENT REPORT
- BY OTHERS
- 4. LANDSCAPE DESIGN PLAN SEE SHEET L-1
- 5. IRRIGATION DESIGN PLAN
- SEE SHEET L-2
- 6. GRADING DESIGN PLAN
- SEE CIVIL ENGINEER PLAN SHEET LANDSCAPE DOCUMENTATION CHECKLIST
- 1. PROJECT INFORMATION- CHECK
- 2. WATER EFFICIENT LANDSCAPE WORKSHEET- CHECK
- 3. SOIL MANAGEMENT REPORT- DEFERRED 4. LANDSCAPE DESIGN PLAN-CHECK
- 5. IRRIGATION DESIGN PLAN- CHECK
- 6. GRADING DESIGN PLAN-CONSULT CIVIL

GENERAL NOTES

THE LANDSCAPE DESIGN FOR THIS PROJECT COMBINES BOTH DROUGHT TOLERANT PLANTINGS, AND A HIGHLY EFFICIENT DRIP IRRIGATION SYSTEM TO COMPLY WITH THE LOCAL WATER ORDINANCE, AND PROVIDE A LANDSCAPE THAT IS WATER WISE, SUSTAINABLE, AND LOW MAINTENANCE.

MOST OF THE PLANTINGS PROPOSED ARE DROUGHT TOLLERANT WITH A HIGH MAJORITY HAVING THE WUCOLS CLASSIFICATION OF LOW OR VERY LOW WATER USE. THE SPACING OF THE PLANT MATERIALS ALLOW THE PLANTS TO MATURE TO THEIR ULTIMATE SIZE WITHOUT THE NEED FOR SHEERING, HEADING BACK, AND EXCESSIVE OFFHAULING OF CUTTINGS. THE SPACING OF THE PLANT MATERIALS ALSO ALLOW SOME NEGATIVE SPACE WHICH WILL PROVIDE A NON-OVER PLANTED LOOK, AND VISUAL INTEREST. ALL AREAS NOT PLANTED LOOK, AND VISUAL INTEREST. ALL AREAS NOT PLANTED WILL HAVE A 3" MINIMUM LAYER OF MULCH FOR WEED PREVENTION, SOIL STABLILATION, AND WATER RETENTION.

THE IRRIGATION SYSTEM IS ROBUST, TIME PROVEN, WITH ALL SHRUBS AND GROUNDCOVERS BEING DRIP IRRIGATED. THE LAWN WILL BE SPRAY IRRIGATED. THE IRRIGATION SYSTEM USES A CONTROLLER THAT HAS THE CAPABILTY OF BEING WEATHER BASED, RECIEVING DAILY WEATHER INPUT TO ADJUST THE IRRIGATION SCHEDULE BASED ON REAL TIME WEATHER INPUT. THIS WILL ELIMINATE WATERING DURING TIME OF HIGH HUMIDITY, RAIN, OR HIGH SOIL SATURATION. THE IRRIGATON SYSTEM WILL BE ALL HARD PIPE UNDERGROUND, WITH THREADED RISERS, AND A THREADED DISTRIBUTION HEAD, WITH NO POLY PIPE OR BARBED CONNECTIONS. Y -STRAINERS WILL BE USED AT EACH VALVE.

A LANDSCAPE IRRIGATION AUDIT IS REQUIRED. THIS AUDIT MUST BE COMPLETED BY A CERTIFIED LANDSCAPE IRRIGATION AUDITOR, NOT THE DESIGNER OR INSTALLER. THE AUDIT MUST BE SUBMITTED TO THE BUILDING DEPARTMENT, WITH A CERTIFICATE OF COMPLETION (APPENDIX C) AS REQUIRED BY THE DEPARTMENT OF WATER RESOURCES, PRIOR TO SCHEDULING A FINAL INSPECTION OF THE WATER EFFICIENT LANDSCAPE PERMIT.




LANDSCAPE DESIGN

4653 MonteCarlo Park Court Fremont, CA 94538 Ph:650 644 7631

DRAWN BY: MENAKA RAO


SIGNED BY: RUSSELL STRINGHAM LA #3091_\

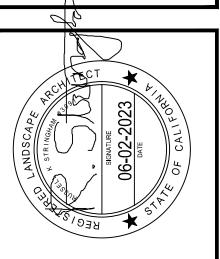

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1'	= 1/8"		

SHEET:

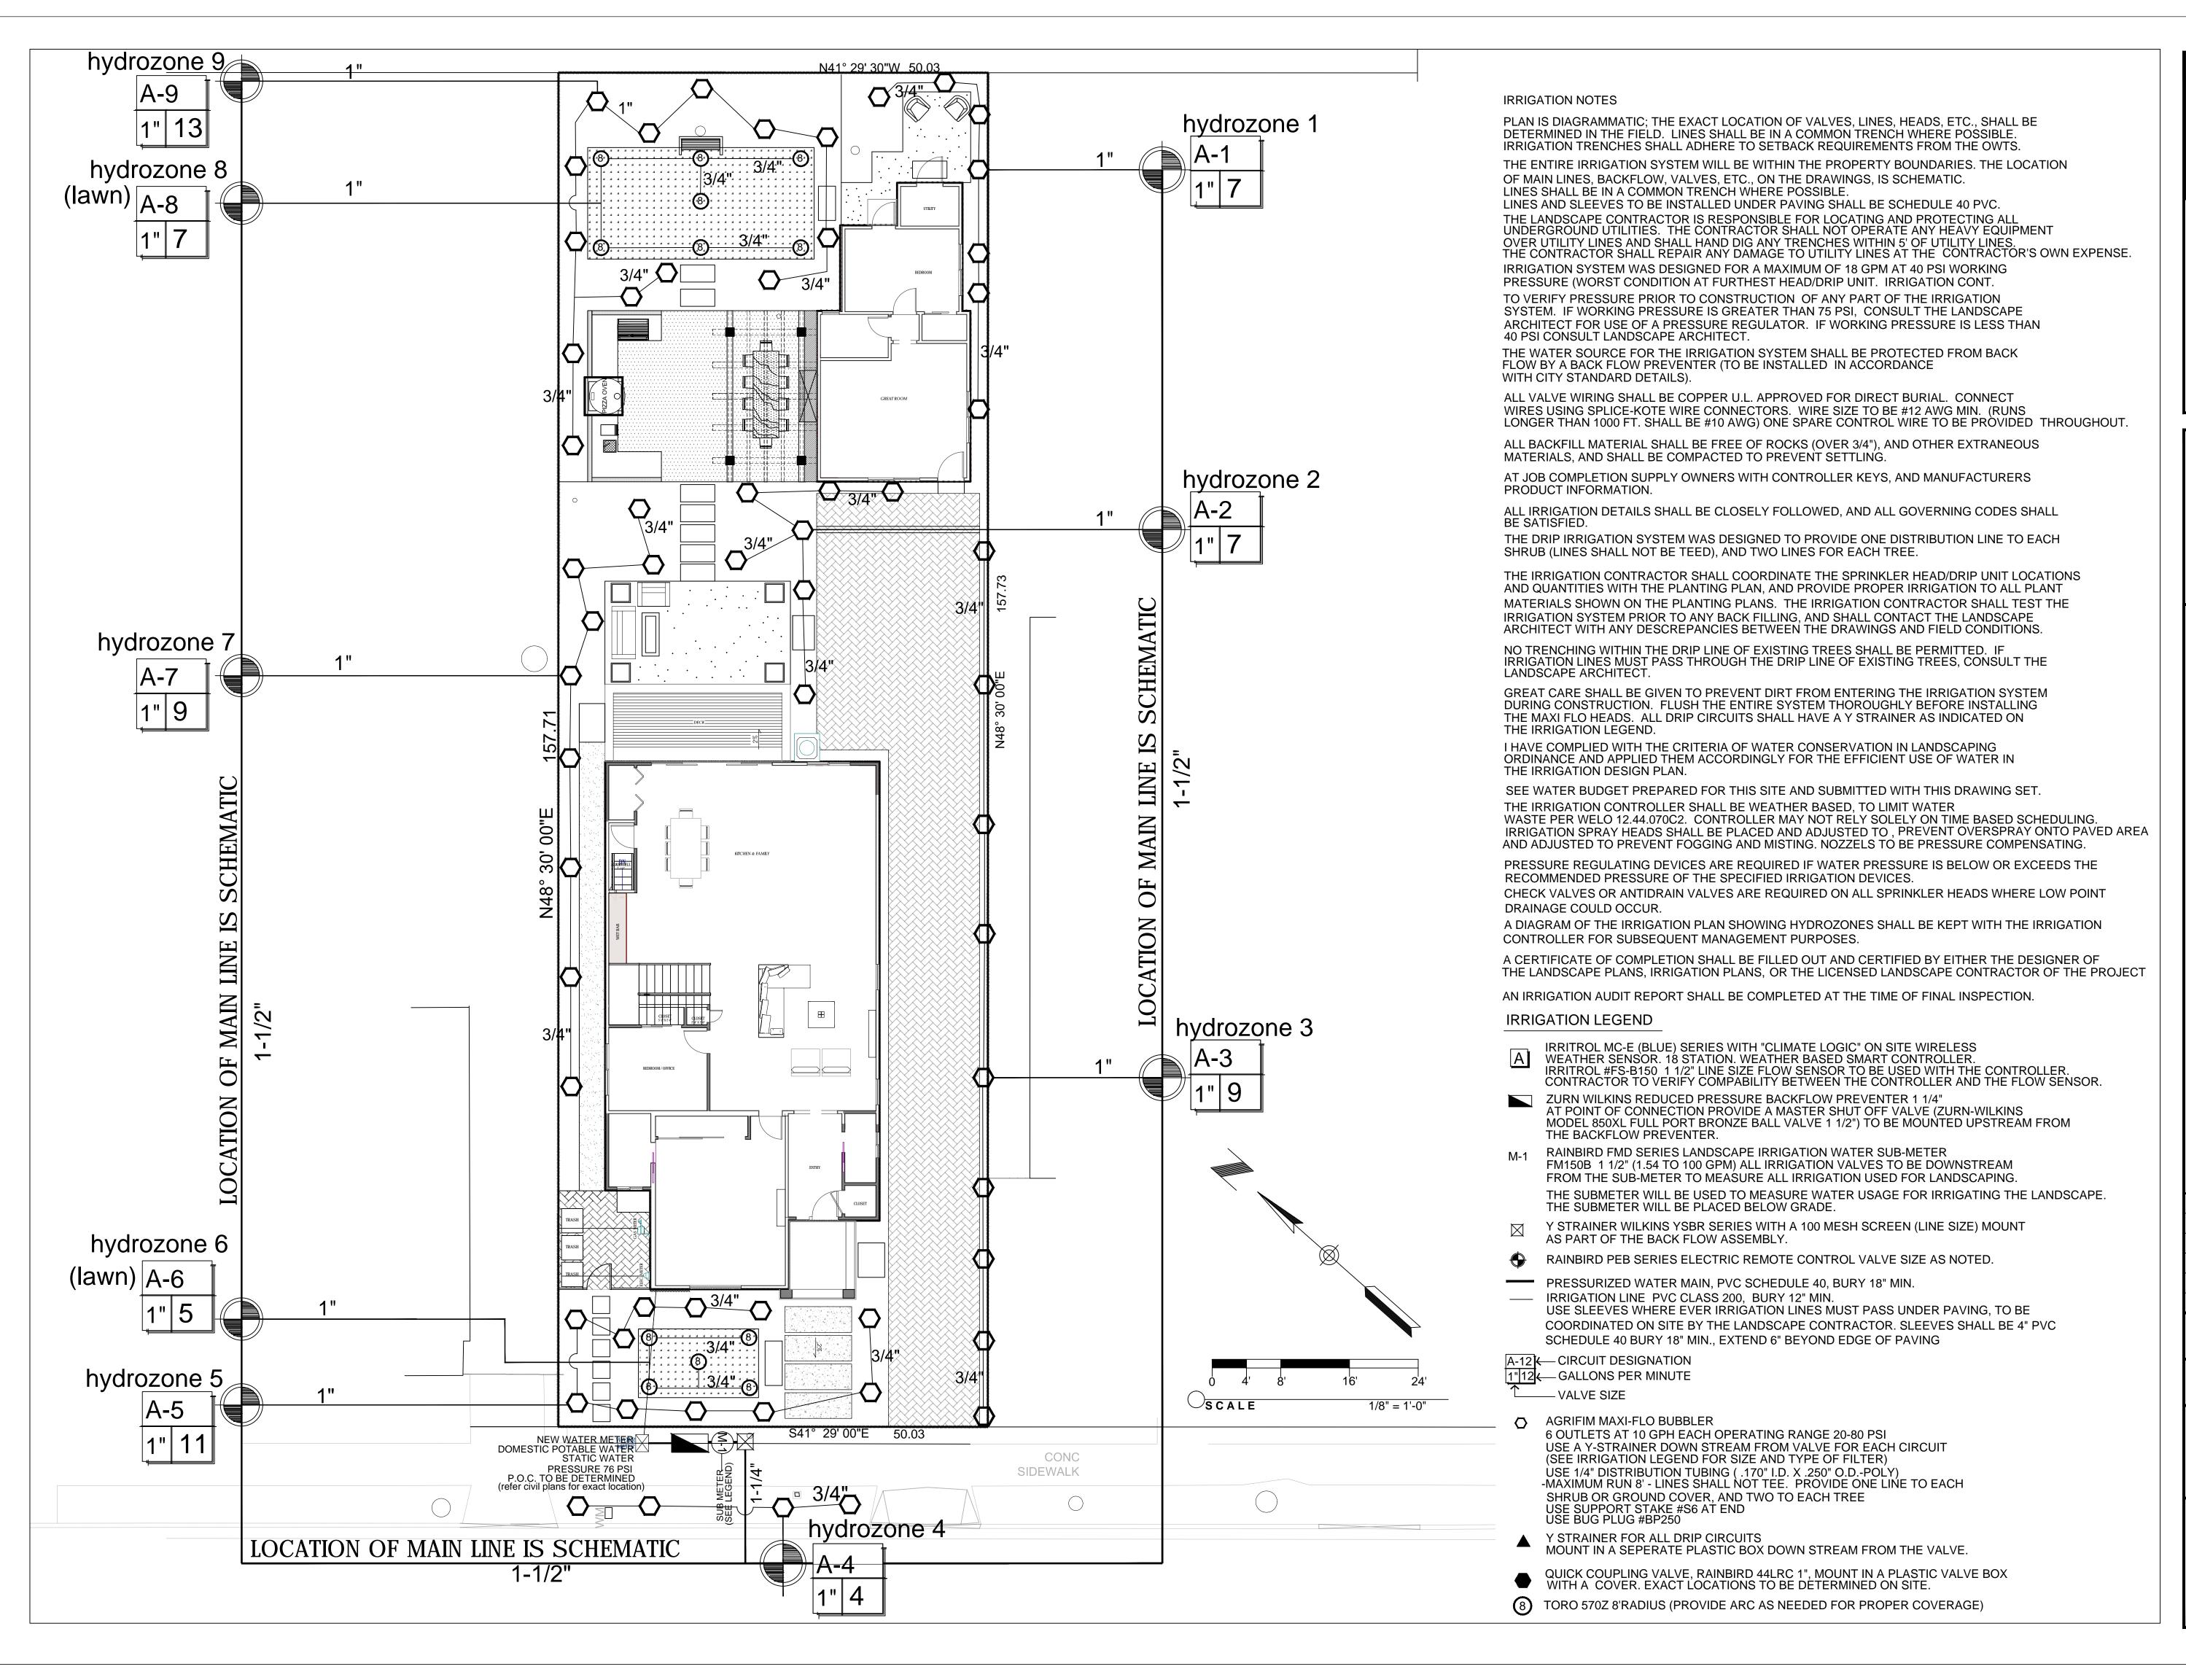

Menaka Rao


LANDSCAPE DESIGN

4653 MonteCarlo Park Court Fremont, CA 94538 Ph:650 644 7631

DRAWN BY: MENAKA RAO

SIGNED BY: RUSSELL STRINGHAM LA #3091_{\l}


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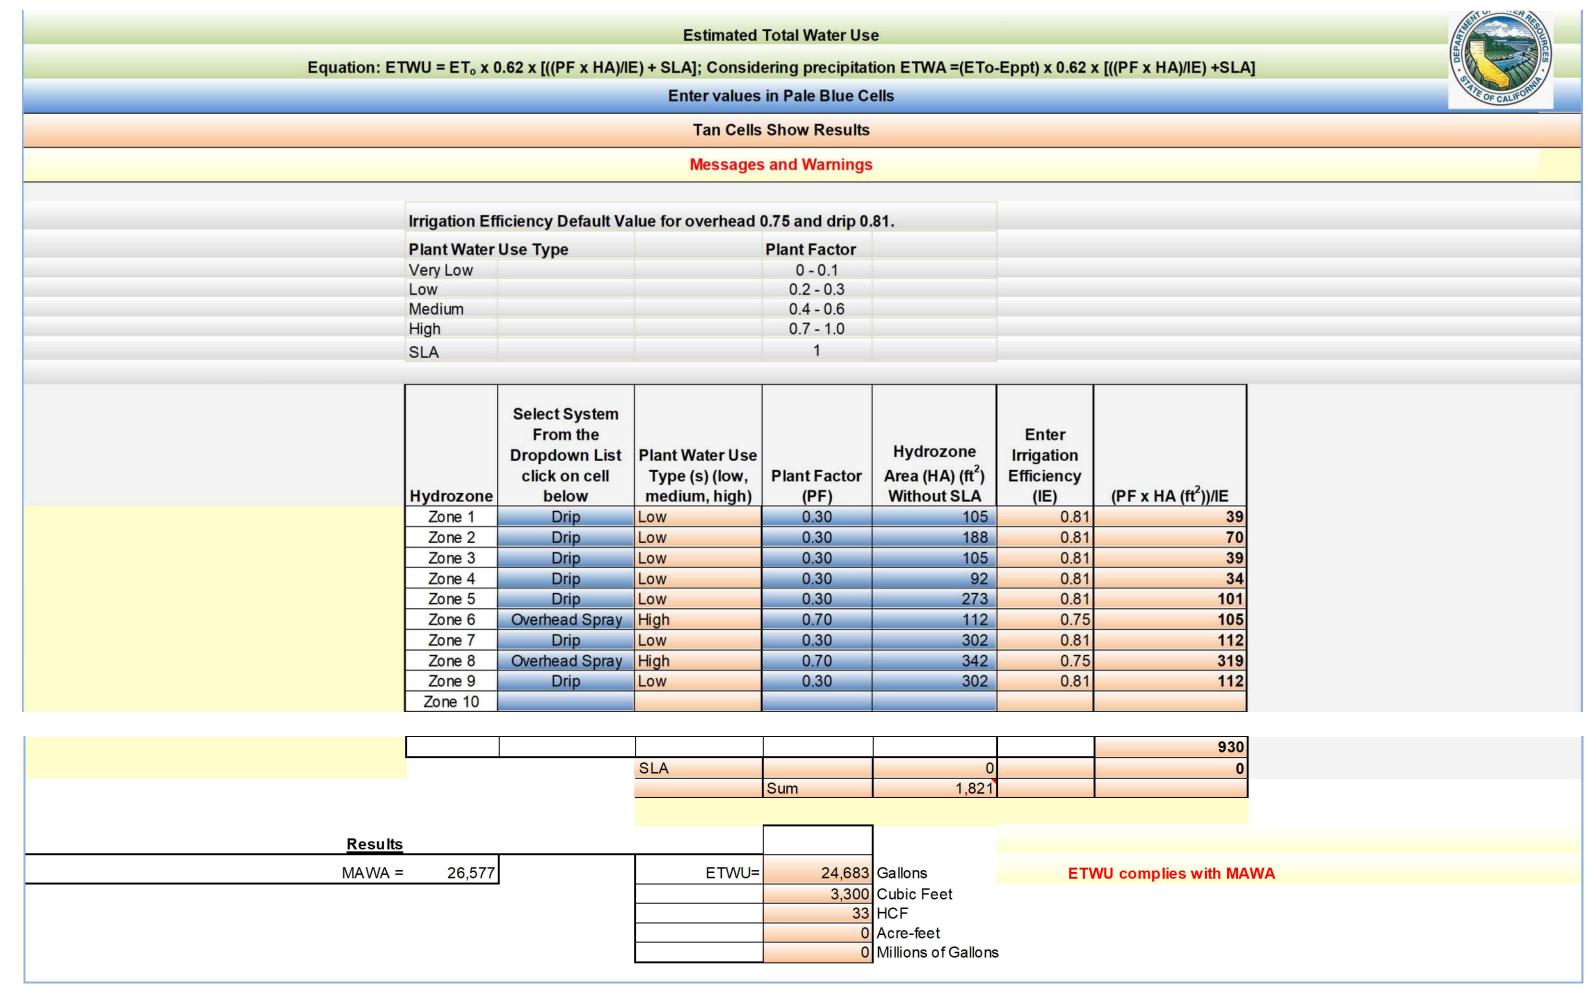


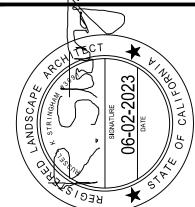
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SHEET:





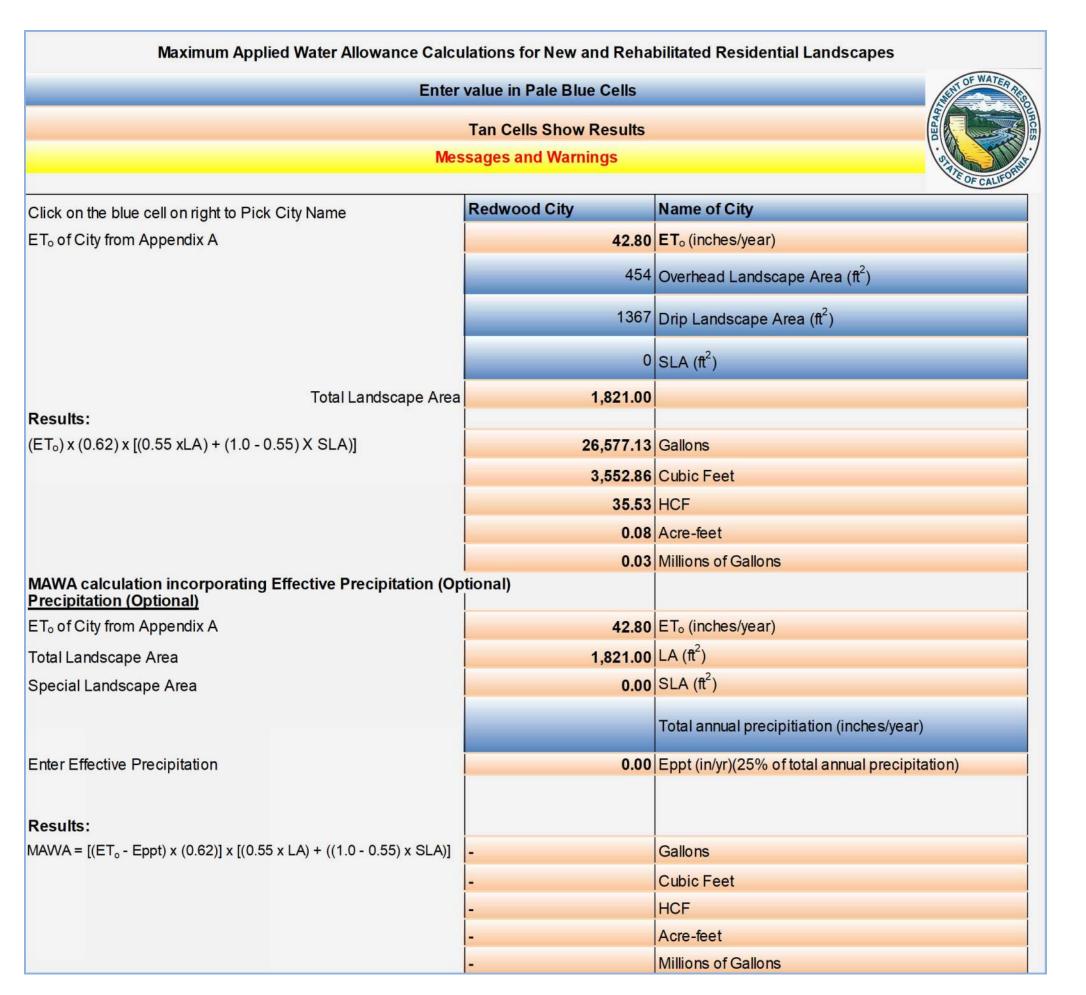

NOTES:

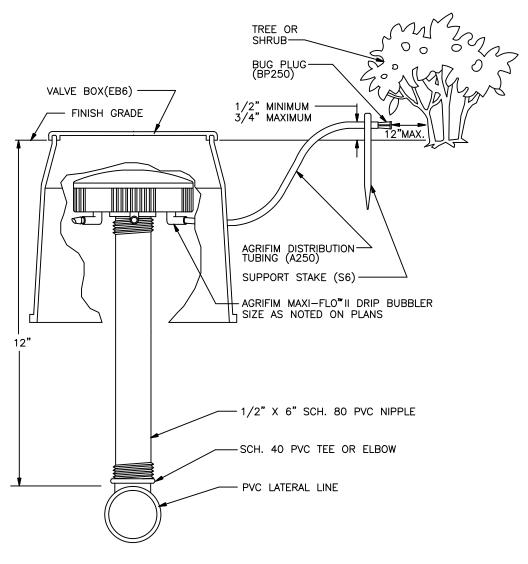1. APPLY TEFLON TAPE TO ALL THREADED CONNECTIONS.

2. SECURE END OF TUBING WITH AGRIFIM SUPPORT STAKE (S6).

IRRIGATION SCHEDULE

1.Irrigation scheduled for the plant establishment period would be 2 to 3 times a week for the first month

followed by twice a week for the following months for upto a year until the roots are well established.

April - October: Twice a week with run time of 20 minutes

November- March: Run time of 15 minutes
The system can be shut off on rainy days for the months of November to February. Additional watering by hand can be provided for extremely hot days.

2. Irrigation scheduling for the established landscape would be as follows:

For the second year of the landscape:

May- September: twice a week with a run time of twenty minutes October- April:once a week with a run time of twenty minutes

The system can be shut off during the months of November to February assuming that rainfall provides the necessary irrigation.

For the following years the landscape can be irrigated once a week.


Once established, drought tolerant plants need to be watered only once in two weeks or on a need basis.

Note: The above only acts as a guide. Irrigation schedules can be modified by home owner depending on actual weather and soil conditions. Existing fully established plants and trees on site that were retained are to be irrigated as per an 'established landscape schedule'. Drought tolerant plants need to be regularly watered for the first two years until they are well established after which they can do quite well with watering them even twice a month.

Water used for irrigation per month to be below the MAWA values as shown the water efficient table on sheet L4.

The irrigation controller will be weather based as specified in the irrigation legend.

The controller will receive real time weather information, and adjust the programmed watering schedule automatically based on local weather. This will restrict watering during times of precipitation and will help to conserve water.

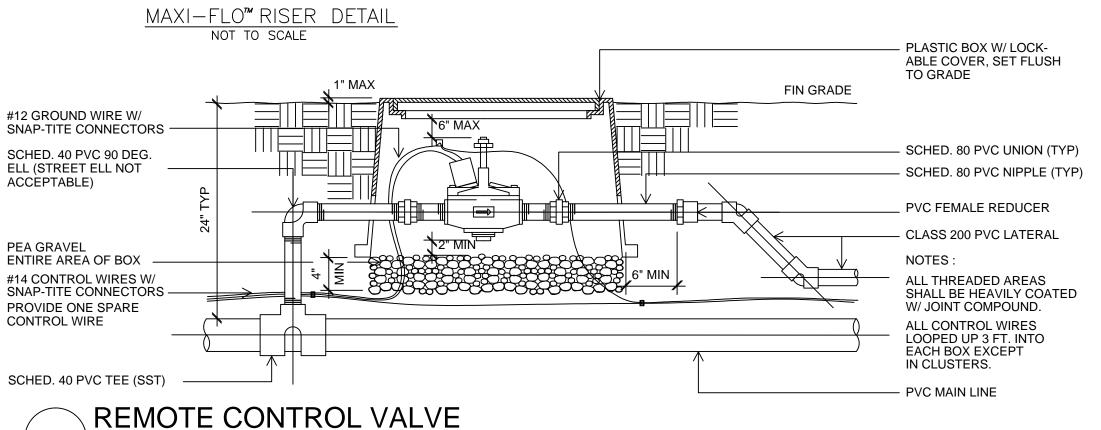

N.T.S.

LANDSCAPE DESIGN COMPLIANCE STATEMENT

I HAVE COMPLIED WITH THE CRITERIA OF THE MODEL WATER EFFICIENT LANDSCAPE ORDINANCE AND HAVE APPLIED THEM FOR THE EFFICIENT USE OF WATER IN THE IRRIGATION DESIGN PLAN

Signature 02-24-23
RUSSELL STRINGHAM LA #3091


Menaka Rao
LANDSCAPE DESIGN

4653 MonteCarlo Park Court

Fremont, CA 94538 Ph:650 644 7631

DRAWN BY:

SIGNED BY:
RUSSELL STRINGHAM
LA #3091

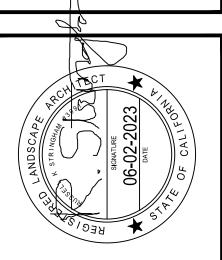

BLOOMFIELD RESIDE 36 BLOOMFIELD RO, BURLINGAME, CA

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1	06-02-23
DATE:	
02	-24-23

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PLANTING NOTES

THE PLANTING PLAN IS DIAGRAMMATIC ONLY. THE EXACT LOCATION OF PLANT MATERIAL SHALL BE DETERMINED ON SITE. THE EXACT LOCATION OF PLANTS ONSITE WILL ADHERE TO SETBACK REQUIREMENTS FROM THE OWTS.

THE CONTRACTOR SHALL VERIFY THAT THE SOIL TO BE PLANTED IS NATIVE, AND FREE FROM ANY FOREIGN MATERIALS OR SUBSTANCES, WITH A MINIMUM DEPTH OF 8 INCHES OF NON COMPACTED TOPSOIL.

TILL ALL NEW PLANTING AREAS TO A DEPTH OF 8", AND REMOVE ALL WEEDS, STICKS, OVER 1/2 INCH DIAMETER AND ANY OTHER MATERIAL THAT WOULD BE HARMFUL TO TO PLANT GROWTH.

ALL NEW PLANTING AREAS SHALL RECEIVE A 3" LAYER OF WOOD RESIDUAL. TILL IN TO A DEPTH OF 6" AND FINE GRADE.

ALL PLANT MATERIAL SHALL RECEIVE "AGRIFORM" FERTILIZER TABLETS AT THE TIME OF PLANTING, INSERTED IN THE BACKFILL MIX AT HALF THE DEPTH OF THE ROOTBALL. TABLET QUANTITIES AND SIZE AS INDICATED ON THE PLANTING DETAILS.

AFTER FINE GRADING, AND PLANTING, (PRIOR TO TOP DRESSING WITH MULCH) A PRE-EMERGENT HERBICIDE SHALL BE APPLIED AT A RATE AND METHOD RECOMMENDED BY THE PRODUCT MANUFACTURER. SPREAD AS A TOP DRESSING, A 3" LAYER OF MULCH, IN ALL PLANTING AREAS FOR ADDITIONAL WEED CONTROL AND WATER RETENTION. SUBMIT A SAMPLE FOR APPROVAL.

ALL PLANT MATERIAL SUBSTITUTIONS SHALL BE APPROVED BY THE OWNERS OR THE LANDSCAPE ARCHITECT.

ALL PLANTING DETAILS SHALL BE CLOSELY FOLLOWED, AND ALL LOCAL GOVERNING CODES SHALL BE MET.

ALL PLANT MATERIALS SHALL BE IN A HEALTHY, VIGOROUS, AND DISEASE FREE CONDITION. THE PLANT SIZE SHALL BE PROPORTIONAL TO THE CONTAINER SIZE SPECIFIED. PLANTS NOT MEETING THESE REQUIREMENTS WILL BE REFUSED, EVEN IF PLANTED.

IT IS THE RESPONSIBILITY OF THE OWNER TO SUBMIT LANDSCAPE PLANS TO THE GOVERNING MUNICIPALITY FOR APPROVAL OF THE PLANS, AND TO OBTAIN BUILDING PERMITS. IF ANY CHANGES OR ADDITIONS TO THE PLANS NEED TO BE MADE, THE OWNER SHALL RETURN THE PLANS, WITH THE CITY REVIEW COMMENTS FOR REVISIONS. FINAL APPROVAL MUST BE OBTAINED FROM THE GOVERNING MUNICIPALITY PRIOR TO THE BEGINNING OF ANY CONSTRUCTION.


REGARDING ALL EXISTING TREE SPECIES, HEIGHT, CONDITION, LOCATIONS, TREE PROTECTION, SURVEY MAP BY SMP ENGINEERS DATED JANUARY 26, 2023.

NO ARBORIST REPORT WAS PROVIDED AT THIS TIME.

A MINIMUM OF 3-INCH LAYER OF MULCH SHALL BE APPLIED ON EXPOSED SOIL SURFACES OF I HAVE COMPLIED WITH THE CRITERIA OF THE WATER CONSERVATION IN LANDSCAPING ORDINANCE AND APPLIED THEM FOR THE EFFICIENT USE OF WATER IN THE LANDSCAPE DESIGN PLAN.

PLANTING AREAS EXCEPT TURF AREAS, CREEPING OR ROOTING GROUNDCOVERS, OR DIRECT SEEDING APPLICATIONS WHERE MULCH IS CONTRAINDICATED.

FOR SOILS LESS THAN 6% ORGANIC MATTER IN THE TOP 6 INCHES OF SOIL, COMPOST AT A RATE OF A MINIMUM OF FOUR CUBIC YARDS PER 1000 SQ FT OF PERMEABLE AREA SHALL BE INCORPORATED TO A DEPTH OF SIX INCHES INTO THE SOIL.

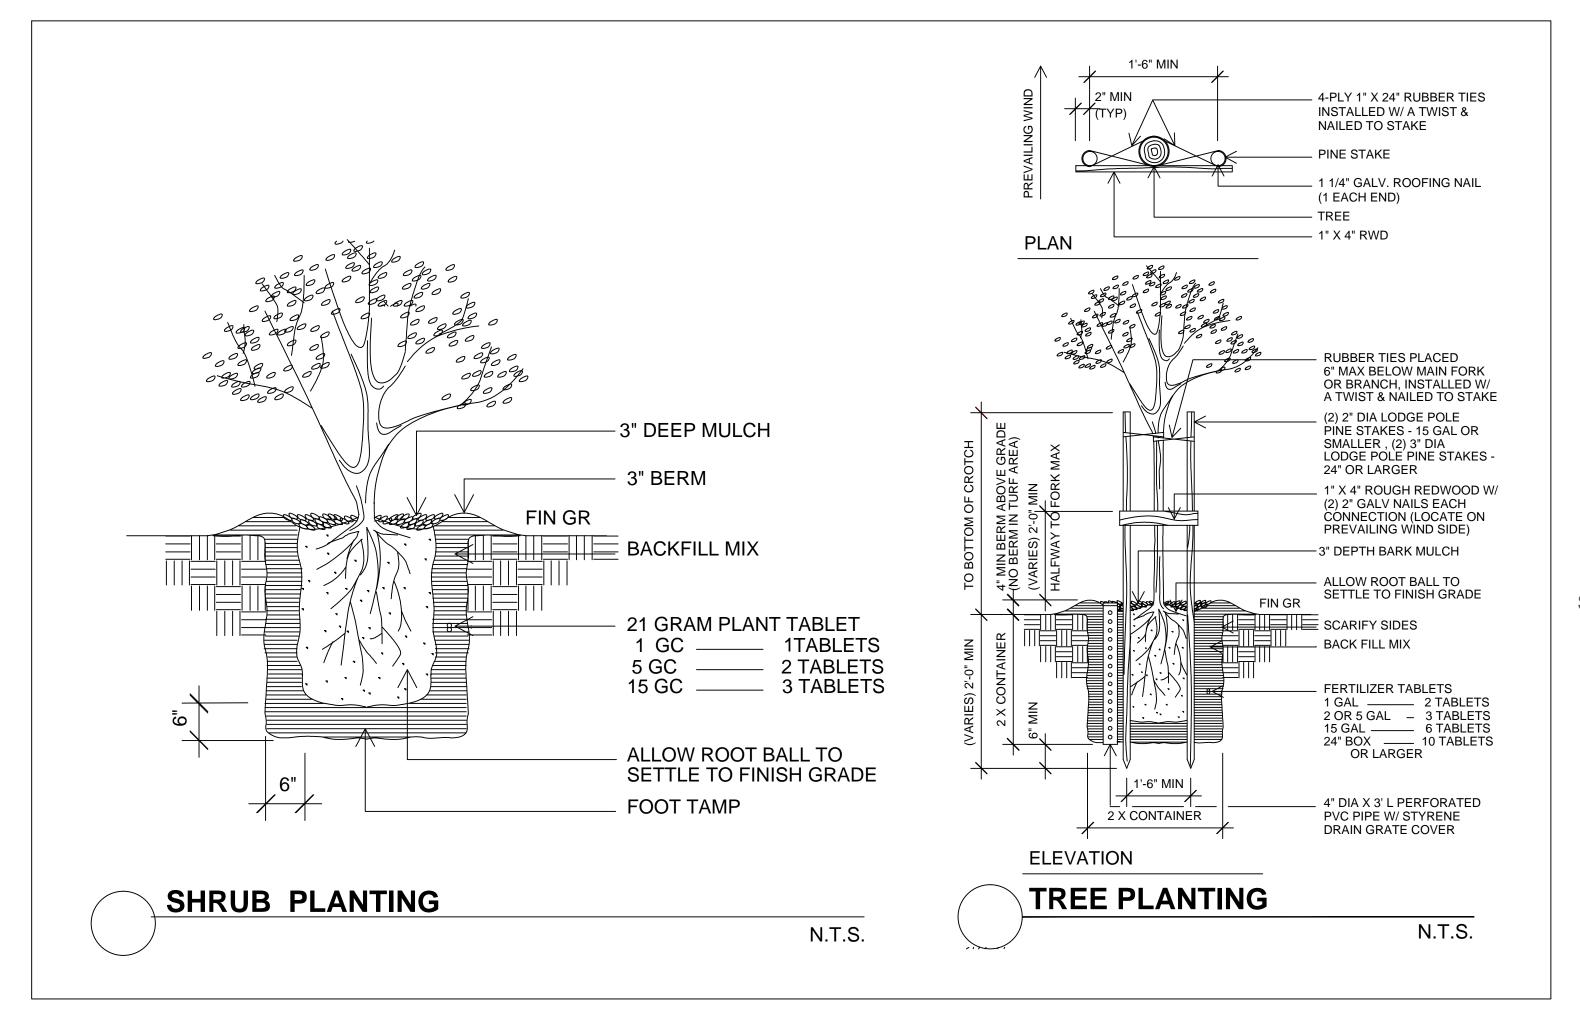

APPLICABLE CODES
WELO PLANTING, IRRIGATION LANDSCAPE AND LANDSCAPE LIGHTING PLANS
SCOPE OF WORK
2019 CALIFORNIA BUILDING CODE, 2019 CALIFORNIA RESIDENTIAL CODE, 2019 CALIFORNIA

2019 CALIFORNIA BUILDING CODE, 2019 CALIFORNIA RESIDENTIAL CODE, 2019 CALIFORNIA ELECTRICAL CODE, 2019 CALIFORNIA MECHANICAL CODE, 2019 CALIFORNIA FIRE CODE AS AMENDED BY WOODSIDE FIRE.

Work Hours and Parking

A. Work Hours: Working hours are strictly between

A. Work Hours: Working hours are strictly between the time mentioned below. 7:30 AM TO 5:30 PM- MONDAY -FRIDAY

8:00 AM TO 1:00 PM- MONDAY -FRIDAY

Construction parking is permitted only on the site and only on the side of the street fronting the property for which the permit is issued.

Noise

A. Except as otherwise permitted under this chapter, no person shall cause and no property owner shall permit on such owner's property, a noise produced by any person, machine, animal or device, or any combination thereof, in excess of the sound level limits set forth in this section to emanate from any property, public or private, beyond the property line.

Any sound in excess of the sound level limits set forth in this section shall constitute a noise disturbance. For purposes of determining sound levels, sound level measurements shall be made at any location on the receiving property. Professional Certification of meeting this requirement may be required prior to final inspection.

B. Sound Level Limits: 7a.m to 10 p.m. 60 dBa/10 p.m to 7 a.m 50 dBa

A CERTIFICATE OF COMPLETION SHALL BE FILLED OUT AND CERTIFIED BY EITHER THE DESIGNER OF THE LANDCAPE AND CERTIFIED BY EITHER THE DESIGNER OF THE LANDCAPE PLANS, IRRIGATION PLANS, OR THE LICENSED LANDSCAPE CONTRACTOR OF THE PROJECT.




LANDSCAPE DESIGN

4653 MonteCarlo Park Court Fremont, CA 94538 Ph:650 644 7631

DRAWN BY:
MENAKA RAO

SIGNED BY: RUSSELL STRINGHAM LA #3091₁

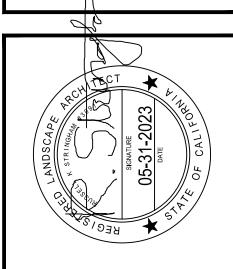


BLOOMFIELD RESIDENCE 36 BLOOMFIELD ROAD, BURLINGAME, CA


REVISION	REVISION DAT
1	06-02-23
DATE: 02	-24-23
JOB:	
SCALE:	
NT	S

SHEET:


L-4

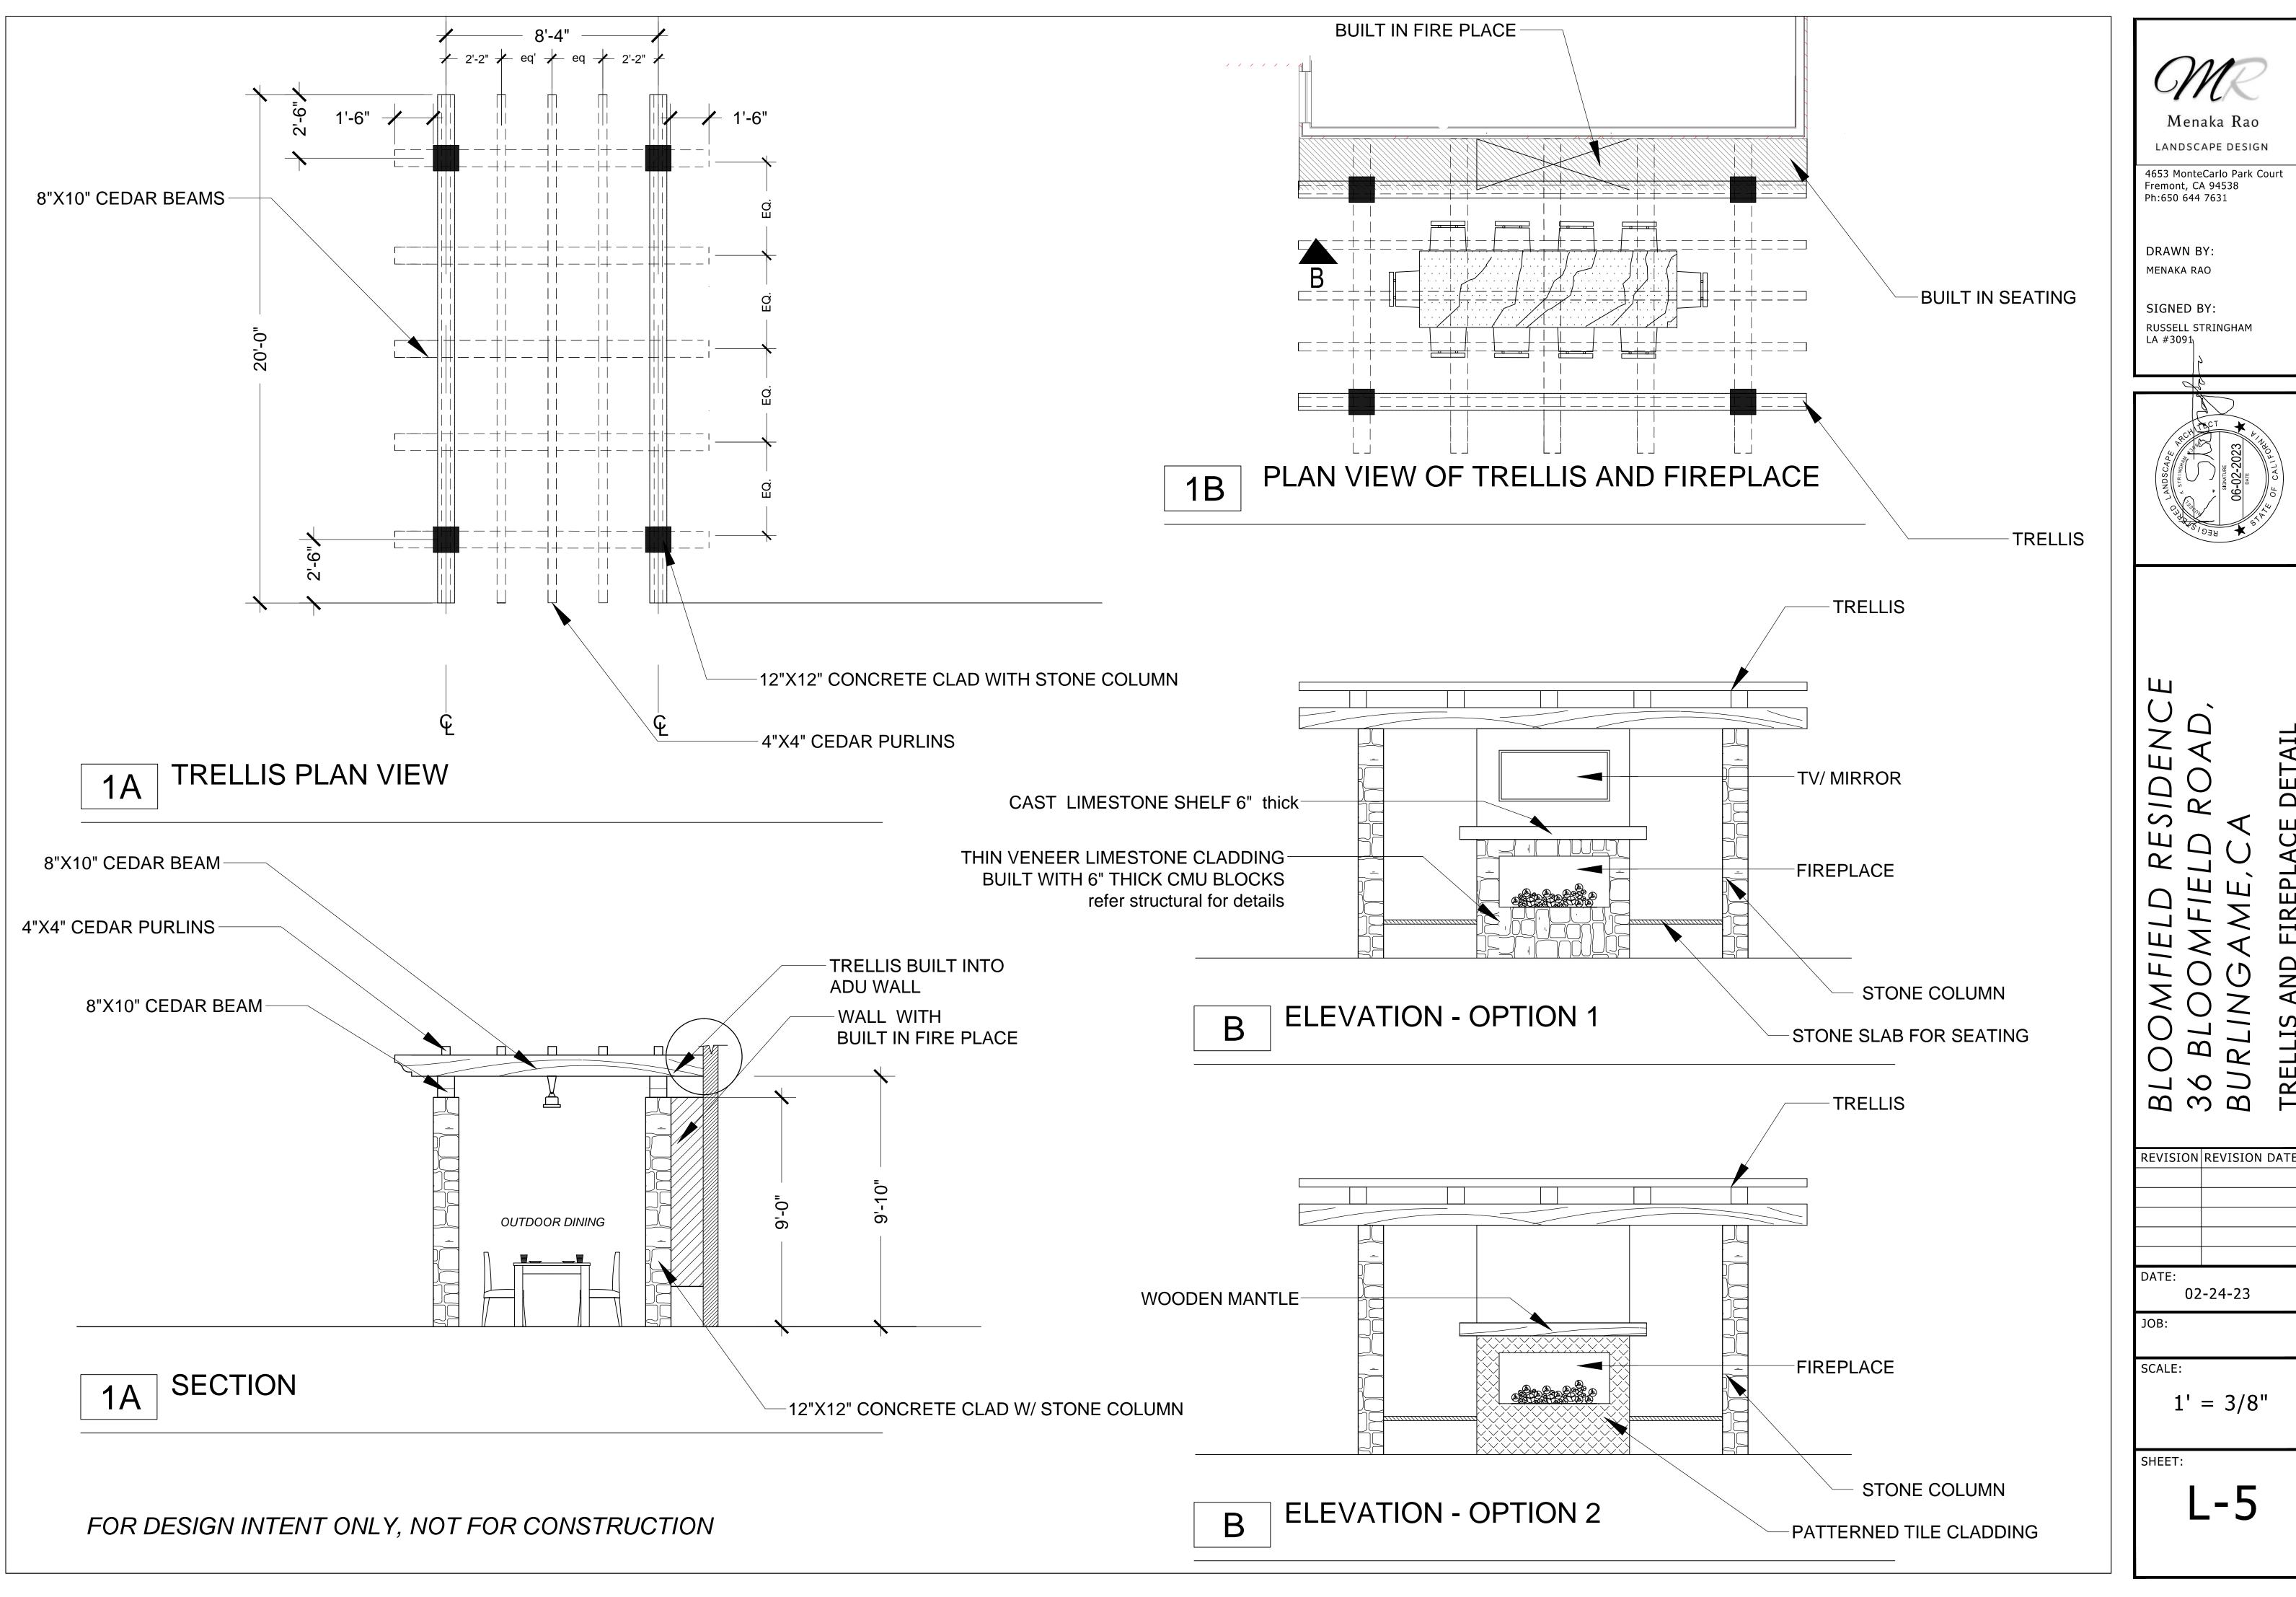




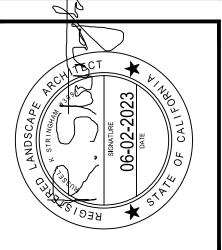

1' = 3/8"

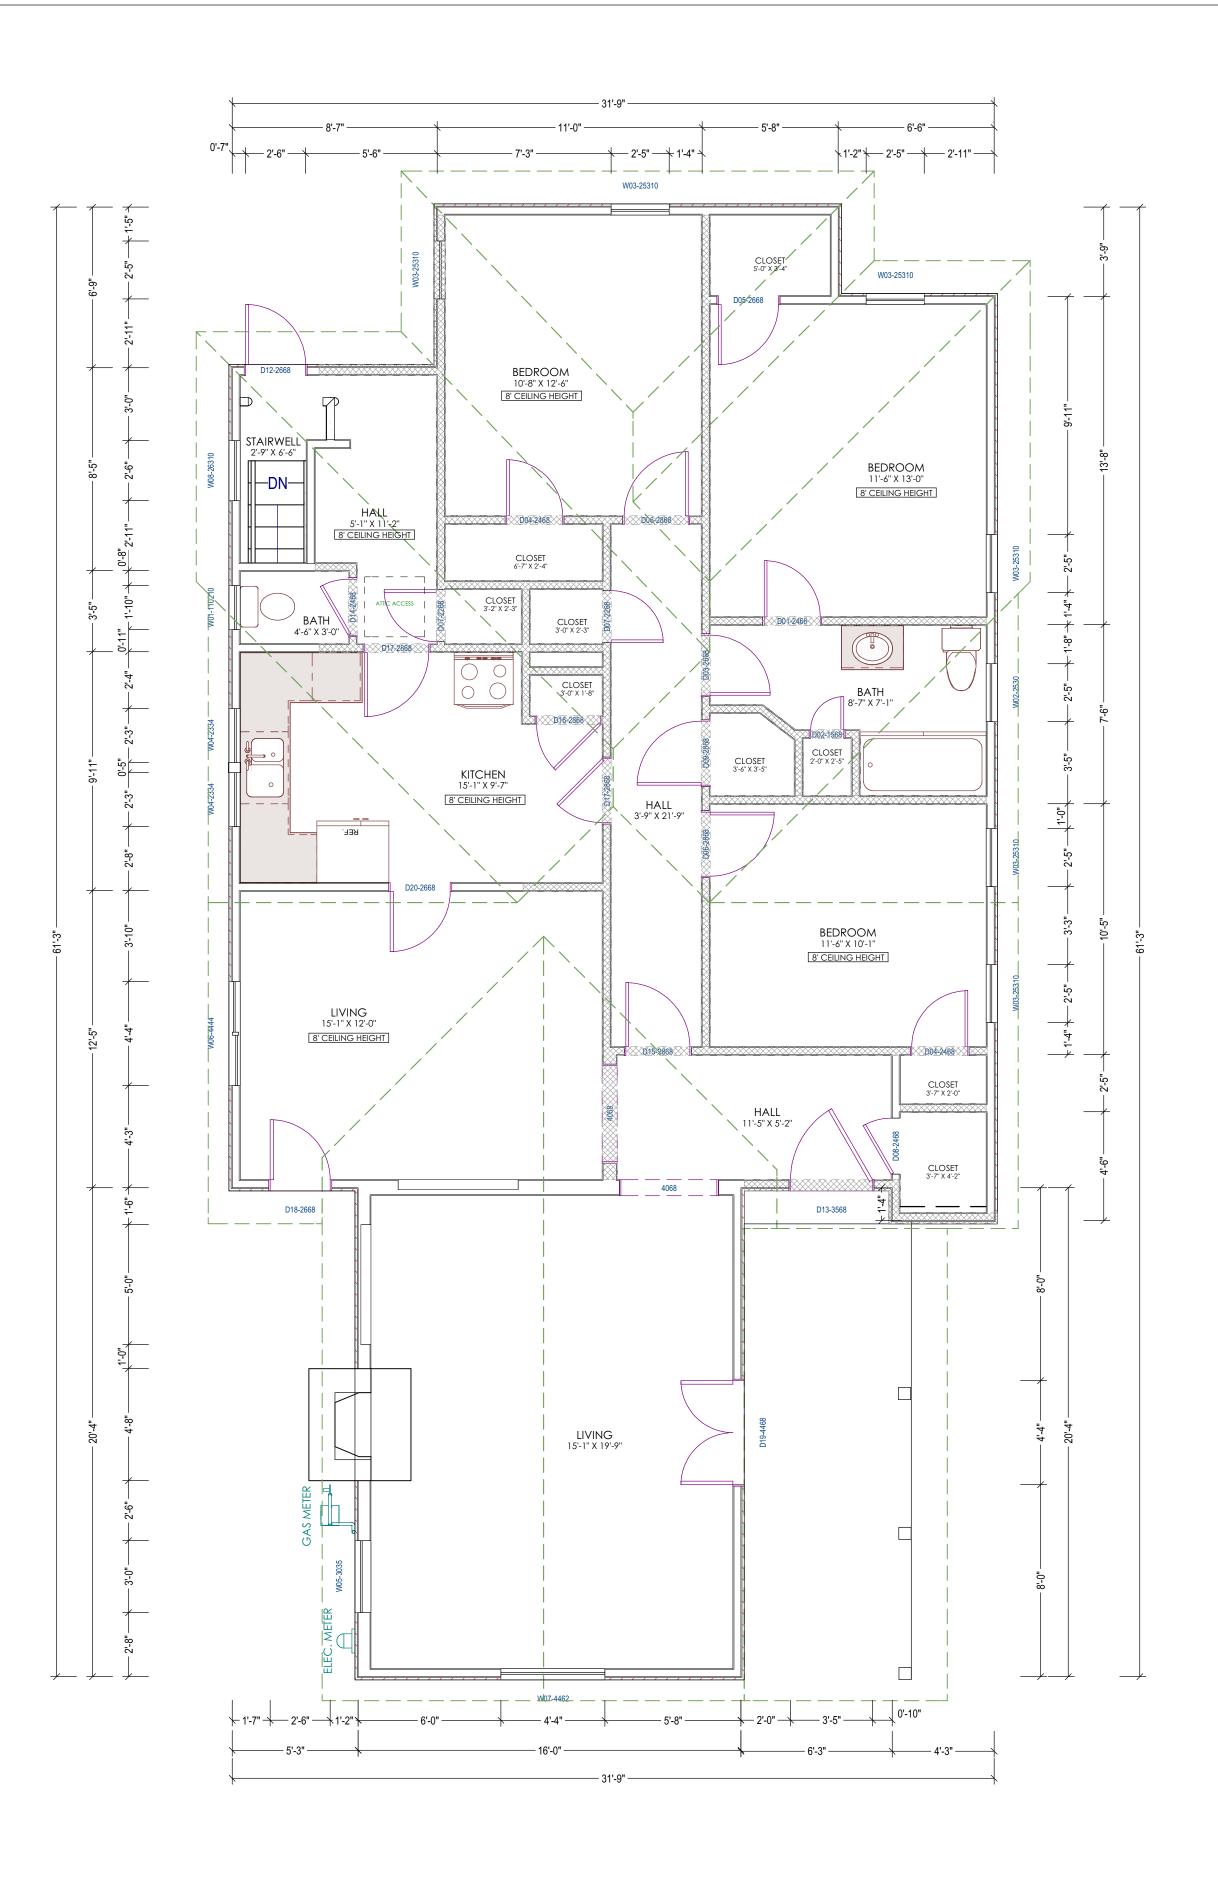

1 EXISTING FLOOR PLAN - MAIN HOUSE

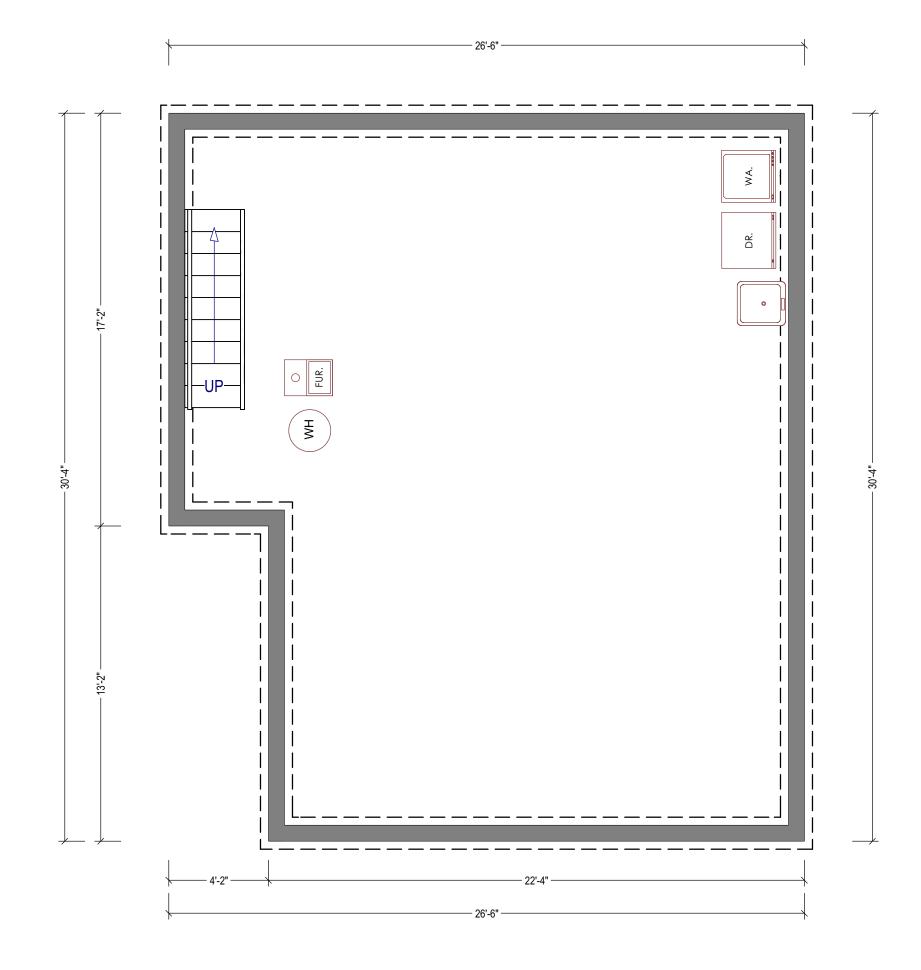

2 EXISTING FLOOR PLAN

SC: 1/4" = 1'-0"



LEGEND:

EXISTING WALL TO STAY

EXISTING WALL TO BE REMOVED

GRAPHIC SCALE: 44 TO SEE





AMSDESIGN

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Azadeh Masrour

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PROJECT NAME:

BLOOMFIELD RESIDENCE

36 BLOOMFIELD RD., BURLINGAME, CA 94010

REVISION TABLE:

	REVISION DATE	BY	DEF
01	04.06.2023	S.A.	PLN
02	05.24.2023	S.B.	PLN
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SHEET TITLE:

EXISTING FLOOR PLANS

PROJECT ID:	2206-12
DATE:	OCT.2022
SCALE:	1/4" = 1'
DRAWN BY:	Z.H.
SHEET NUMBER:	

RA-01.01



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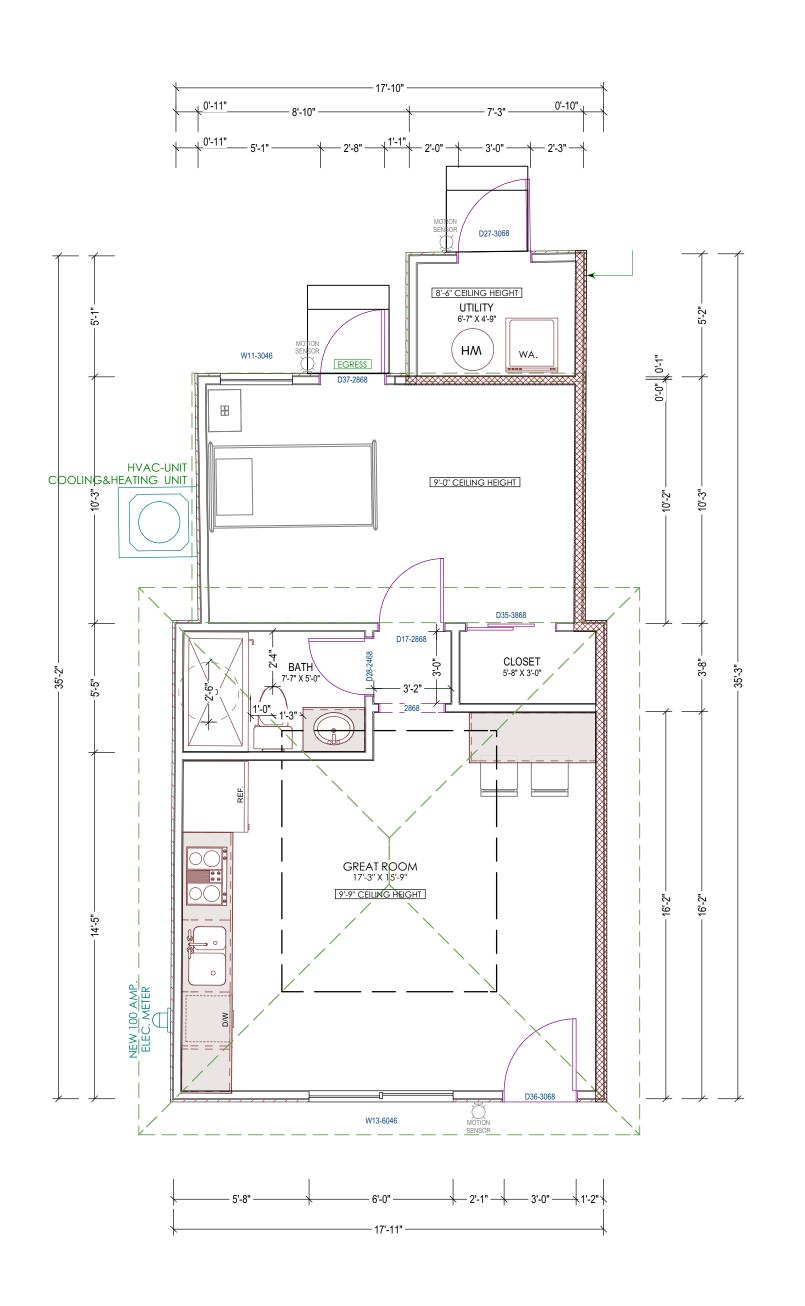
EXISTING ELEVATIONS

PROJECT ID:	2206-12
DATE:	OCT.2022
SCALE:	1/4" = 1'
DRAWN BY:	Z.H.

D 4 00 0


SHEET NUMBER:


RA-02.01



EXISTING FLOOR PLAN - DETACHED ADU



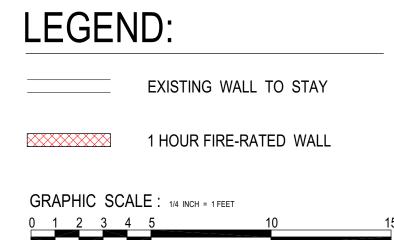


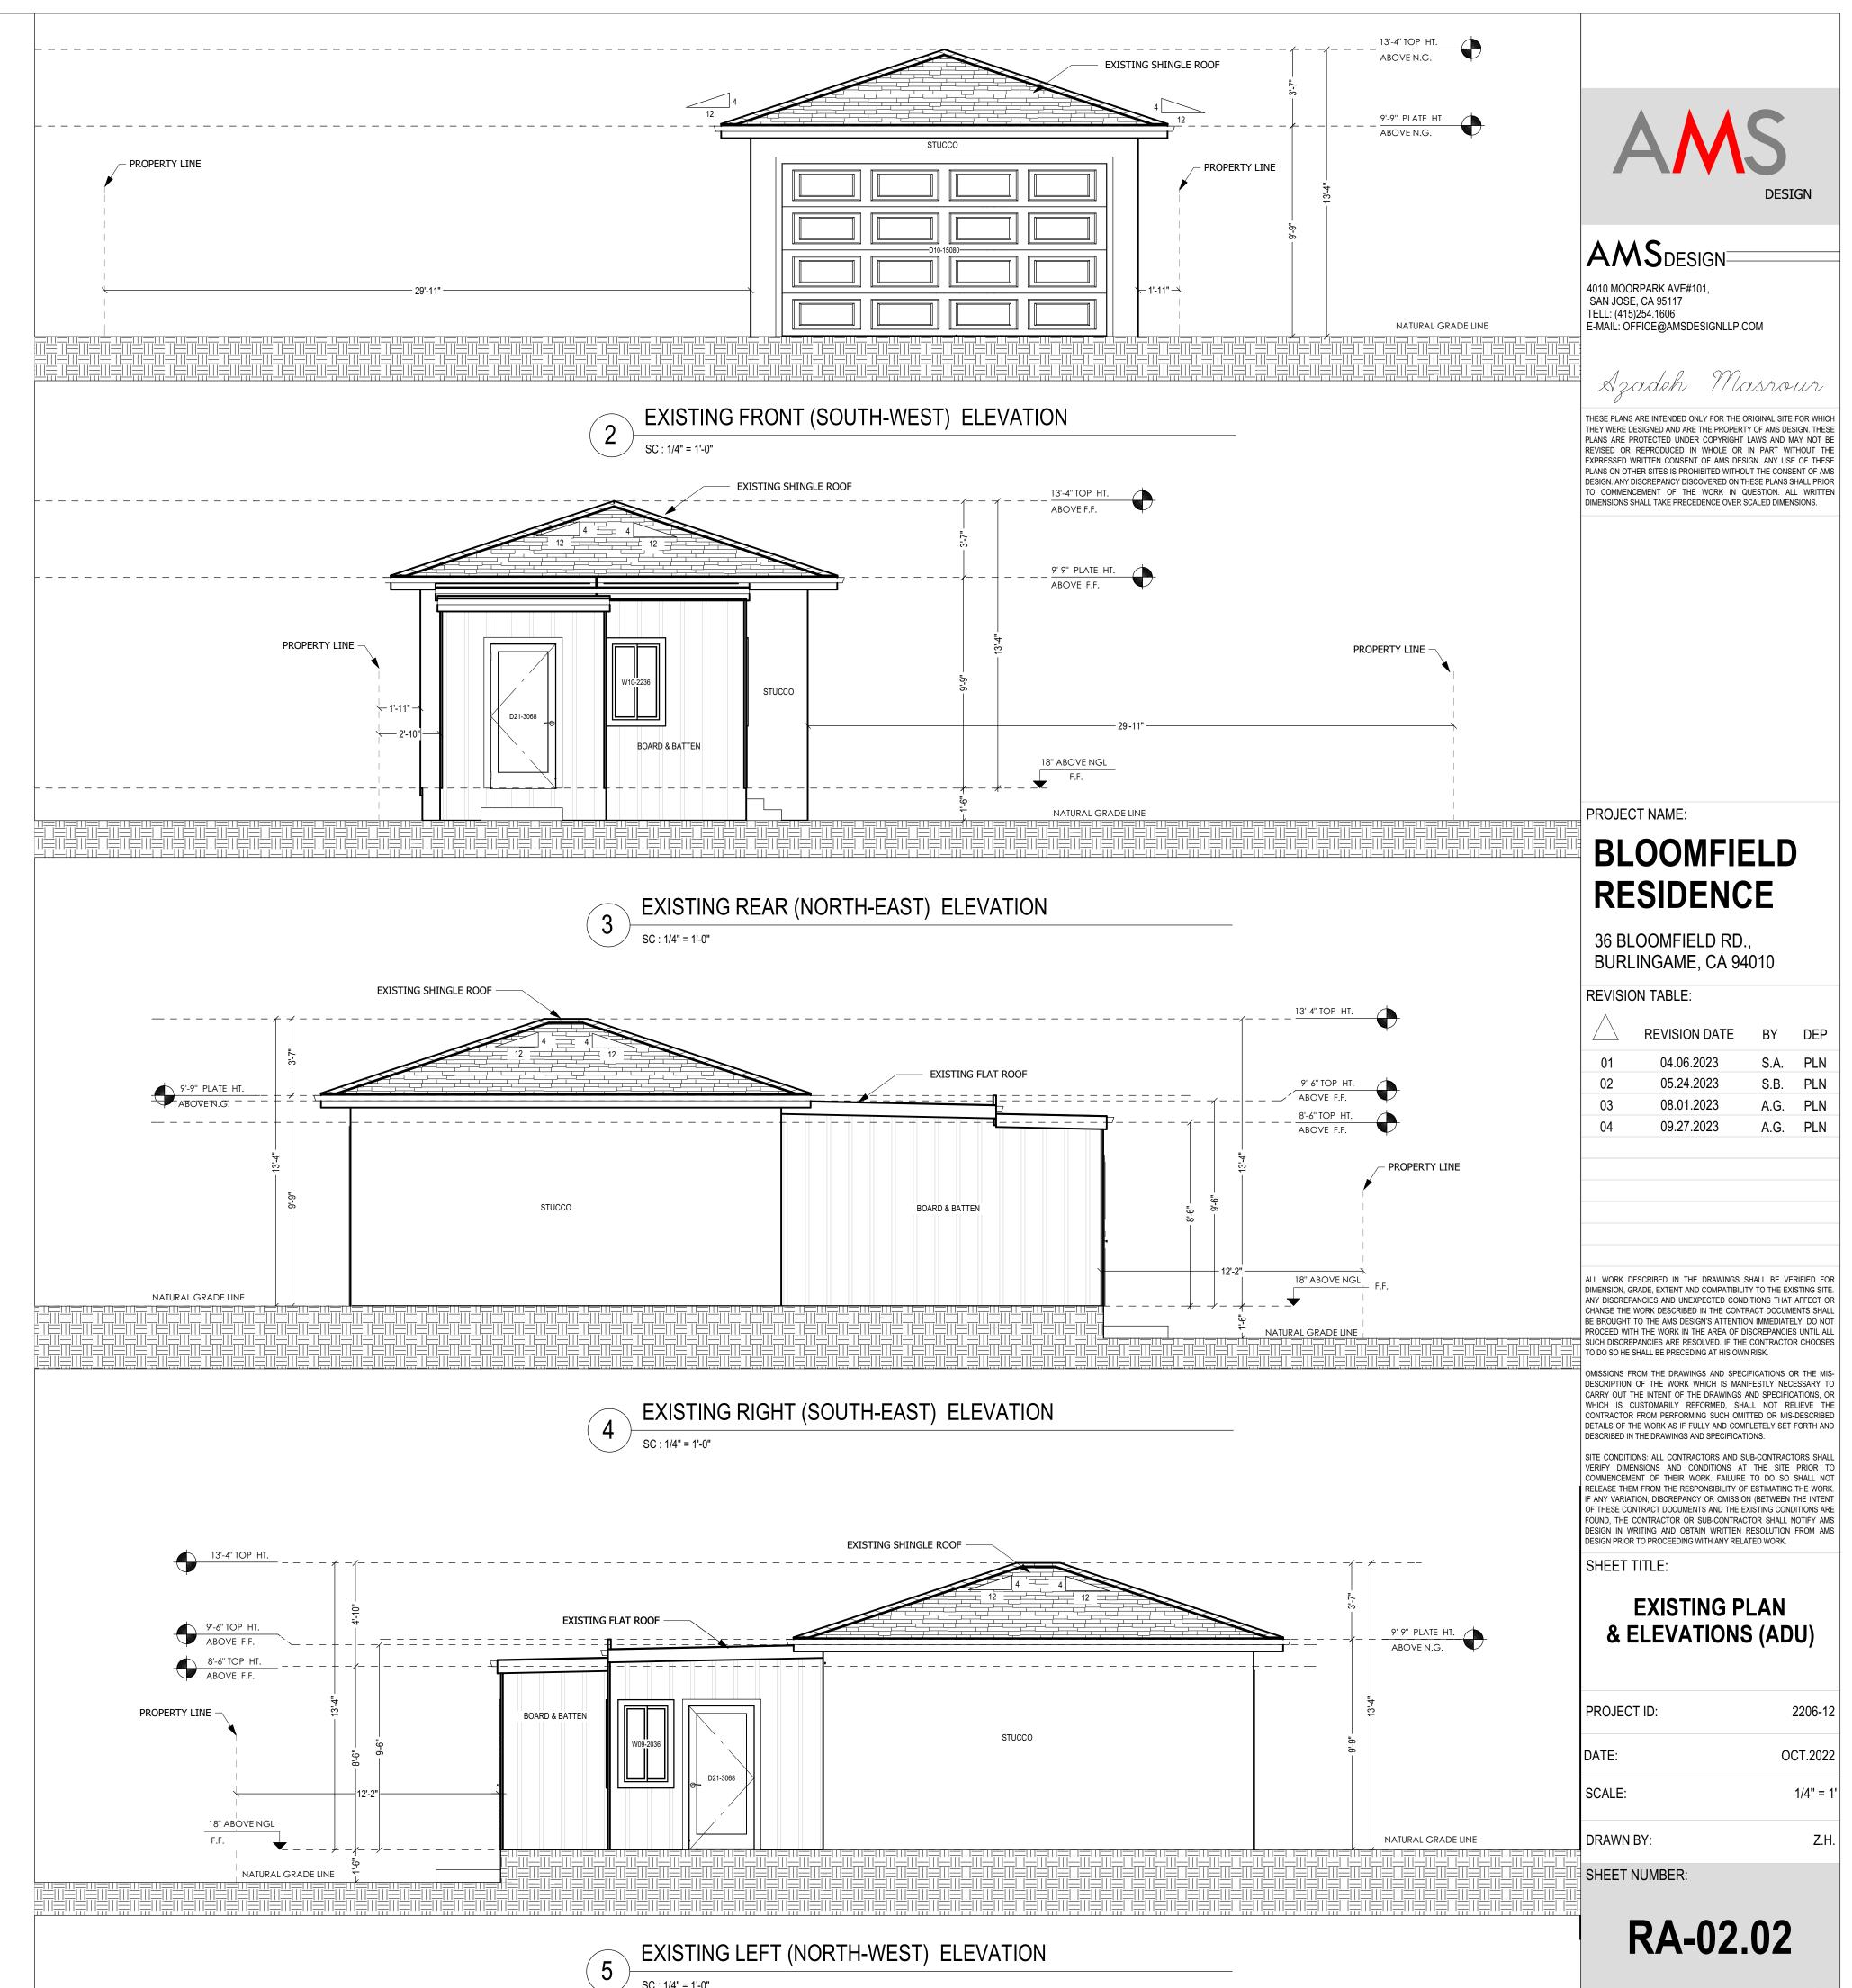

BUILDING NOTES:

1- BASEMENTS (EXCEPT THOSE ONLY FOR MECHANICAL EQUIPMENT AND NOT OVER 200 SQFT IN FLOOR AREA), HABITABLE ATTICS AND EVERY SLEEPING ROOM SHALL HAVE AT LEAST ONE OPERABLE EMERGENCY ESCAPE AND RESCUE OPENING. R310.1

- a. MIN. NET CLEAR OPENABLE DIMENSION OF 24 INCHES IN HEIGHT. R310.1.2
- b. MIN. NET CLEAR OPENABLE DIMENSION 20 INCHES IN WIDTH. R310.1.3
- c. MIN. NET CLEAR OPENABLE DIMENSION OF 5.7 SQFT IN AREA. GRADE FLOOR OPENINGS SHALL HAVE A MIN. NET CLEAR OPENING OF 5 SQFT. 310.1.1
- d. THE HEIGHT OF BOTTOM OF EMERGENCY EGRESS OPENING SHALL HAVE NOT MORE THAN 44 INCHES MEASURED FROM THE FLOOR. 310.2.2
- 2- FOR KITCHEN, A CLEAR PASSAGEWAY OF NOT LESS THAN 3-FEET BETWEEN THE COUNTER FRONTS AND APPLIANCES OR COUNTER FRONTS AND WALLS. CRC R311
- 3- SHOWER COMPARTMENTS AND WALL ABOVE BATHTUBES WITH INSTALLED SHOWER HEADS SHALL BE FINISHED WITH A SMOOTH, NONABSORBENT SURFACE TO THE HEIGHT NOT LESS THAN 72 INCHES(6 FT). CRC R307.2
- 4- THE DOOR BETWEEN GARAGE AND ENTRY REQUIRED TO BE SELF LATCHING AND SELF CLOSING, SOLID CORE DOOR NOT LESS THAN 1-3/8 INCH THICK.
- 5- THE MAXIMUM RISER HEIGHT CAN BE 7.75-INCHES. MINIMUM TREAD DEPTH CAN BE 10-INCHES. FOR ANY TREAD DEPTH LESS THAN 11-INCHES, A NOSING OF NOT LESS THAN 0.75-INCHES, BUT NOT MORE THAN 1.25-INCHES SHALL BE PROVIDED.
- 6- DOORS AND PANELS OF SHOWER AND BATHTUB ENCLOSURES SHALL BE FULLY TEMPERED, LAMINATED SAFETY GLASS OR APPROVED PLASTIC. CRC R308.6.2
- GLAZING IN SHOWERS OR BATHTUB ADJACENT WALL OPENINGS WITHIN 60 INCHES ABOVE A STANDING SURFACE AND DRAIN INLET SHALL BE FULLY TEMPERED, LAMINATED SAFETY GLASS OR APPROVED PLASTIC. CRC R308.5
- 7- GLAZING IN AN INDIVIDUAL FIXED OR PORTABLE PANEL ADJACENT TO A DOOR WHERE THE NEAREST EXPOSED EDGE OF THE GLAZING IS WITHIN A 24-INCH ARC OF EITHER VERTICAL EDGE OF THE DOOR IN A CLOSED POSITION AND WHERE THE BOTTOM EXPOSED EDGE OF GLAZING IS LESS THAN 60-INCHES ABOVE THE WALKING SURFACE SHALL BE FULLY TEMPERED, LAMINATED SAFETY GLASS OR APPROVED PLASTIC (I.E. SIDE LIGHT AT NEW MAIN ENTRY DOOR) . CRC R308.4.2
- 8- MINIMUM 36" DEEP LANDING IN THE DIRECTION OF TRAVEL AT NEW EXTERIOR DOORS SHALL BE PROVIDED. LANDING TO BE NOT MORE THAN 7-3/4 INCHES LOWER THAN THE DOOR'S THRESHOLD FOR IN-SWINGING AND SLIDING GLASS DOORS AND NOT MORE THAN 7" FOR IN-SWINGING AND MAIN ENTRY DOOR.
- 9- NEW ENTRY DOOR SHALL BE OPENABLE FROM THE INSIDE OF THE DWELLING WITHOUT USE OF KEY, SPECIAL KNOWLEDGE OR EFFORT, CRC SEC. R311.2
- 10- 1/2" GYPSUM BOARD FROM FOUNDATION TO ROOF SHEATHING TO BE INSTALLED ON THE GARAGE SIDE AT SEPARATION WALL BETWEEN GARAGE AND RESIDENCE. (GARAGE MUST BE SEPARATED FROM THE DWELLING AND ITS ATTIC AREA) CRC SEC. R302.6 AND TABLE R302.6
- 5/8" TYPE "X" GYP. BOARD FINISH ON THE GARAGE SIDE OF THE WALL IS REQUIRED. ALSO THE GARAGE SHALL BE SEPRATED FROM THE DWELLING SPACE ABOVE, BY 5/8" TYPE "X" GYP AT THE CEILING.
- 11- BATHROOMS & KITCHEN:
- 11.1- 22" MIN SHOWER DOOR CLEARANCE.
- 11.2- TEMPER GLAZING FOR THE SHOWER DOOR AND SLIDING WINDOWS.
- CEMENT BOARD SUBSTRATE FOR SHOWER WALLS.
- 11.3- LAVATORY FAUCETS TO HAVE A FLOW RATE OF NO MORE THAN 1.2 GPM OR LESS AT 60 PSI AND NOT LESS THAN 0.8 GPM OR LESS AT 20 PSI. (CALGREEN 4.303.1)
- 11.4- WATER CLOSETS TO HAVE A FLOW RATE OF 1.28 GALLONS/FLUSH OR LESS. (CALGREEN 4.303.1)
- 11.5 -CEMENT BOARD SUBSTRATE (IE. DUROCK OR WONDERBOARD, ETC) FOR TILE APPLICATION SURROUNDING THE BATH TUB WALLS.
- 11.6- KITCHEN FAUCETS TO HAVE A FLOW RATE OF 1.8 GPM OR LESS AT 60 PSI. (CALGREEN 4.303.1)
- 11.7- SHOWER HEAD TO HAVE A FLOW RATE NOT TO EXCEED OF 1.8 GPM AT 80 PSI. (CALGREEN 4.303.1)

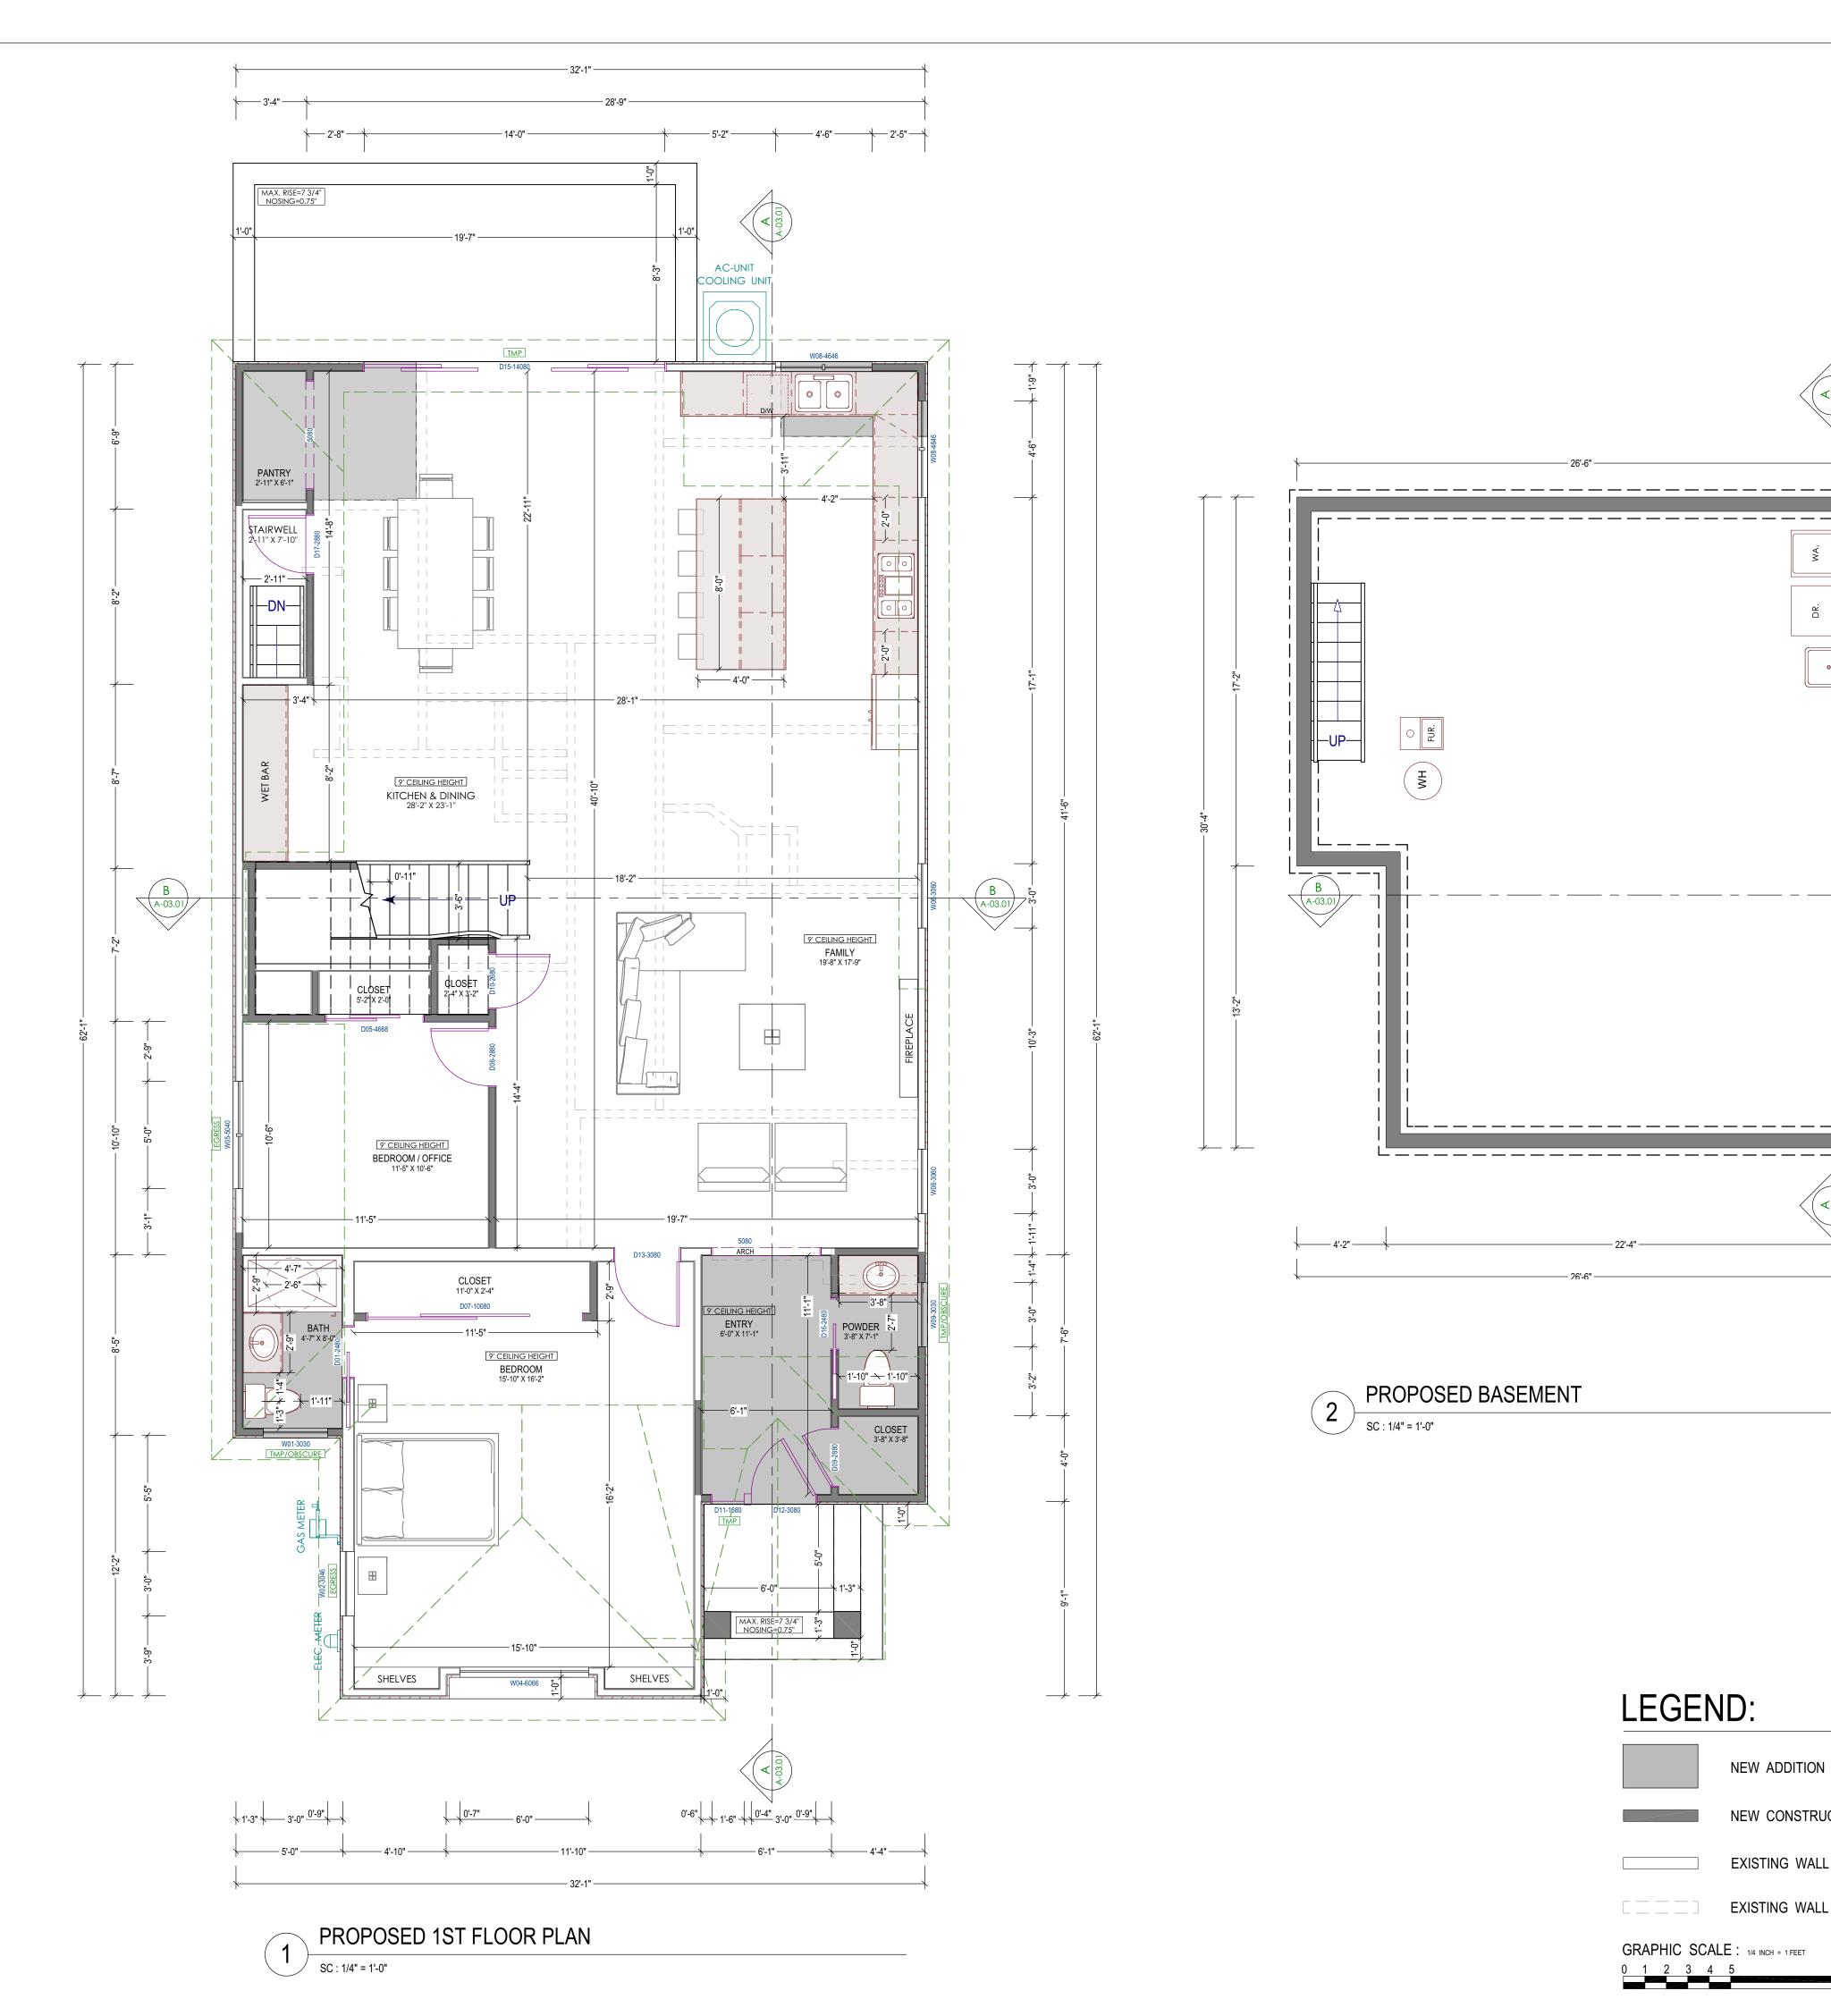



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PROJECT NAME:

BLOOMFIELD RESIDENCE

36 BLOOMFIELD RD., BURLINGAME, CA 94010

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SHEET TITLE:

NORTH

LEGEND:

GRAPHIC SCALE: 1/4 INCH = 1 FEET

NEW ADDITION

NEW CONSTRUCTION WALL


EXISTING WALL TO STAY

EXISTING WALL TO BE REMOVED

PROPOSED FLOOR PLAN

PROJECT ID: 2206-12 DATE: OCT.2022 SCALE: 1/4" = 1' DRAWN BY: SHEET NUMBER:

A-01.01

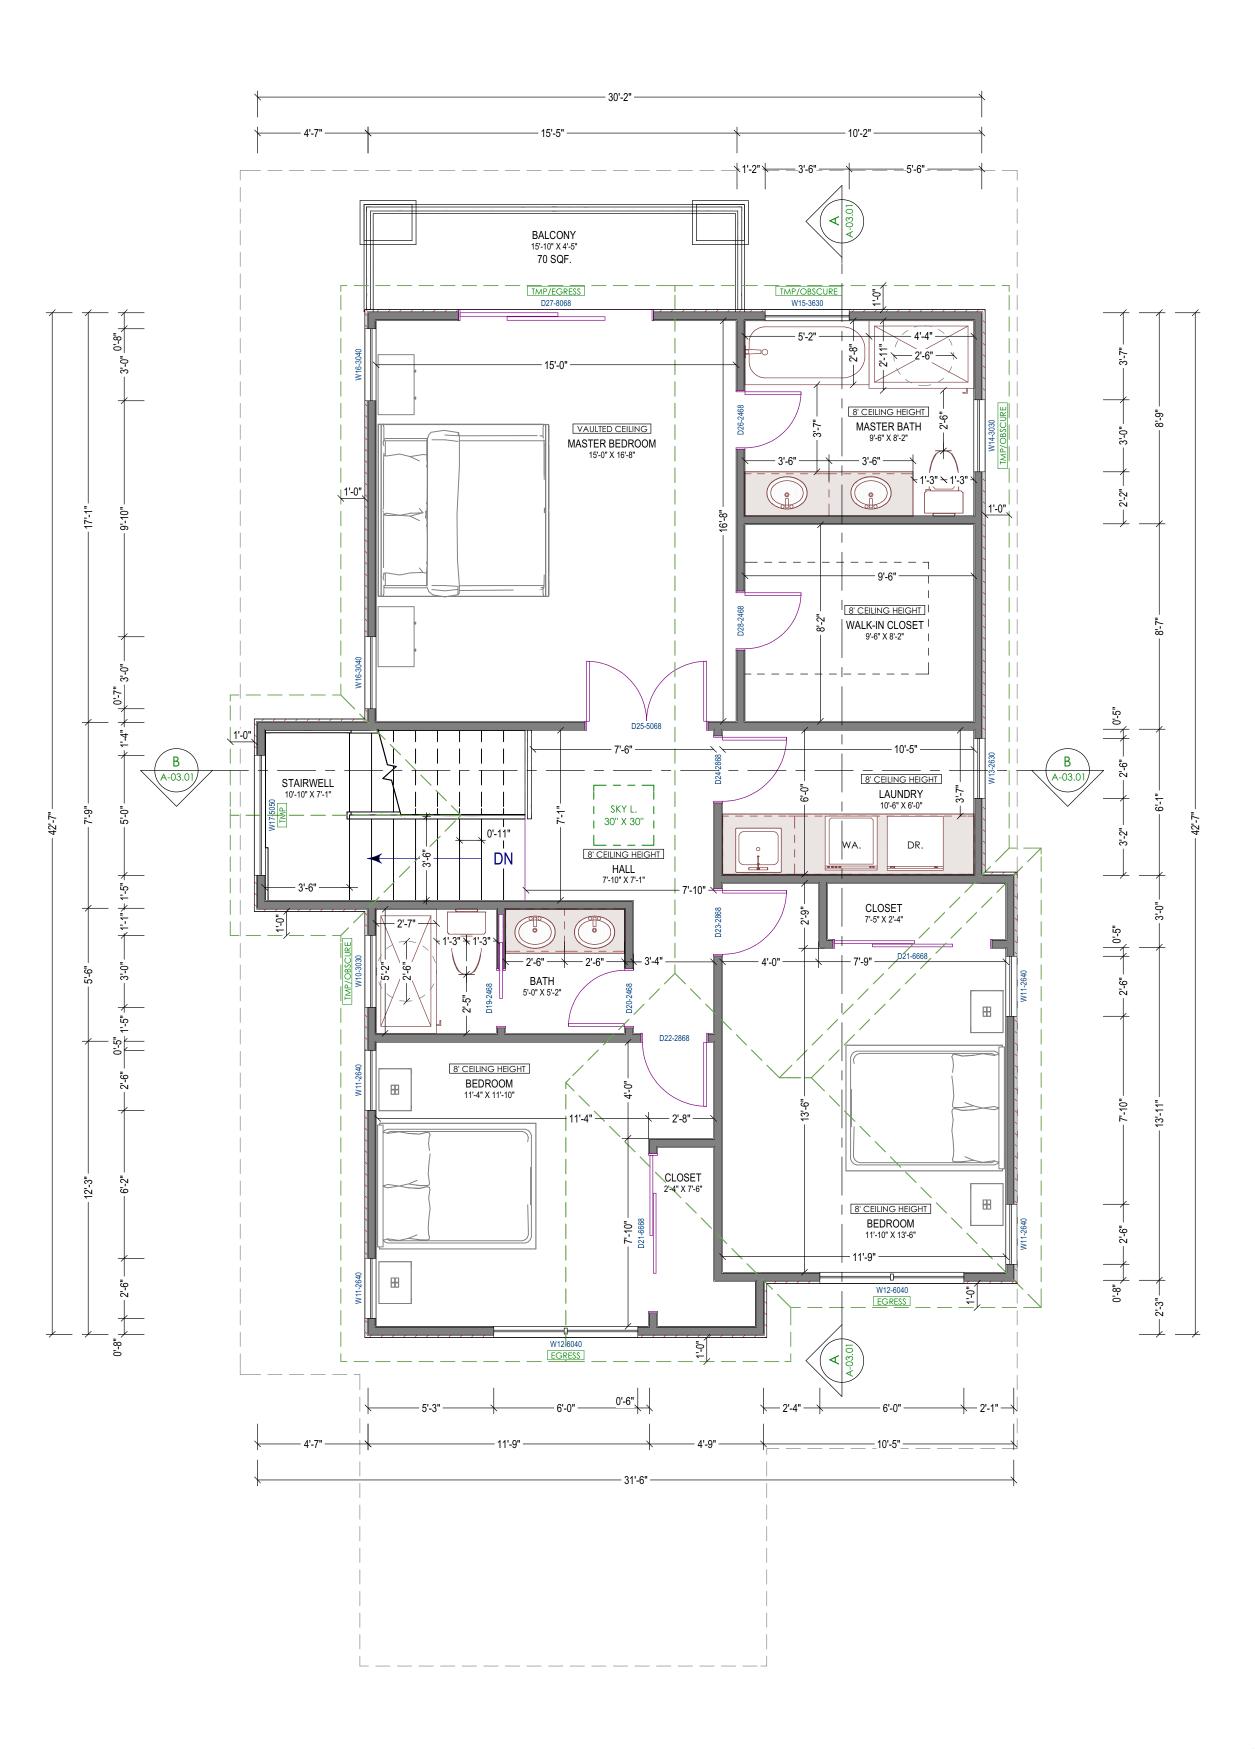


PROPOSED 2ND FLOOR PLAN SC : 1/4" = 1'-0"



LEGEND:

NEW CONSTRUCTION WALL

GRAPHIC SCALE: 1/4 INCH = 1 FEET

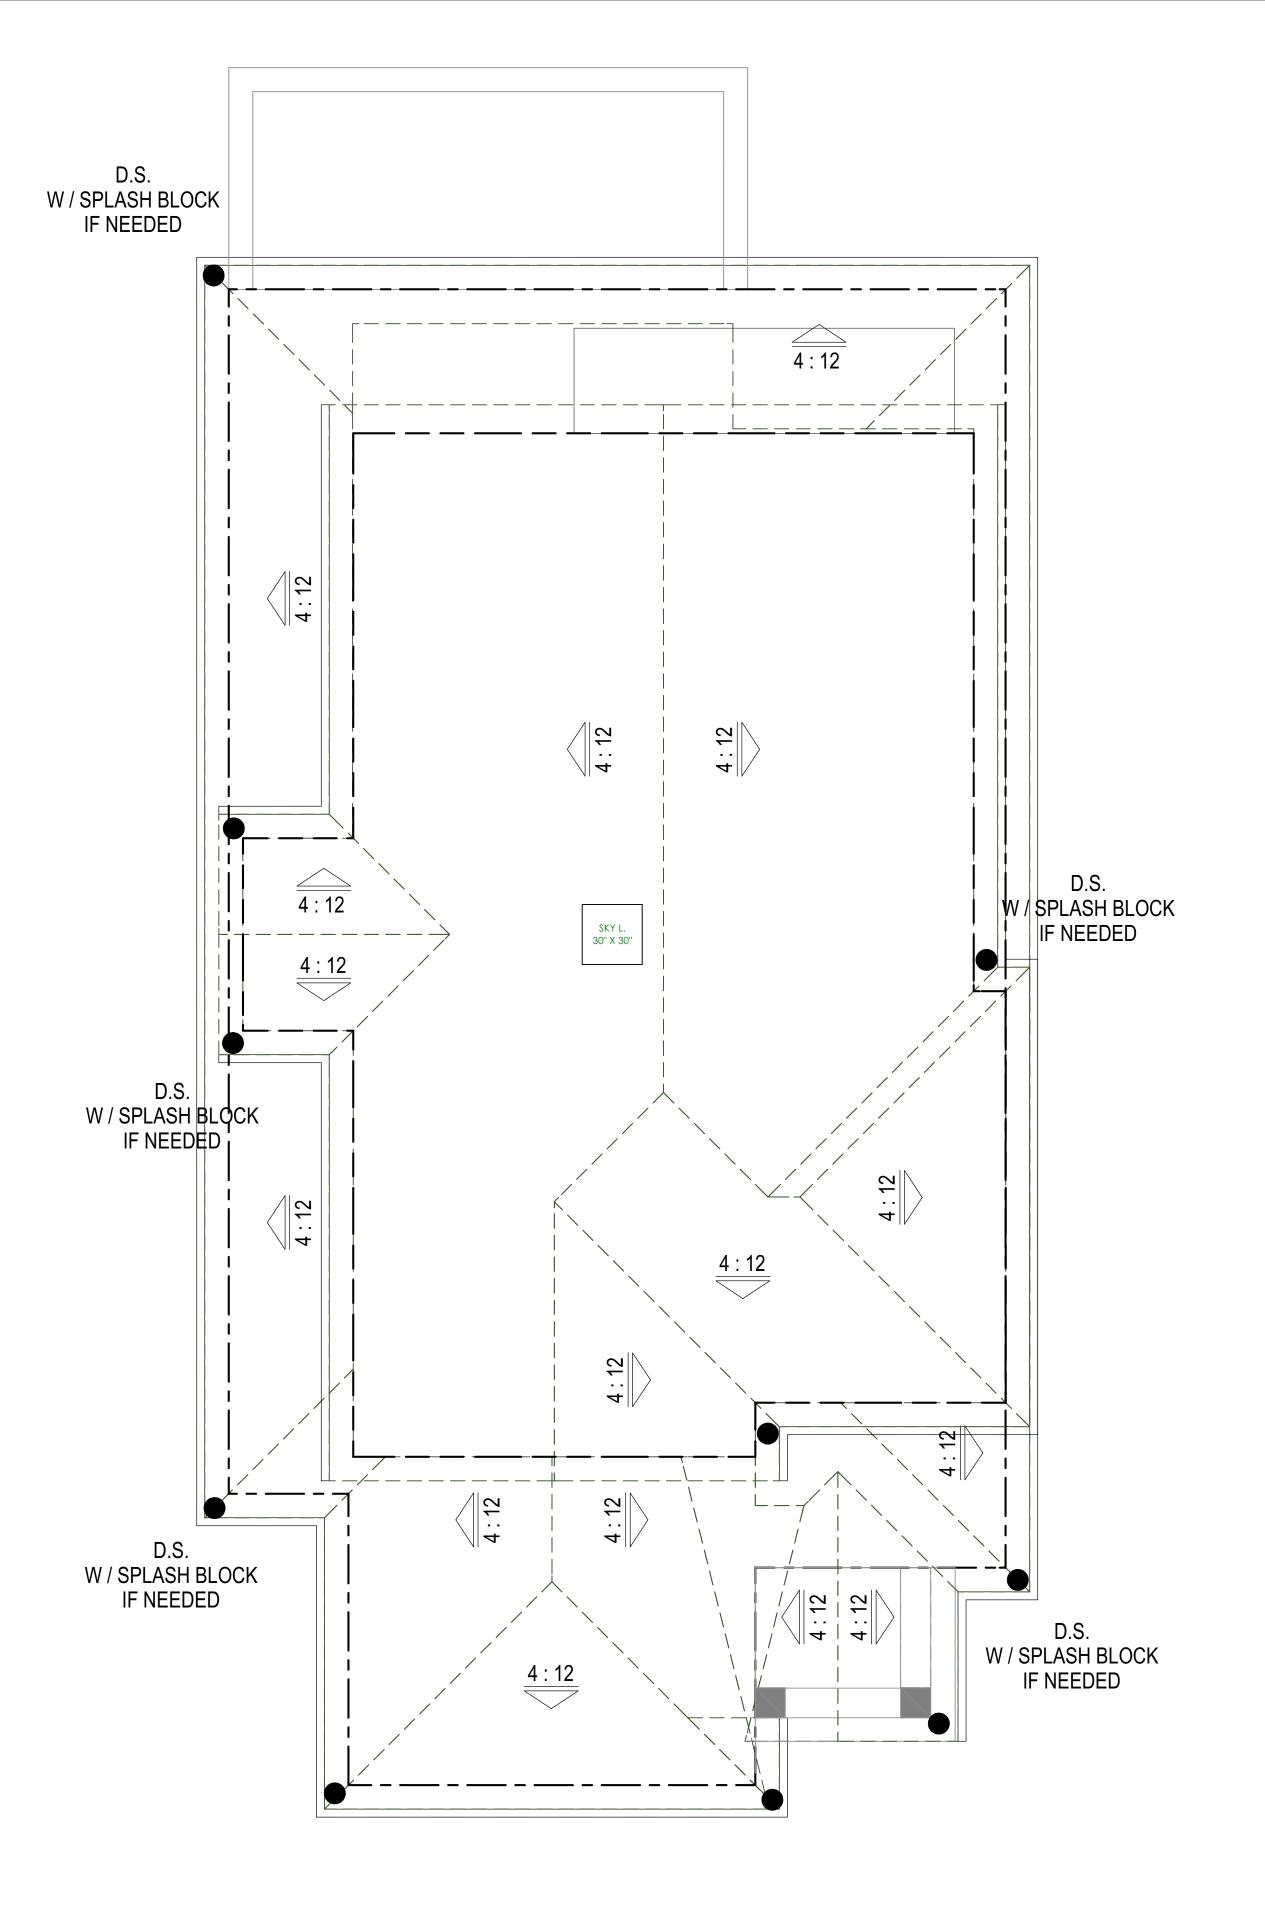

PROPOSED ROOF PLAN



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PROJECT NAME:

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36 BLOOMFIELD RD., BURLINGAME, CA 94010

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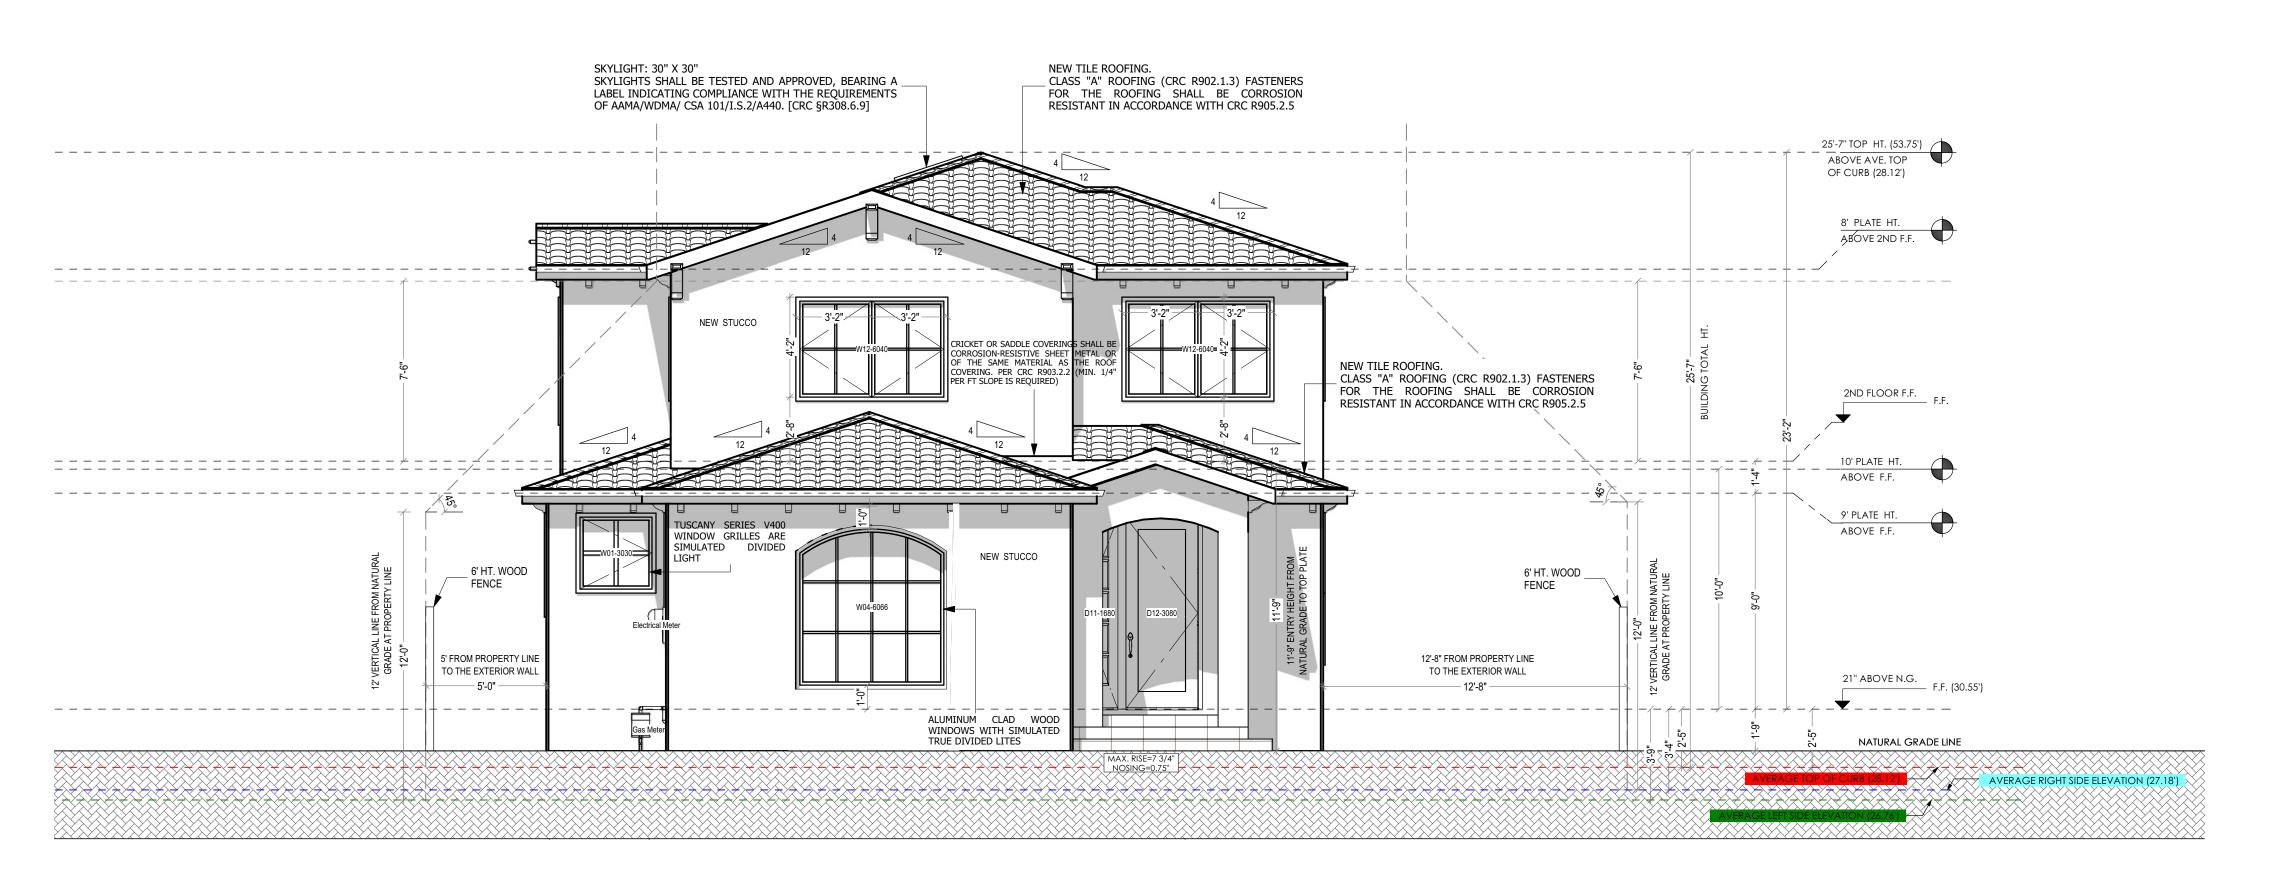
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SHEET TITLE:

PROPOSED 2ND FLOOR PLAN / ROOF PLAN


PROJECT ID:	2206-1
DATE:	OCT.202
SCALE:	1/4" =
DRAWN BY:	Z.F
SHEET NUMBER:	

A-01.02



PROPOSED FRONT (SOUTH-WEST) ELEVATION

SC: 1/4" = 1:-0"

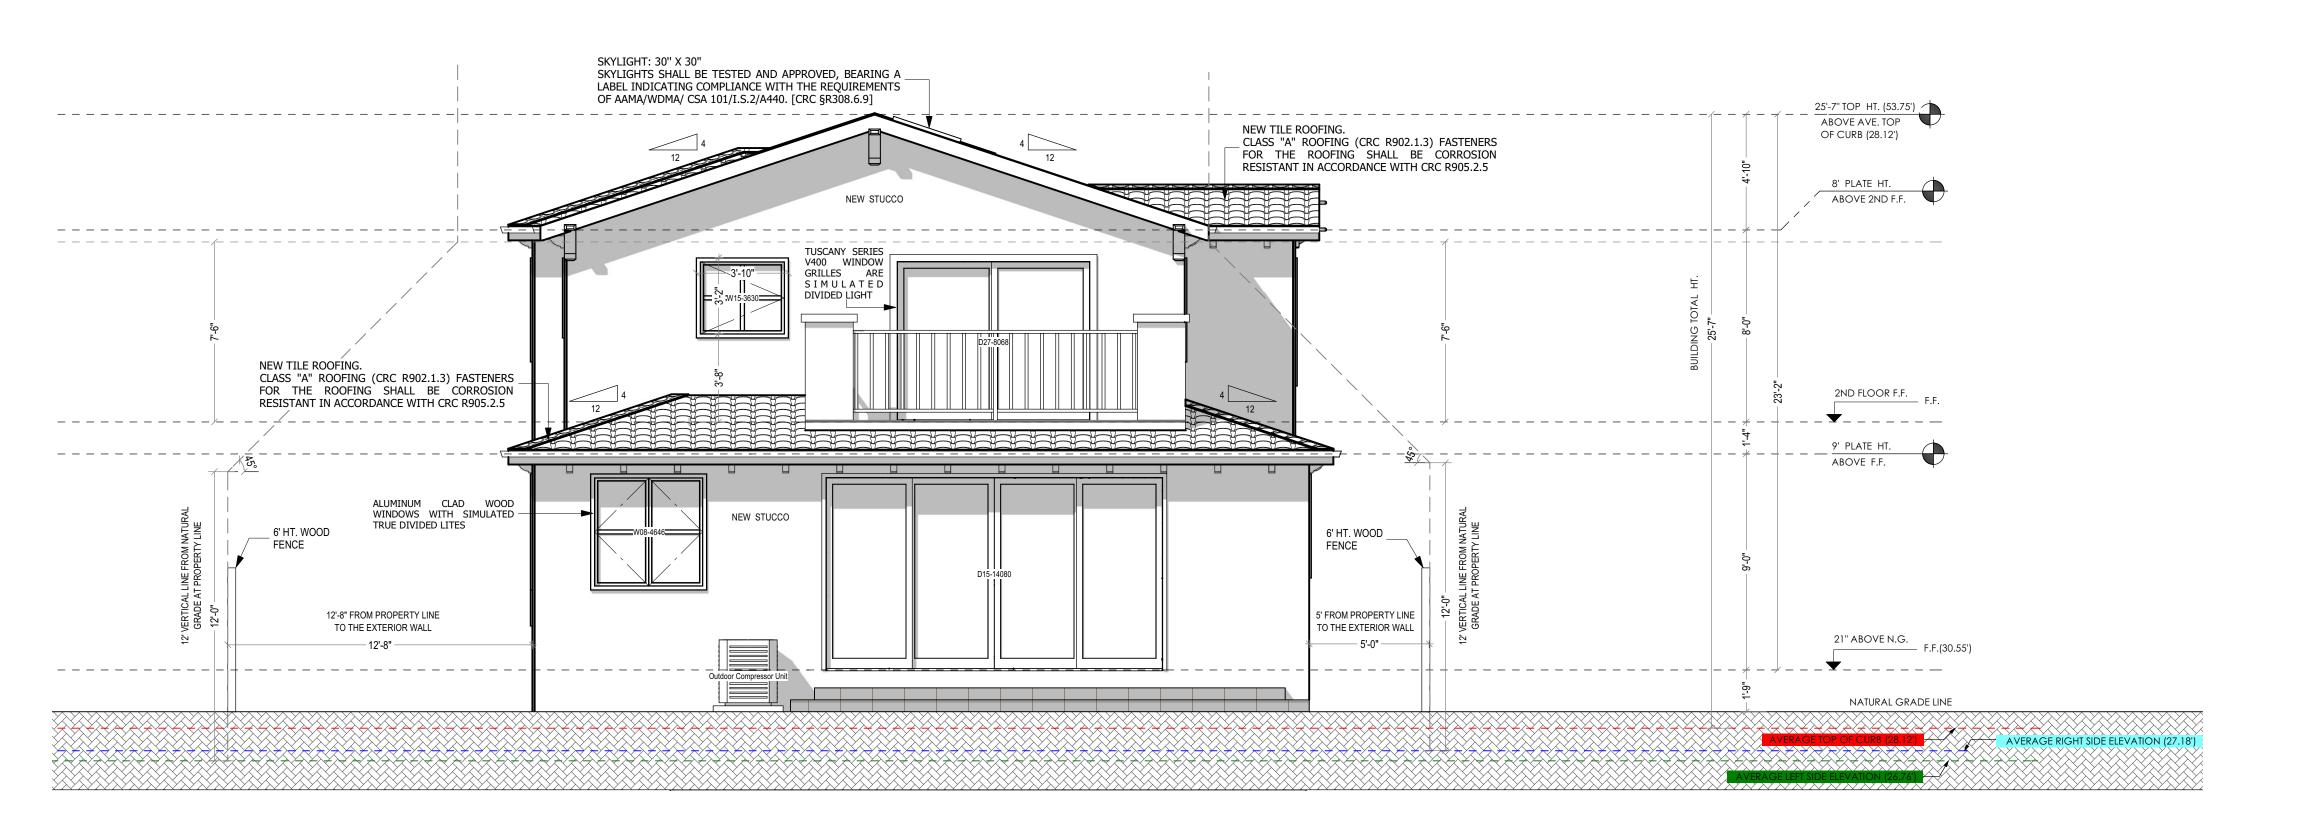

PROPOSED REAR (NORTH-EAST) ELEVATION

SC: 1/4" = 1'-0"



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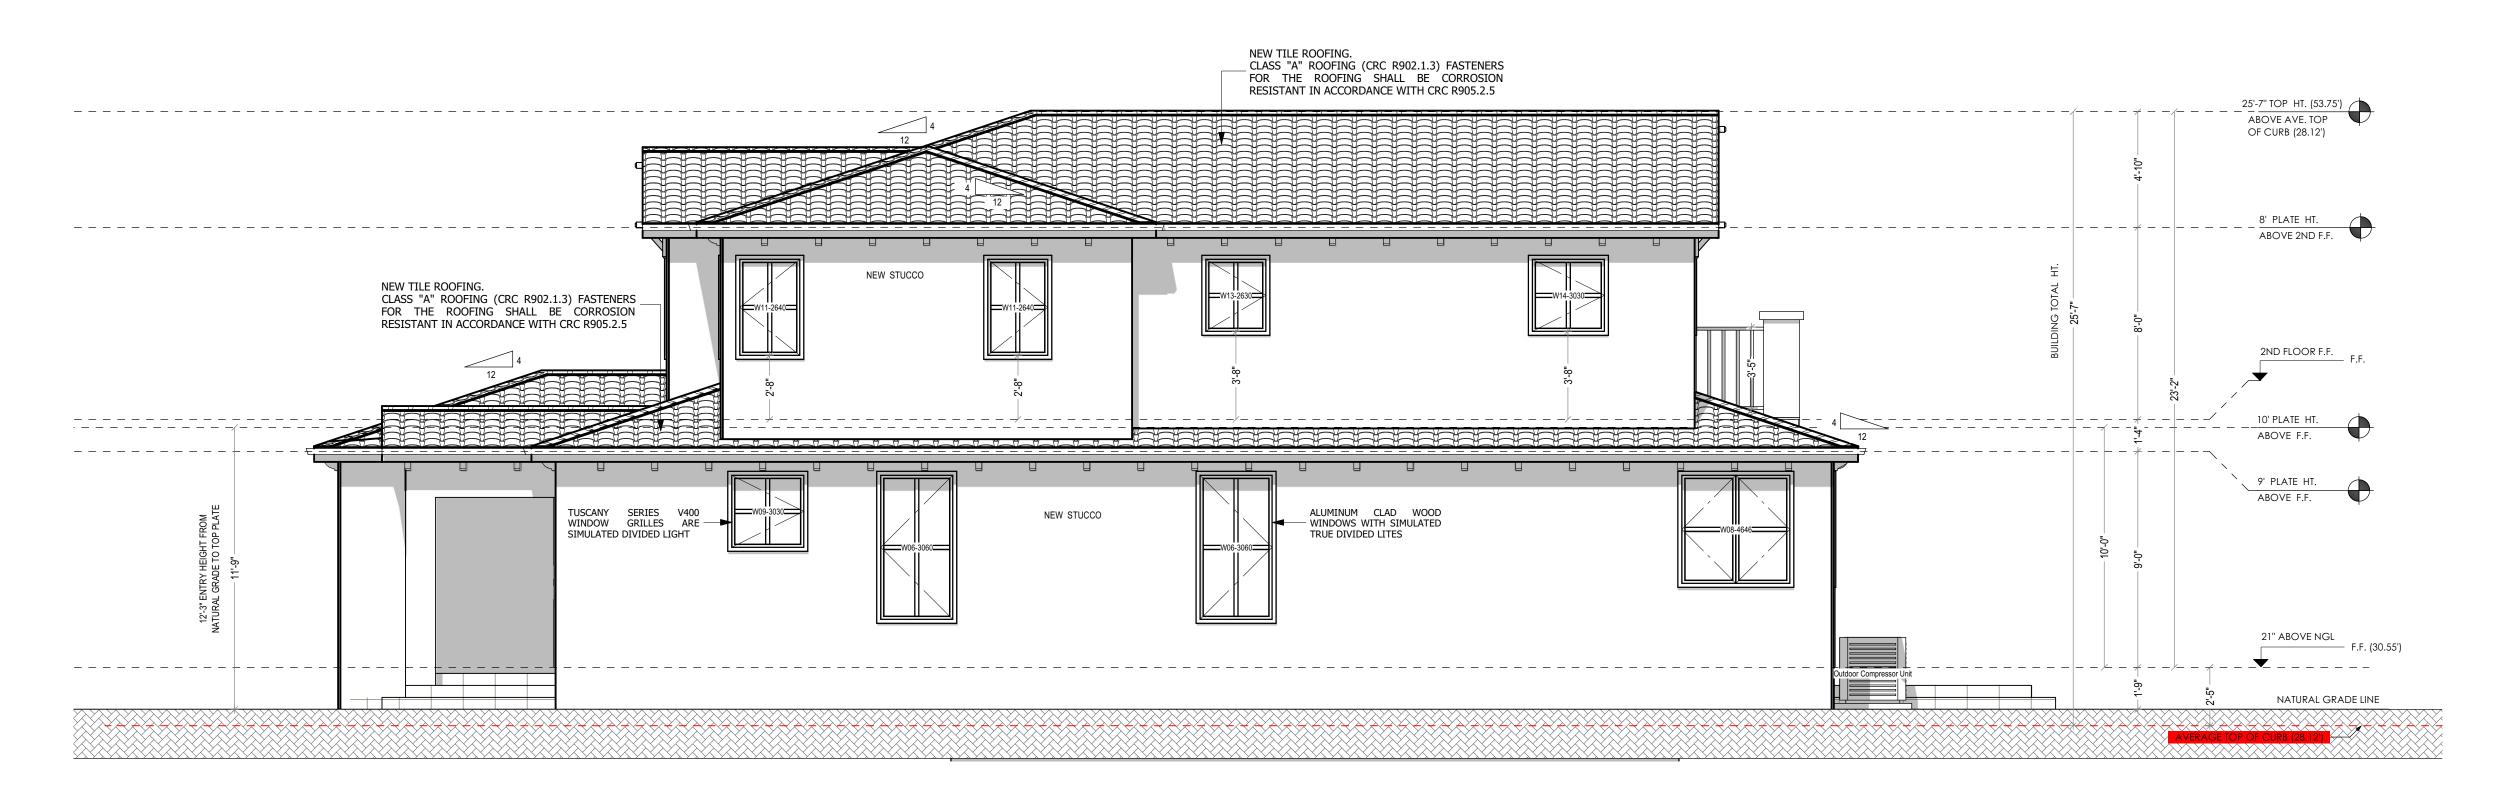
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SHEET TITLE:

PROPOSED ELEVATIONS


PROJECT ID:	2206-1
DATE:	OCT.202
SCALE:	1/4" =
DRAWN BY:	Z.ŀ
SHEET NUMBER:	

A-02.01



PROPOSED RIGHT (SOUTH-EAST) ELEVATION

SC: 1/4" = 1'-0"

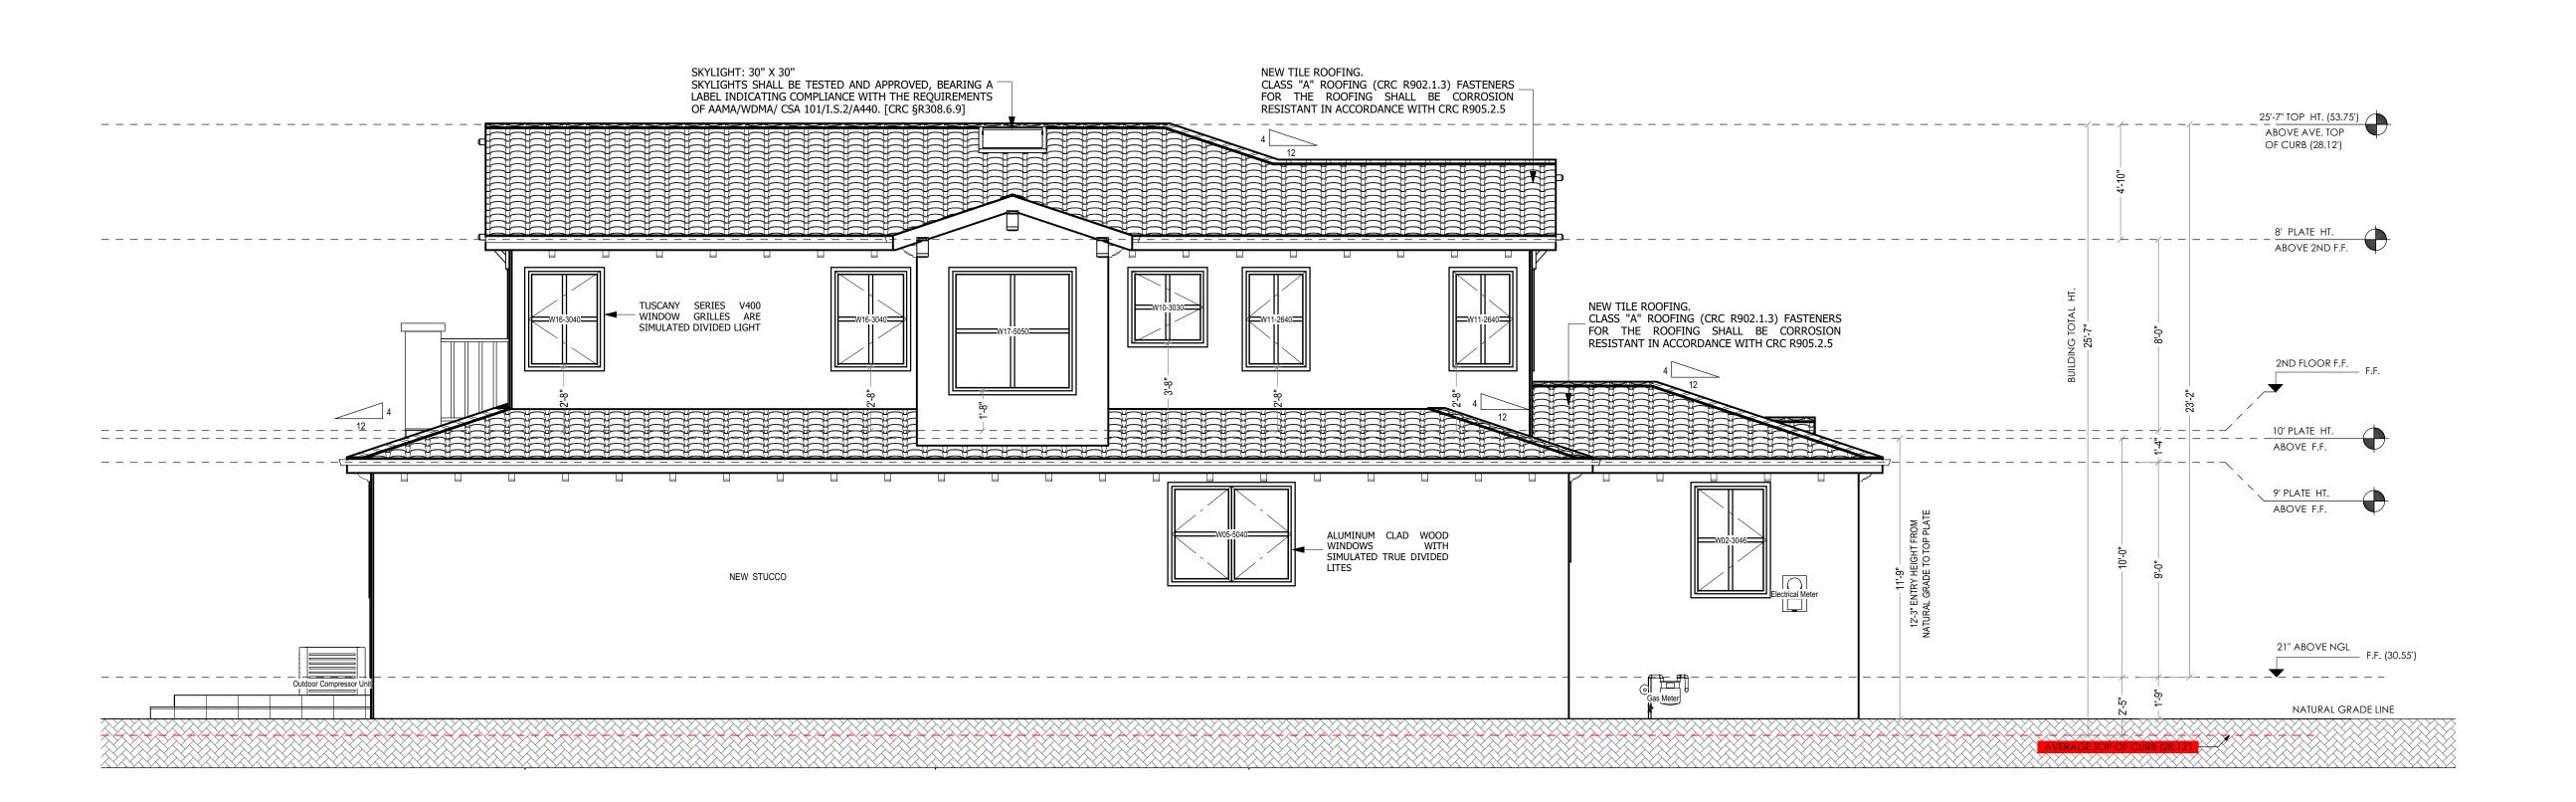

PROPOSED LEFT (NORTH-WEST) ELEVATION

SC: 1/4" = 1'-0"



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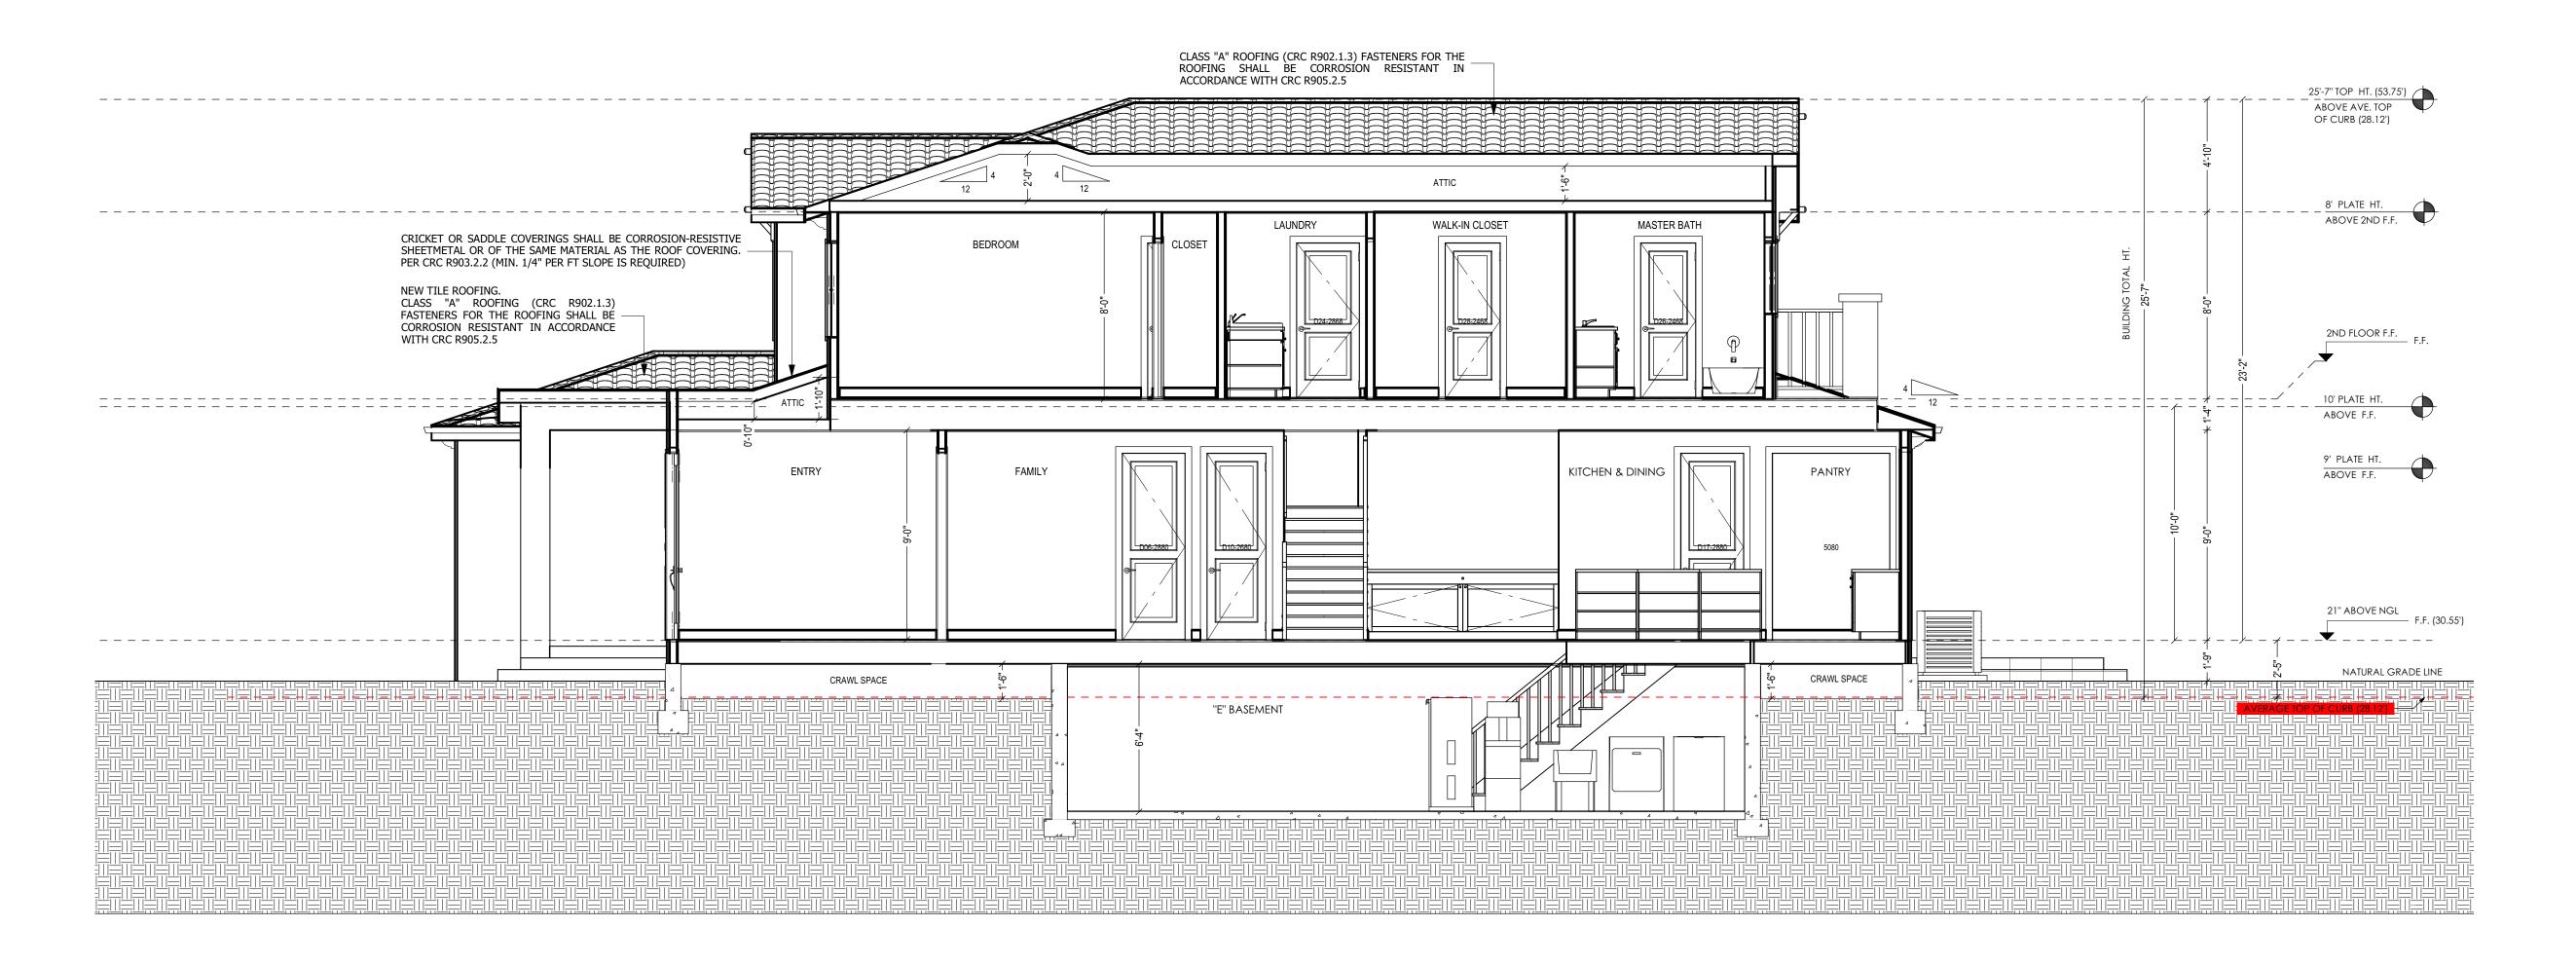
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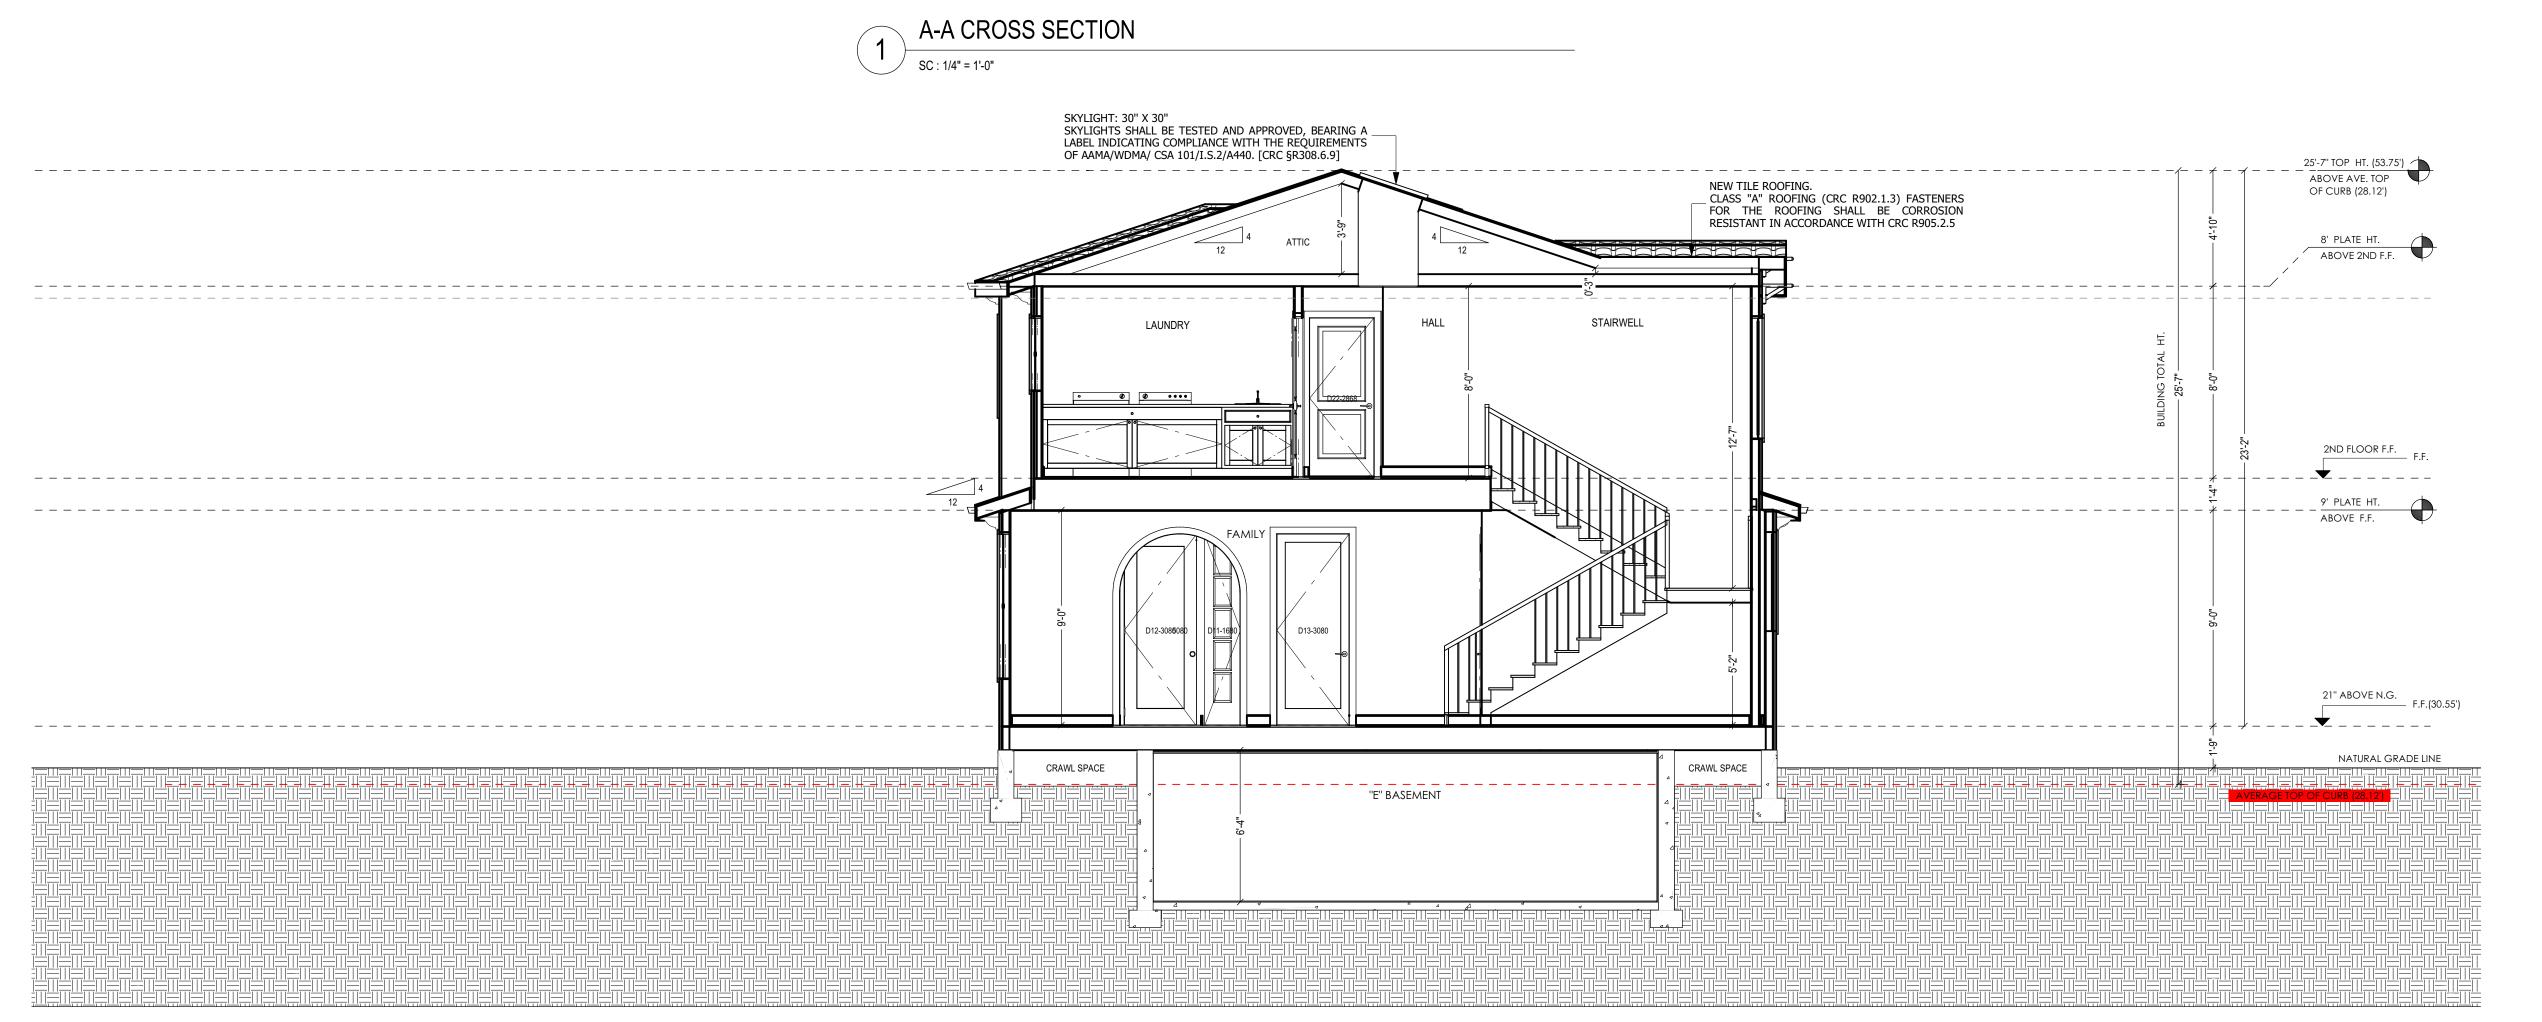
SHEET TITLE:

PROPOSED ELEVATIONS

PROJECT ID:	2206-12
DATE:	OCT.2022
SCALE:	1/4" = 1
DRAWN BY:	Z.H.
SHEET NUMBER:	

A-02.02









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4010 MOORPARK AVE#101, SAN JOSE, CA 95117 TELL: (415)254.1606 E-MAIL: OFFICE@AMSDESIGNLLP.COM

Azadeh Masrou

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PROJECT NAME:

BLOOMFIELD RESIDENCE

36 BLOOMFIELD RD., BURLINGAME, CA 94010

REVISION TABLE:

^			
	REVISION DATE	BY	DEP
01	04.06.2023	S.A.	PLN
02	05.24.2023	S.B.	PLN
03	08.01.2023	A.G.	PLN
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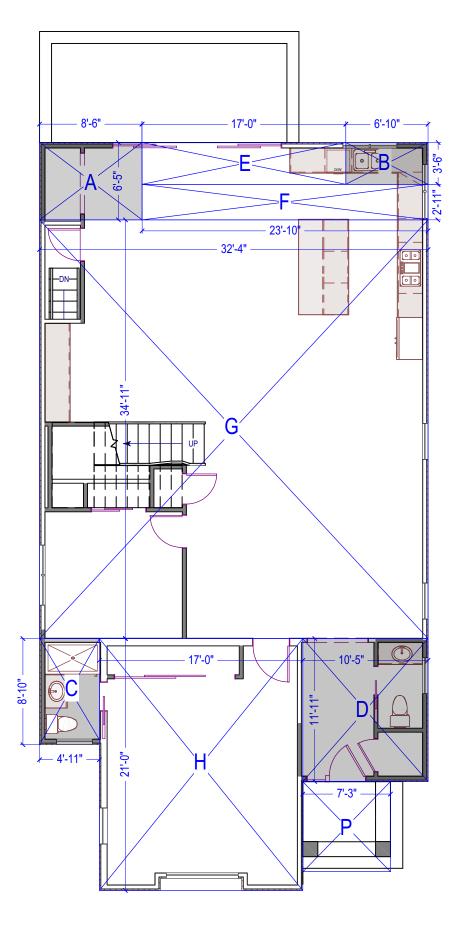
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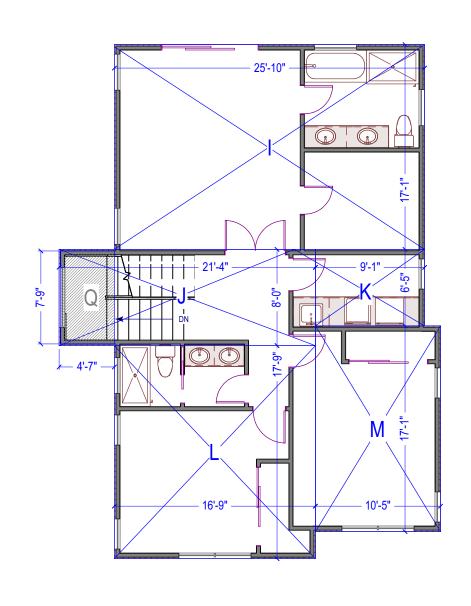
PROPOSED SECTIONS


	PROJECT ID:	2206-12
	DATE:	OCT.2022
	SCALE:	1/4" = 1
	DRAWN BY:	Z.H
	CHEET NII IMBED:	

SHEET NUMBER:

A-03.01





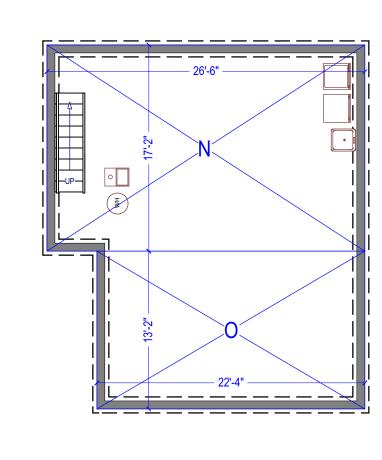

1ST FLOOR AREA DIAGRAM SCALE: 1/8" : 1'

2ND FLOOR AREA DIAGRAM

BASEMENT AREA DIAGRAM

SCALE: 1/8": 1'

FLOOR AREA DIAGRAM (PROPOSED PLAN):

SCALE: 1/8": 1'

FLOORS	SPACES	SIZE	AREAS (SQF)	ТОТ	AL
NEW ADDITION	А	8'-6" X 6'-5"	55		
TO LIVING	В	6'-10" X 3'-6"	24	04/	
AREA(1ST	С	8'-10" X4'-11"	43	246	
FLOOR)	D	11'-11" X10'-5"	124		1862
EXISTING	Е	17'-0" X 3'-6"	60		1002
LIVING AREA	F	23'-10" X 2'-11"	70	1/1/	
(1ST FLOOR)	G	34'-11" X 32'-4"	1129	1616	
(101120011)	Н	21'-0" X 17'-0"	357		
	I	25'-10" X 17'-1"	441	1145	
2ND FLOOR	J	21'-4" X 8'-0"	171		
LIVING AREA	K	9'-1" X 6'-5"	58		45
	L	17'-9" X 16'-9"	297		
	М	17'-1" X 10'-5"	178		
TOTAL BUILDING AREA)7
EXISTING	N	26'-6" X 17'-2"	455	7.4	0
BASEMENT	0	22'-4" X 13'-2"	294	749	
COVERED PORCH	Р	9'-0" X 7'-3"	65	65	5

DECLINING HEIGHT ENVELOPE ENCROACHMENT:

FLOORS	SPACES	SIZE	AREAS (SQF)	TOTAL
ENCROACHMENT	Q	7'-9" X 4'-7"	35	35







EXTERIOR MATERIAL SCHEDULE:

TITLE	TYPE	INFO
ROOF	TILE ROOFING	
SIDING	STUCCO	SMOOTH
GARAGE DOOR	CLOPAY	DARK GRAY COLOR
DOOR	ALIBABA DOORS	DARK GRAY COLOR
WINDOWS	MILGARD	TUSCANY / DARK GRAY COLOR











AMS DESIGN

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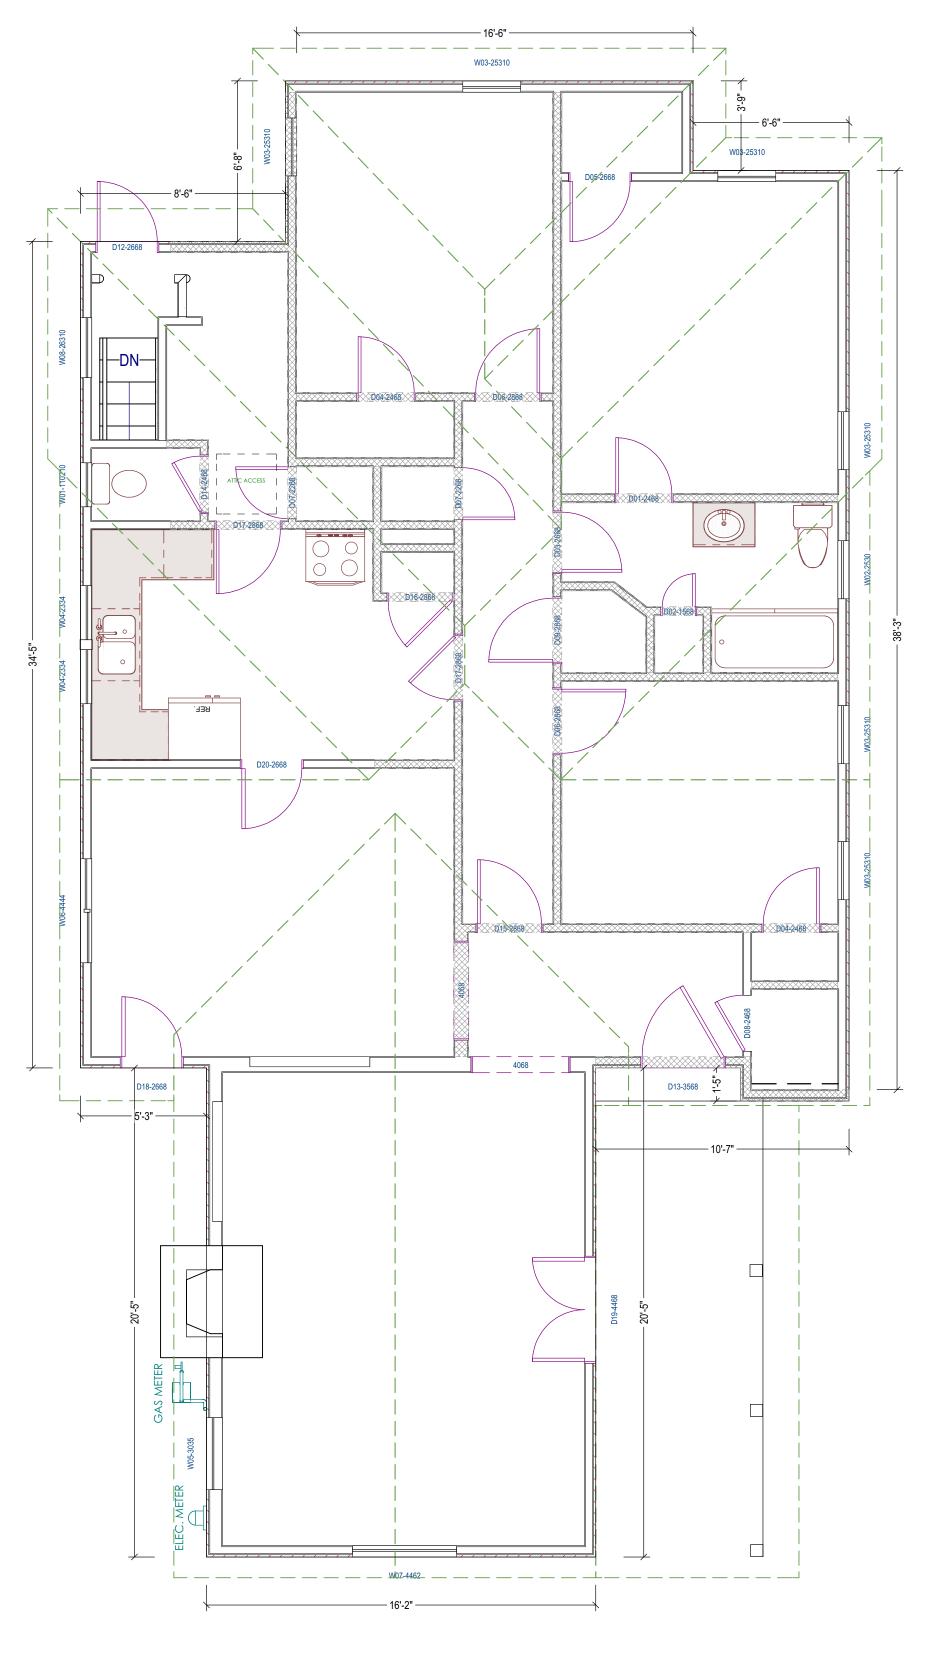
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SHEET TITLE:

FLOOR AREA DIAGRAM / **EXTERIOR MATERIAL SCHEDULE**


PROJECT ID:	2206-12
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SCALE:	1/8" = 1
DRAWN BY:	Z.H
SHEET NUMBER:	

A-04.01



EXISTING FOOT PRINT PLAN


SC: 1/4" = 1'-0"

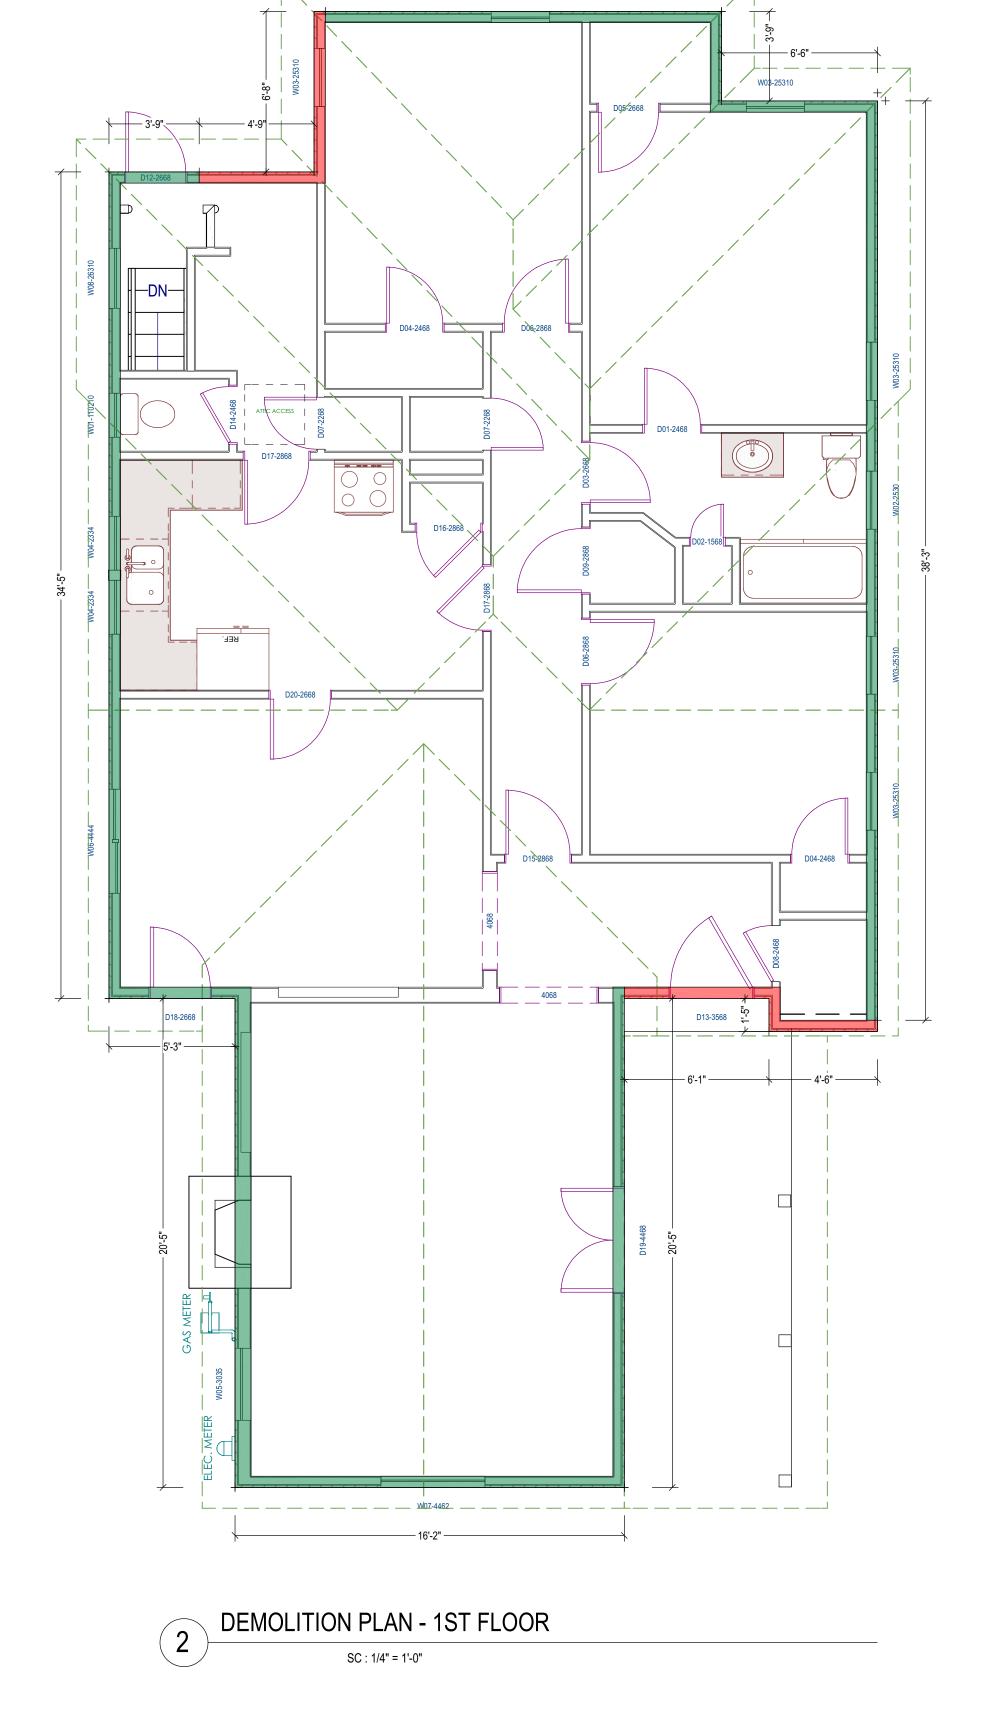

W03-25310

FLOORS	EXISTING FOOT PRINT (LINEAR FEET)	WIDTH OF PRESERVED WALL FRAMING IN LINEAR FEET (INCLUDING EXISTING OPENINGS)	WIDTH OF DEMOLISHED WALL FRAMING IN LINEAR FEET (INCLUDING NEW AND ENLARGED OPENINGS)
FIRST	188'-10''	165'-5"	23'-5''

SINCE 165'-5" IS GREATER THAN 23'-5" THEN NO TECH DEMO

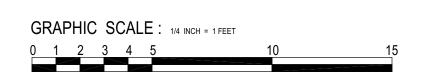





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SHEET TITLE:

NORTH

EXISTING FOOT PRINT PLAN / DEMOLITION PLAN

PROJECT ID:	2206-12
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SCALE:	1/4"=1'
DRAWN BY:	Z.H.

SHEET NUMBER:

A-04.02