



## CALIFORNIA DRIVE LIVE/WORK

LOOKING SOUTH ALONG CALIFORNIA DRIVE

31 MAY 2017

#### SITE CONTEXT

619-625 California Drive Burlingame CA 94010

Job #15666



Peninsula Building • 307 South "B" Street #12 • San Mateo CA 94401 • 650 • 343 • 3452





#### LOOKING WEST ALONG CALIFORNIA DRIVE

## CALIFORNIA DRIVE LIVE/WORK

31 MAY 2017

#### SITE CONTEXT

619-625 California Drive Burlingame CA 94010



Ellis A. Schoichet AIA Architect

Peninsula Building

• 307 South "B" Street #12

• San Mateo CA 94401

• 650 • 343 • 3452



Caltrain ROW

LOOKING NORTHEAST ALONG OAK GROVE AVENUE

#### CALIFORNIA DRIVE LIVE/WORK

31 MAY 2017



619-625 California Drive Burlingame CA 94010



Peninsula Building • 307 South "B" Street #12 • San Mateo CA 94401 • 650 • 343 • 3452

2016 California Residential Code (CRC) [2015 IRC as amended] 2016 California Green Building Standards Code (CalGreen) City of Burlingame Municipal Code

Americans with Disabilities Act (ADA)

- 2. If work is required in a manner that makes it impossible to produce first class work, or should discrepancies appear within these Contract Documents and/or conditions at the site; the Contractor shall Request an interpretation from the Architect before proceeding with any directly or indirectly related work.
- 3. The Architect shall not be responsible for construction means, methods, techniques, sequences or procedures, or for safety precautions and programs in connection with the Work, nor shall the Architect be responsible for the Owner's or any Contractor's failure to employ proper safety
- 4. These documents are property of Ellis A. Schoichet AIA, and are protected by copyright. Reproduction or reuse in any form without written permission is prohibited.



#### DRAWING NOTES

Centerline indicated with

- 1. Dimensions take precedence over scale. DO NOT SCALE DRAWINGS.
- 2. All dimensions are taken to face of stud, except where noted otherwise: FOC Face of Concrete FOM Face of masonry
- 3. Verify all dimensions in field and notify Architect of any discrepancies.
- 4. Center all doors, windows, fireplaces, etc... on walls, unless shown otherwise.
- 5. Wall return at door jamb adjacent to perpendicular wall to be 6", unless shown otherwise

MH

MOL

Manhole

More or less

ь.	ABBREVIATIONS (1)					
	AC	Asphaltic concrete	(N)	New		
	A/C	Air conditioning	NIC	Not in contract		
	AD	Area Drain	NP	New paving		
	ADJ	Adjustable	NTS	Not to scale		
	AFF	Above finish floor	OD	Outside diameter		
	AHJ	Authority having jurisdiction	O/F	Overflow		
	B.O.	Bottom of	ОН	Overhead or Opposite Hand		
	BOIC	Purchase by Owner,	OPG	Opening		
		inallation by Contractor	PA	Planted area		
	BSL	Building setback line	PG	Proposed grade		
	BUR	Built-up roofing	PL	Property line		
	CATV	Cable television	PLYWD	Plywood		
	CB	Catch basın	PT	Pressure treated		
	Ą.	Centerline	PT.	Point		
	CLR	Clear	PUE	Public utility easement		
	CO	Cleanout	PV	Photo-voltaic		
	CONC	Concrete	(R)	Remove existing and replace with		
	C.OPG	Cased opening	RCP	Reflected Ceiling Plan		
	COTG	Cleanout to grade	RDWD	Redwood		
	D.	Detail	RO	Rough opening		
	DLO	Daylight opening	ROW	Right of way		
	DS	Downspout	RV	Roof vent		
	(E)	Existing	SCD	See Civil drawing		
	EA	Each	SD	Storm draing		
	E.A.		SL	Skylight		
	EG	Exposed aggregate	5Q			
	EM	Existing grade	5G 55	Square		
		Electric meter		Sanitary sewer		
	EQ	Equal	55CO	Sanitary sewer cleanout		
	EP	Existing paving	SSD	See Structural drawing		
	FD	Floor drain	SSE	Sanitary sewer easement		
	FE	Fire extinguisher	S≰P	Shelf and pole		
	FEC	Fire extinguisher cabinet	TB	Towel bar		
	FF 	Finish floor	TBD	To be determined		
	FFE	Finish floor elevation	TBS	To be selected		
	FL	Flow line	TEL	Telephone		
	F.O.	Face of	T.O.	Top of		
	FOC	Face of concrete	TOS	Top of slab		
	FOM	Face of masonry	TW	Top of wall		
	FOS	Face of stud	TYP	Typıcal		
	FP	Finish paving	T <b>¢</b> B	Top and bottom		
	FS	Floor sink	TŧG	Tongue and groove		
	FVA	Free ventilating area	UG	Underground		
	GM	Gas meter	UON	Unless otherwise noted		
	G5	Galvanized steel	V	Vent		
	HDWD	Hardwood	VIF	Verify in field		
	HT	Height	VWM	Verify dimension with product		
	ΙΒ	Ironing board		manufacturer's requirements		
	ID	Inside diameter	VWO	Verify with Owner		
	IRR	Irrigation controls	VWS	Verify dimension with design-buil		
	JP	Joint pole		subcontractor's requirements		
	LOC	Location	WD	Wood		
	MC	Medicine cabinet	W.I.	Wrought Iron		
	MEP	Mechanical, Electrical,	WM	Water meter		
		and Plumbing Plan	WP	Work point		
	MFR	Manufacturer	w.	Water valve		
	NAH	Manhola	Ø	Diameter		

Dıameter

#### REGULATORY COMPLIANCE NOTES

I. "Construction Hours" (See City of Burlingame Municipal Code, Section 13.04.100 for details.)

and non-City Holidays between 8:00 a.m. and 5:00p.m.

Weekdays: 8:00 a.m. - 7:00 p.m. Saturdays: 9:00 a.m. - 6:00 p.m. Sundays and Holidays: No work allowed

Construction hours in the City Public right-of-way are limited to weekdays

- 2. Any hidden conditions that require work to be performed beyond the scope of the building permit issued for these plans may require further City approvals including review by the Planning Commission. The building owner, project designer, and/or contractor must submit a Revision to the City for any work not graphically illustrated on the Job Copy of the plans prior to performing the work.
- 3. Roof eaves and overhangs will not project within two feet of the property line.
- 4. At the time of Building Permit application, when applicable, plans and engineering will be submitted for shoring as required by 2016 CBC, Chapter 31 regarding the protection of adjacent property and as required by OSHA. The following will be addressed:
- a. Walls of excavations shall be properly shored prior to constructionactivity. Where temporary shoring is needed a competent contractor shall be consulted for recommendations and design of the shoring scheme for the excavation. The recommended design and type of shoring shall be approved by the engineer of record or soils engineer prior to usage.
- b. All appropriate guidelines of OSHA shall be incorporated into the shoring design and implemented by the contractor. Where space permits, temporary construction slopes may be utilized in lieu of shoring. Maximum allowable vertical cut for the subject project will be five (5) feet. Beyond that Horizontal benches of 5 feet wide will be required. Temporary shores shall not exceed I to I (horizontal to vertical). In some areas due to high moisture content / water table, flatter slopes may be required if so recommended by the soils engineer in the field.
- c. If shoring is required, the plans will specify the licensed design professional that has sole responsibility to design and provide adequate shoring, bracing, formwork, etc. as required for the protection of life and property during Construction of the building.
- d. Where provided, shoring and bracing shall remain in place until the affected floors, roof, and/or wall sheathing have been constructed and are completely self-supporting.
- e. Shoring plans shall be wet-stamped and signed by the engineer-of-record and submitted to the city for review prior to construction. If applicable, include surcharge loads from adjacent structures that are within the zone of Influence (45 degree wedge up the slope from the base of the excavation) and / or driveway surcharge loads.
- 5. An OSHA permit will be obtained if needed per CAL / OSHA requirements. See the Cal / OSHA handbook at: http://www.ca-osha.com/pdfpubs/osha userguide.pdf \* Construction Safety Orders: Chapter 4, Subchapter 4, Article 6, Section
- 6. A Grading Permit will be obtained from the Department of Public Works if
- 7. Plans submitted for building code plan check will include a complete underground plumbing plan including details for the location of all required oil interceptors and city-required backwater prevention devices.
- 8. This project is designed to comply with the following Accessibility regulations:
- a. California Building Code (CBC), Chapter 11A for public areas, common areas, and individual Live/Work units, except as described in item b. below.
- b. California Building Code (CBC), Chapter 11B for the 'Work' areas of Live/Work units #I-#5 which directly adjoin the public way on the First Floor. These areas are treated as areas of public accommodation.
- c. The Americans with Disabilities Act (ADA) for areas of public accommodation such as the First Floor 'Work' areas of Live/Work units #1-#5.
- d. The Fair Housing Act.
- 9. No public money of any kind will or will be used to construct this project.
- 10. No tax credits or rebates are sought for this project.
- II. Work areas within Live/Work units shall not include the use/storage of hazardous materials. Acceptable operational processes are limited to those where the majority of contents are either noncombustible or so arranged that a fire is not likely to spread rapidly.
- 12. Additional regulatory compliance information can be found on Regulatory Compliance Sheets/ RCI-RC5.1.

#### PROJECT DESCRIPTION

The Owner is proposing a 26 unit 'Live/Work' building at the corner of California Drive and Oak Grove Avenue in Burlingame. Five of the units will have street level work areas with storefronts along the California Drive frontage, and the remaining units will have the work areas within. A 26-car covered parking garage will be provided for the residents at grade level. Landscape improvements will be oriented to serve the public in the vicinity of the corner. Private amenities will also be provided, including secure covered bicycle parking, and a series of common gathering spaces on grade and at the Fourth Floor rooftop.

#### CODE COMPLIANCE

PLANNING DATA
---------------

ADDRESS:	619-625 California Drive, Burlingame CA
ASSESSOR'S PARCEL NUMBERS (Block/Lot):	029-131-140
	029-131-150
	029-131-160
Lot Size:	19,450 SF +/-
Zoning:	C-2, North California Drive Commercial District
FAR:	3.0
Use:	Live/Work

SETBACKS

<u>5215/10/10</u>	2		
	<u>PROPOSED</u>	REQUIRED	
FRONT (California Drive):	2'-0"	0'-0"	
STREET SIDE (Oak Grove Ave:)	2'-2"	0'-0" *	
SIDE:	6'-1"	0'-0" *	
REAR:	I O'-O"	10'-0"	
*NOTE: The side yards do not adjoin a	residential district so 5'-0" set	tback not required.	

#### **BUILDING HEIGHT**

	<u>PROPOSED</u> 5   '-8"	ALLOWED 35'-0" 55'-0" (SUBJECT TO CONDITIONAL USE PERMIT > 35')
LOT COVERAGE		
	<u>PROPOSED</u>	ALLOWED
	14,214 SF	14,586 SF (75%)

NOTE: Lot Coverage excludes sunshades on Soutwest / Rear Elevation

FLOOR AREA	PROPOSED	ALLOWED
FIRST FLOOR (GROSS):	14,214 SF	-
SECOND FLOOR (GROSS):	13,872 SF	-
THIRD FLOOR (GROSS):	13,872 SF	-
FOURTH FLOOR (GROSS):	7,047 SF	-
PENTHOUSE (GROSS):	59 SF	
TOTAL FLOOR AREA:	49,064 SF	58,344 SF (FAR 3.0)

NUMBER OF UNITS	PROPOSED	
FIRST FLOOR / SECOND FLOOR	I I UNITS	
THIRD FLOOR FOURTH FLOOR	I I UNITS 4 UNITS	

<u>PARKING</u>	PROPOSED	<u>REQUIRED</u>
Unistall spaces	25	25
Accessible van space	1	1
Total parking spaces provided:	26	26

26 UNITS

#### **BUILDING CODE DATA** Governing Code:

Total number of units provided:

Construction Type:

Occupancy Group:	MIXED O	MIXED OCCUPANCY	
	S2:	Parking Garage on First Floor	
	R2:	Live/Work Units on First - Fourth Floors	
		Trash area on First Floor: Incidental Use pe	

2016 California Building Code

First Floor Podium

Second - Fourth Floors

CBC Table 509 Mechanical Room on Fourth Floor A3: Common Roof Terrace on Fourth Floor

#### **California Drive Live-Work** 619-625 California Drive, Burlingame CA 94010

OWNER:	Ed Duffy / Renovattio Construction	415.533.4953
ARCHITECT:	EASA Architecture	650.343.3452
SURVEYOR:	Frederick T. Seher \$ Associates	415.921.7690
GEOTECHNICAL ENGINEER:	Romig Engineers	650.591.5224
CIVIL ENGINEER:	MacLeod \$ Associates, Inc.	650.593.8580
LANDSCAPE ARCHITECT:	Kıkuchı + Kankel Design Group	650.726.7100

#### VICINITY MAP



SHE

EET INI	DFX		
ARCHITEC			
AO.I	TITLE SHEET / NOTES		
AO.2	SITE PLAN		
ΑI	FIRST FLOOR PLAN		
A2	SECOND FLOOR PLAN		
A3	THIRD FLOOR PLAN		
A4	FOURTH FLOOR PLAN / LOW ROOF PLAN		
A5	ROOF PLAN		
A6	FRONT \$ REAR ELEVATIONS		
A7	SIDE ELEVATIONS		
A8	SECTIONS		
LANDSCAPE			

LANDSCAPE

SITE PLAN 4TH FLOOR ROOF TERRACE PLAN CORNER PLAZA CONCEPT IMAGES

PRELIMINARY GRADING, DRAINAGE AND UTILITY PLANS C- I C-2 STORMWATER TREATMENT PLAN

TOPOGRAPHIC SURVEY l of l

REGULATORY COMPLIANCE (UNDER SEPARATE COVER) RCI.I LOT COVERAGE AND FIRE DEPARTMENT ACCESS PLAN RC1.2 STAIR #2 PENTHOUSE PLAN AND SECTIONS

RC2 EXITING PLANS RC3.1 EXTERIOR WALL OPENINGS: PLAN

RC3.2 EXTERIOR WALL OPENINGS: ELEVATIONS RC4. I HOUSING ACCESSIBILITY RC4.2 HOUSING ACCESSIBILITY: ELEVATOR

RC4.3 RESERVED RC5. I PUBLIC ACCOMMODATION ACCESSIBLITY RC5.2 RESERVED

Ellis A. Schoichet AIA

Peninsula Building 307 South "B" Street #12 San Mateo CA 94401 650.343.3452

## California Drive Live-Work 619-625 California Dr. Burlingame, CA

APN#: 029-131-140 APN#: 029-131-150 APN#: 029-131-160

Ed Duffy / Renovattio Construction 415.533.4953

Architect: EASA Architecture 650.343.3452


FredrickT Seher & Associates, Inc. 415.921.7690

Romig Engineers 650.591.5224 Civil Engineer: MacLeod & Associates, Inc.

Geotechnical Engineer:

650.593.8580


Landscape Architect: Kikuchi + Kankel Design Group 650.726.7100

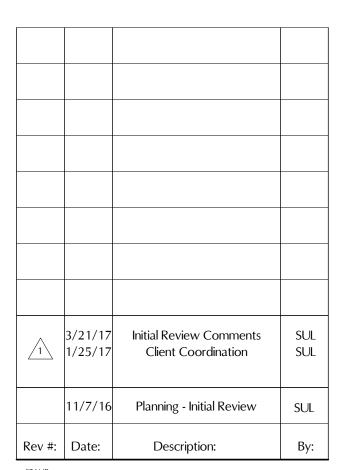




TITLE SHEET / NOTES

JOB#	15666	AS NOTED
DATE	11/07/16	SHEET
DRAWN	SUL	
CHECKED	EAS	AU.
REVIEWED		

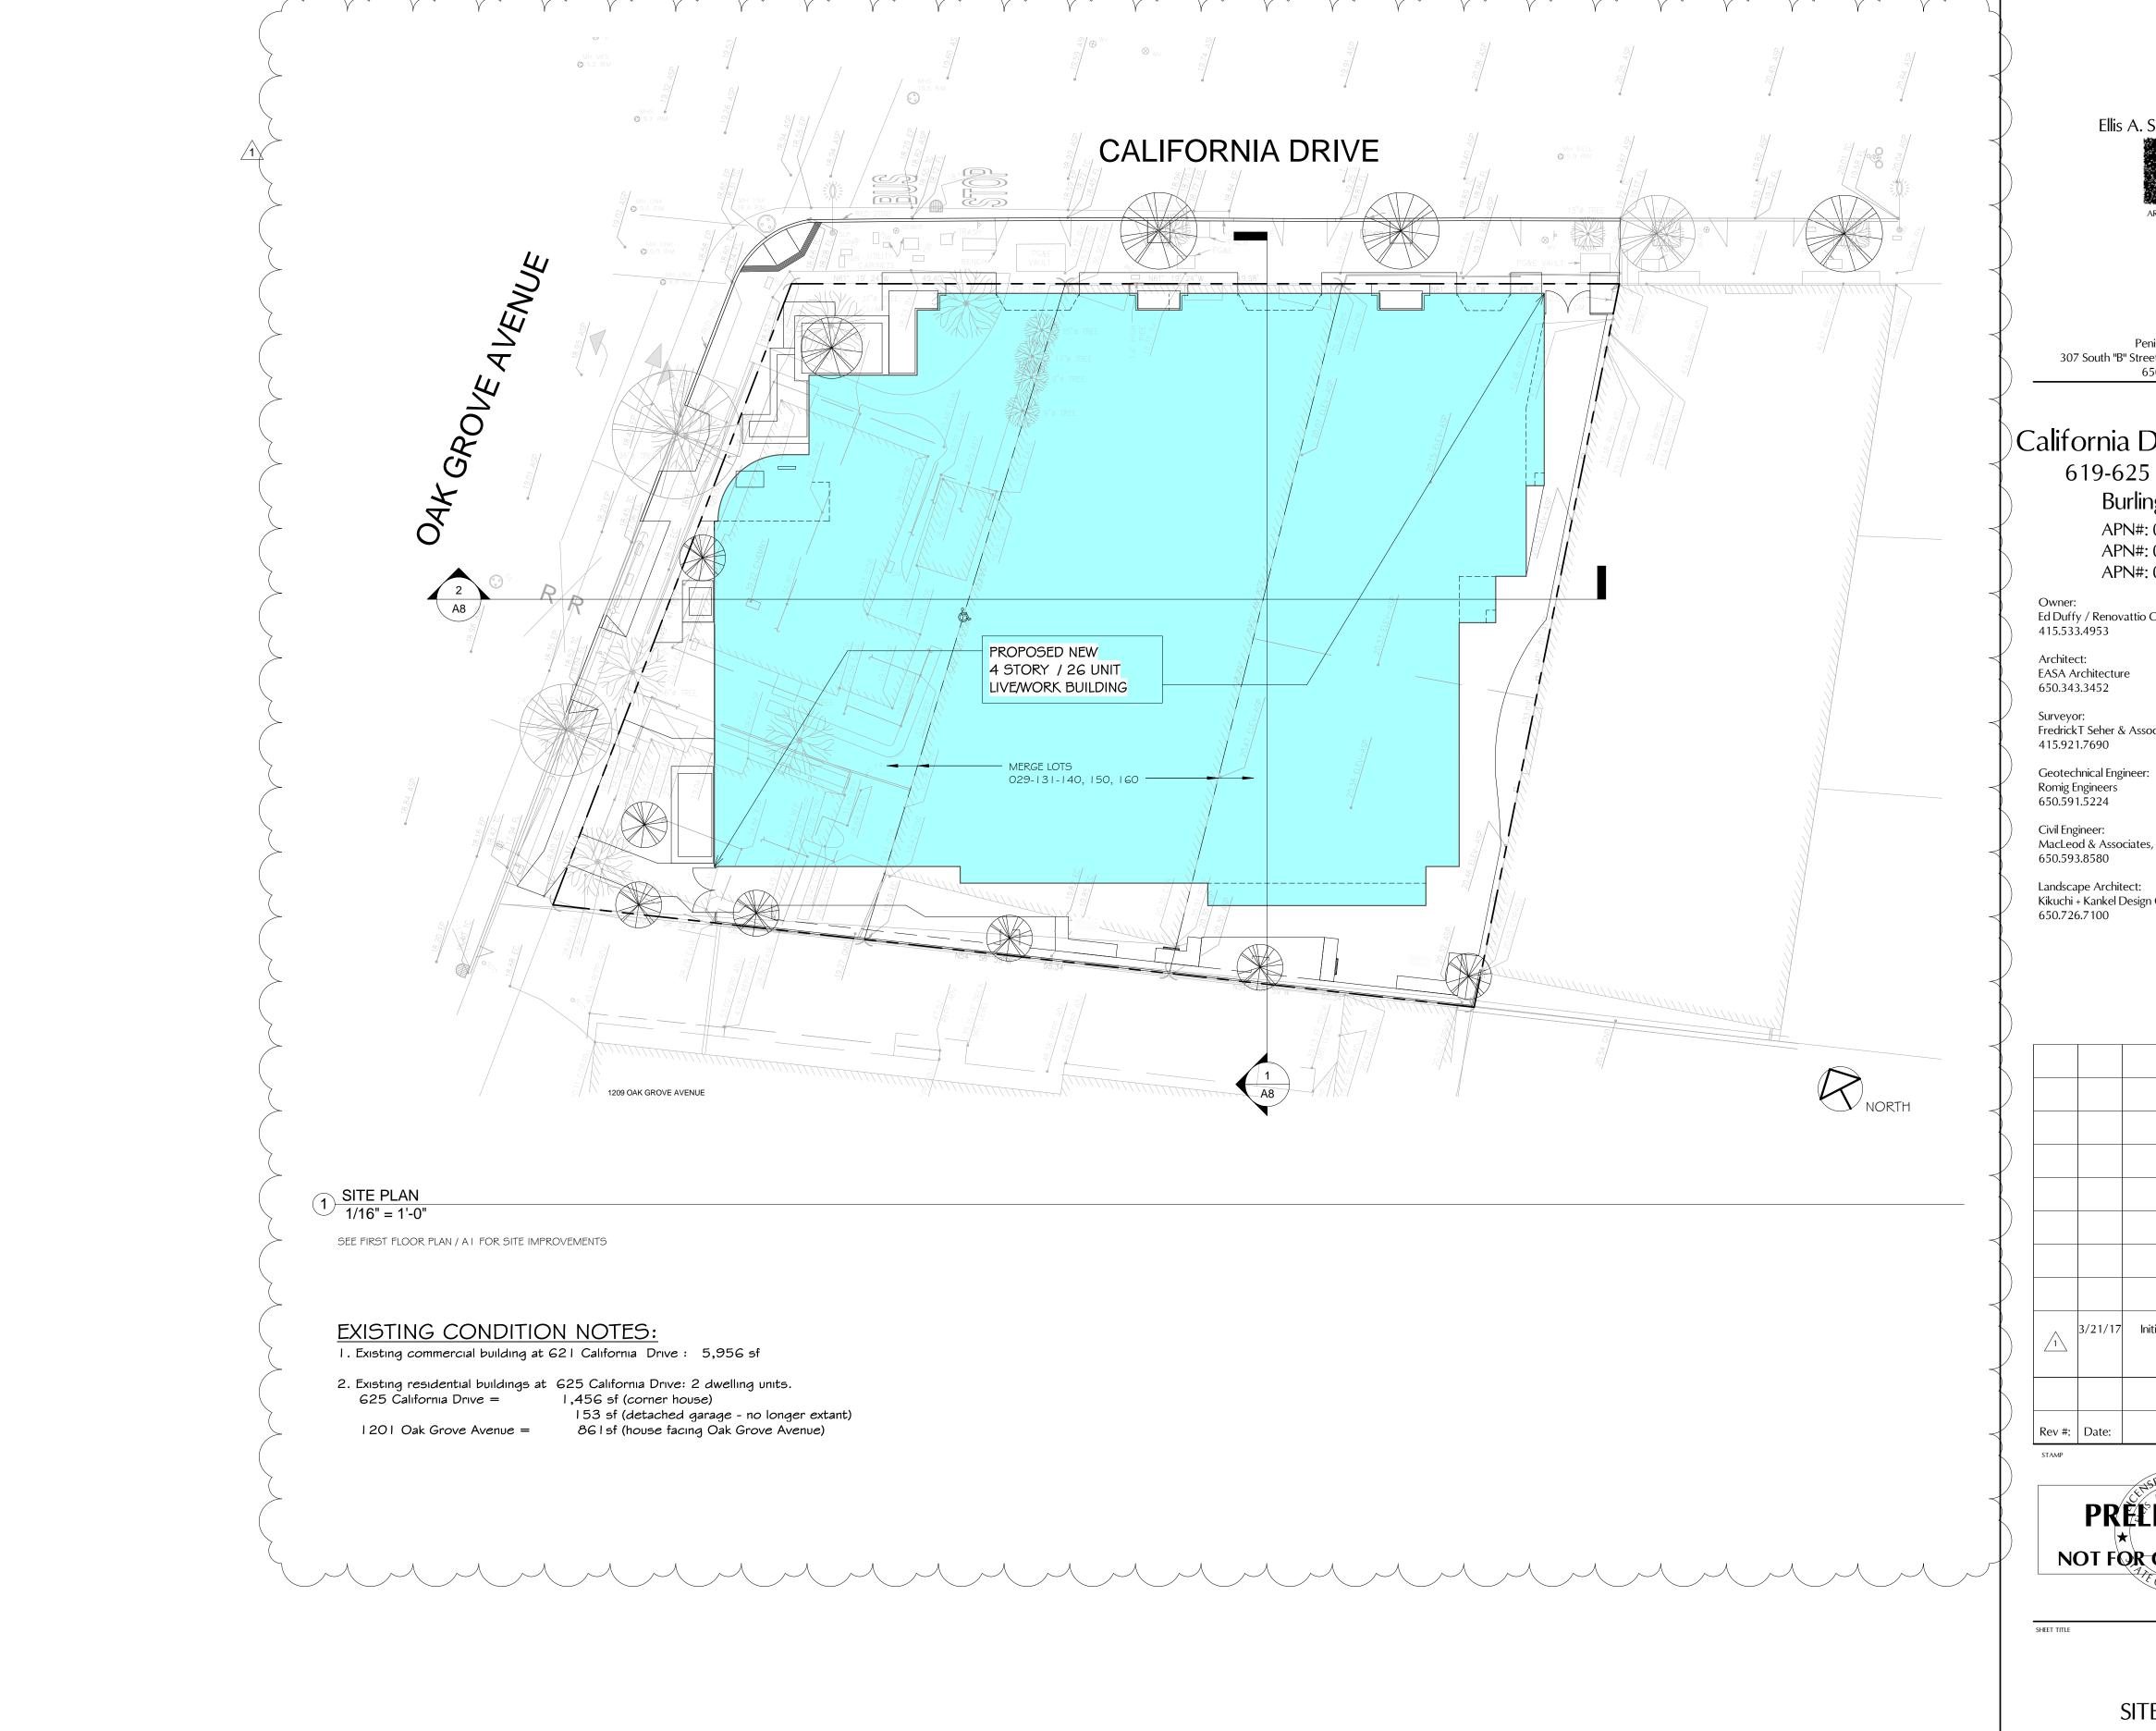

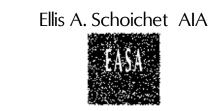

## California Drive Live-Work 619-625 California Dr. Burlingame, CA

APN#: 029-131-140 APN#: 029-131-150 APN#: 029-131-160

Owner: Ed Duffy / Renovattio Construction 415.533.4953


Architect: EASA Architecture

650.343.3452

FredrickT Seher & Associates, Inc. 415.921.7690

Romig Engineers 650.591.5224 Civil Engineer: MacLeod & Associates, Inc.


650.593.8580 Landscape Architect: Kikuchi + Kankel Design Group 650.726.7100

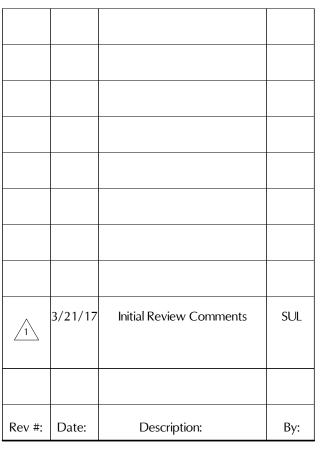

PRELIMINARY NOT FOR GONSTRUCTION

SITE PLAN

15666	AS NOTED
03/21/17	SHEET
Author	$\left  \left\langle \right\rangle \right\rangle \left  \left\langle \right\rangle \right\rangle \right $
Checker	( AU.2)
)	OF SHEETS

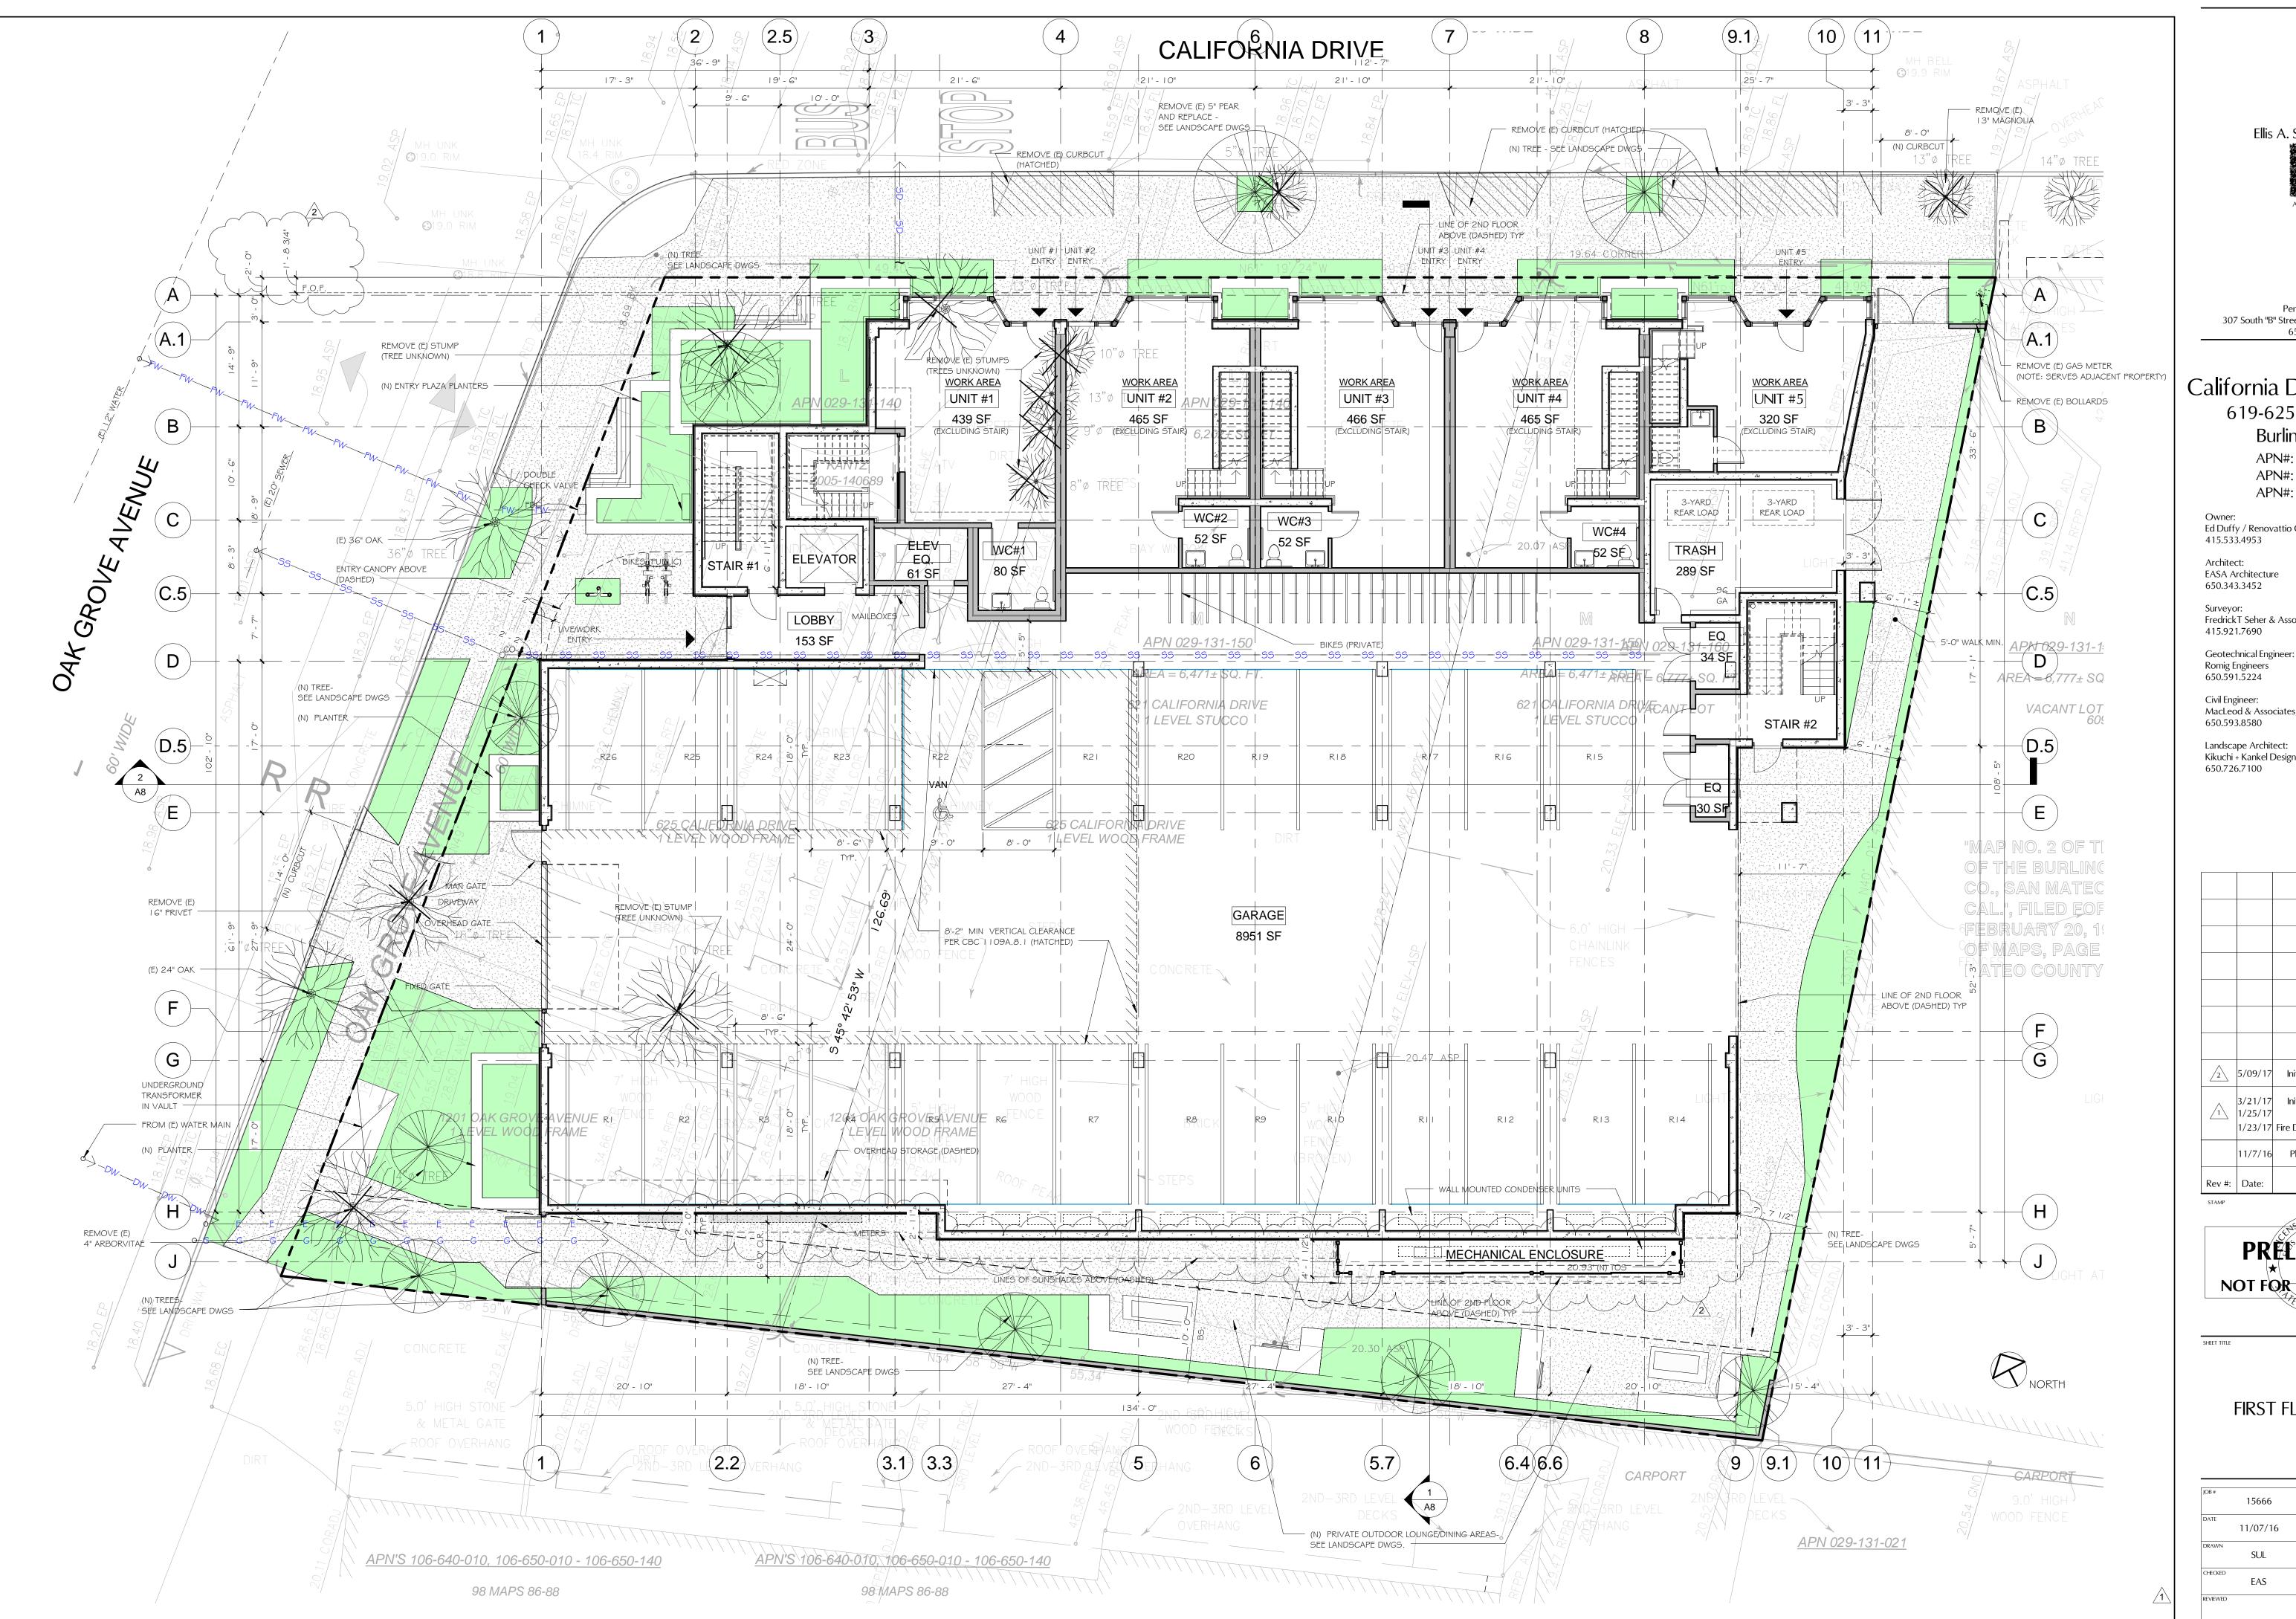



#### California Drive Live-Work 619-625 California Dr. Burlingame, CA

APN#: 029-131-140 APN#: 029-131-150 APN#: 029-131-160

Owner: Ed Duffy / Renovattio Construction 415.533.4953

Architect: EASA Architecture


650.343.3452

FredrickT Seher & Associates, Inc. 415.921.7690

Romig Engineers 650.591.5224

Civil Engineer: MacLeod & Associates, Inc. 650.593.8580


Landscape Architect: Kikuchi + Kankel Design Group 650.726.7100

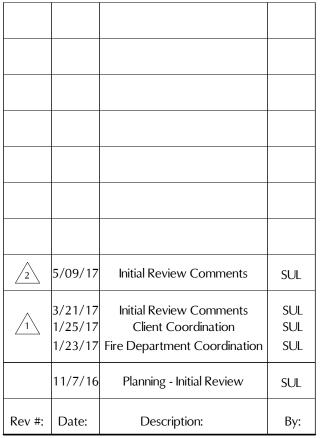

PRELIMINARY NOT FOR GONSTRUCTION

FIRST FLOOR PLAN

JOB#	15666	SCALE	1/8" = 1'-0"
DATE	11/07/16	SHEET	
DRAWN	SUL		۸ 1
CHECKED	EAS		AI
REVIEWED			

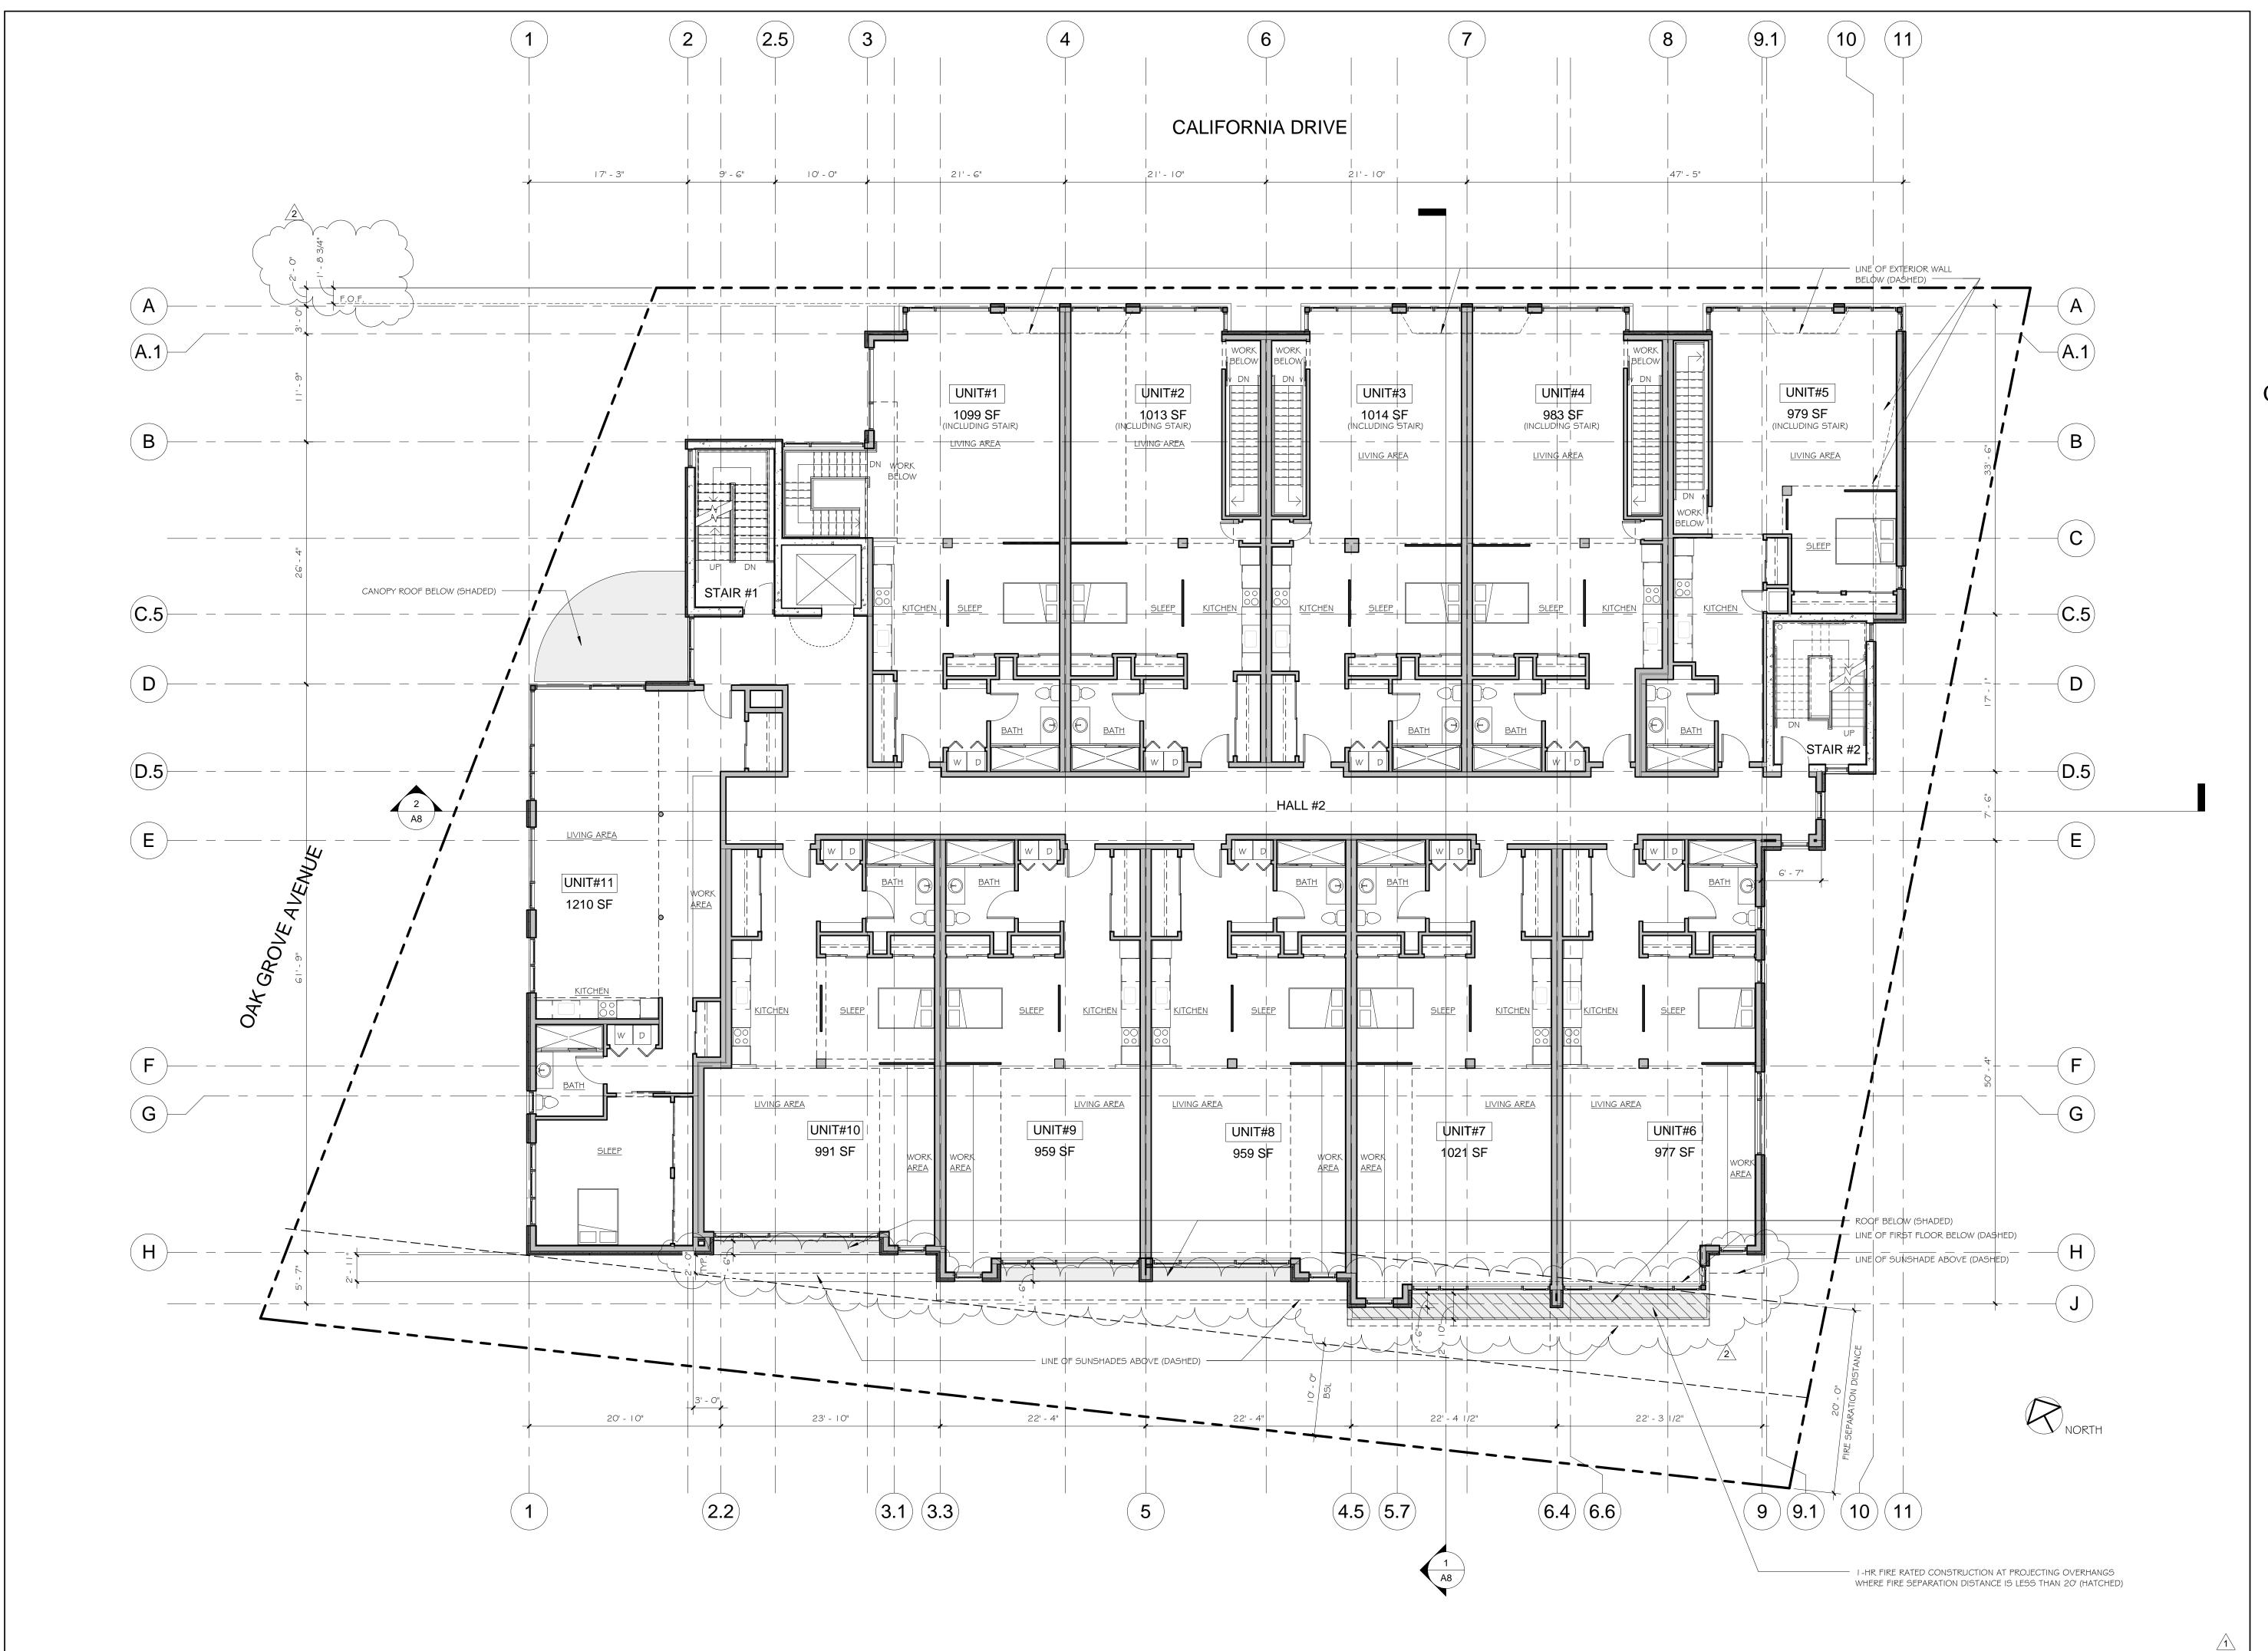



## California Drive Live-Work 619-625 California Dr. Burlingame, CA

APN#: 029-131-140 APN#: 029-131-150 APN#: 029-131-160

Owner: Ed Duffy / Renovattio Construction 415.533.4953

Architect: EASA Architecture

650.343.3452

Surveyor: FredrickT Seher & Associates, Inc. 415.921.7690

Romig Engineers 650.591.5224 Civil Engineer:


650.726.7100

Geotechnical Engineer:

MacLeod & Associates, Inc. 650.593.8580

Landscape Architect:

Kikuchi + Kankel Design Group

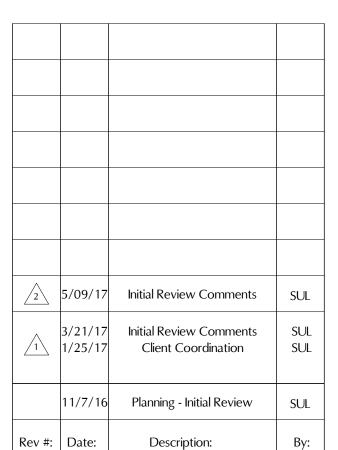


PRELIMINARY

\* NOT FOR CONSTRUCTION

SHEET TITLE

SECOND FLOOR PLAN

<sub>ЈОВ#</sub> 15666	1/8" = 1'-0"
11/07/16	SHEET
DRAWN SUL	
CHECKED EAS	H2

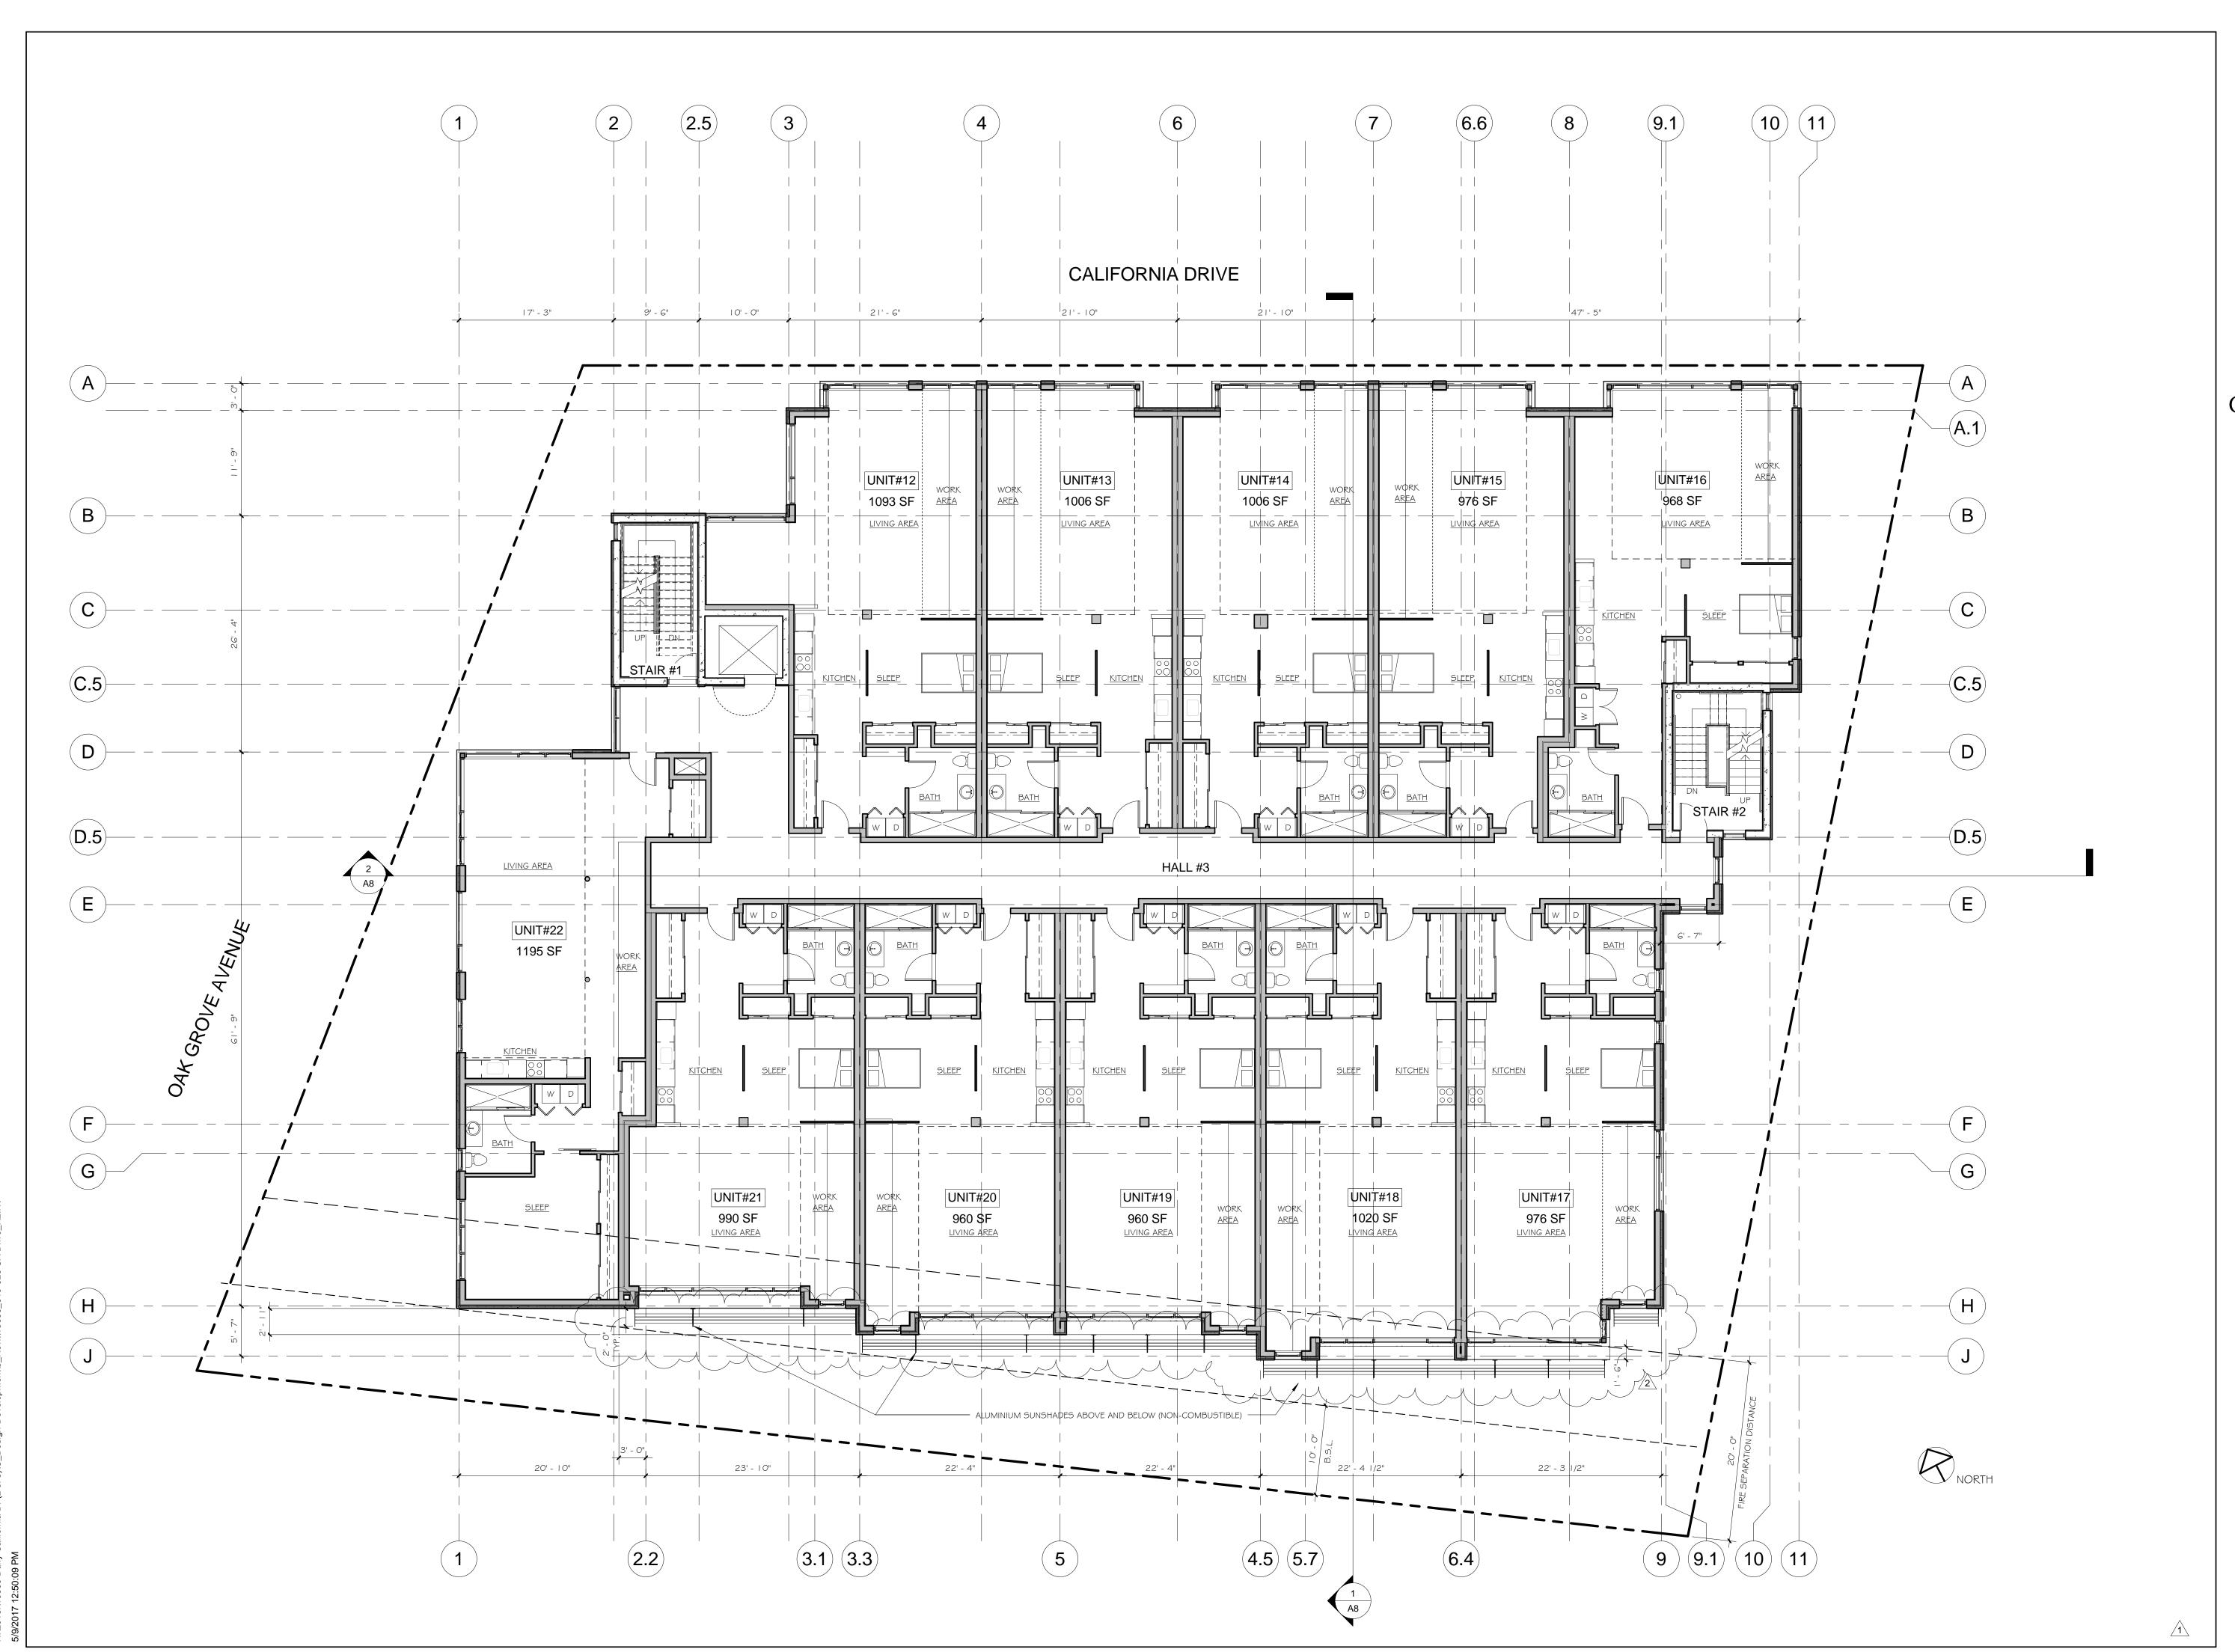



## California Drive Live-Work 619-625 California Dr. Burlingame, CA

APN#: 029-131-140 APN#: 029-131-150 APN#: 029-131-160

Owner: Ed Duffy / Renovattio Construction 415.533.4953

Architect: EASA Architecture

EASA Architectu 650.343.3452


Surveyor: FredrickT Seher & Associates, Inc. 415.921.7690

Romig Engineers
650.591.5224

Geotechnical Engineer:

Civil Engineer: MacLeod & Associates, Inc. 650.593.8580

Landscape Architect: Kikuchi + Kankel Design Group 650.726.7100

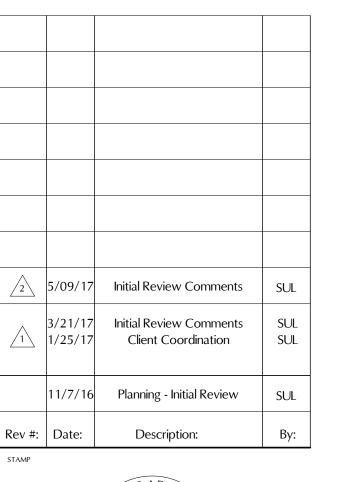


PRELIMINARY

\* NOT FOR CONSTRUCTION

THIRD FLOOR PLAN

JOB# 15666	SCALE 1/8" = 1'-0"
11/07/16	SHEET
DRAWN SUL	Λ 2
CHECKED EAS	<b>A</b> 3
REVIEWED	

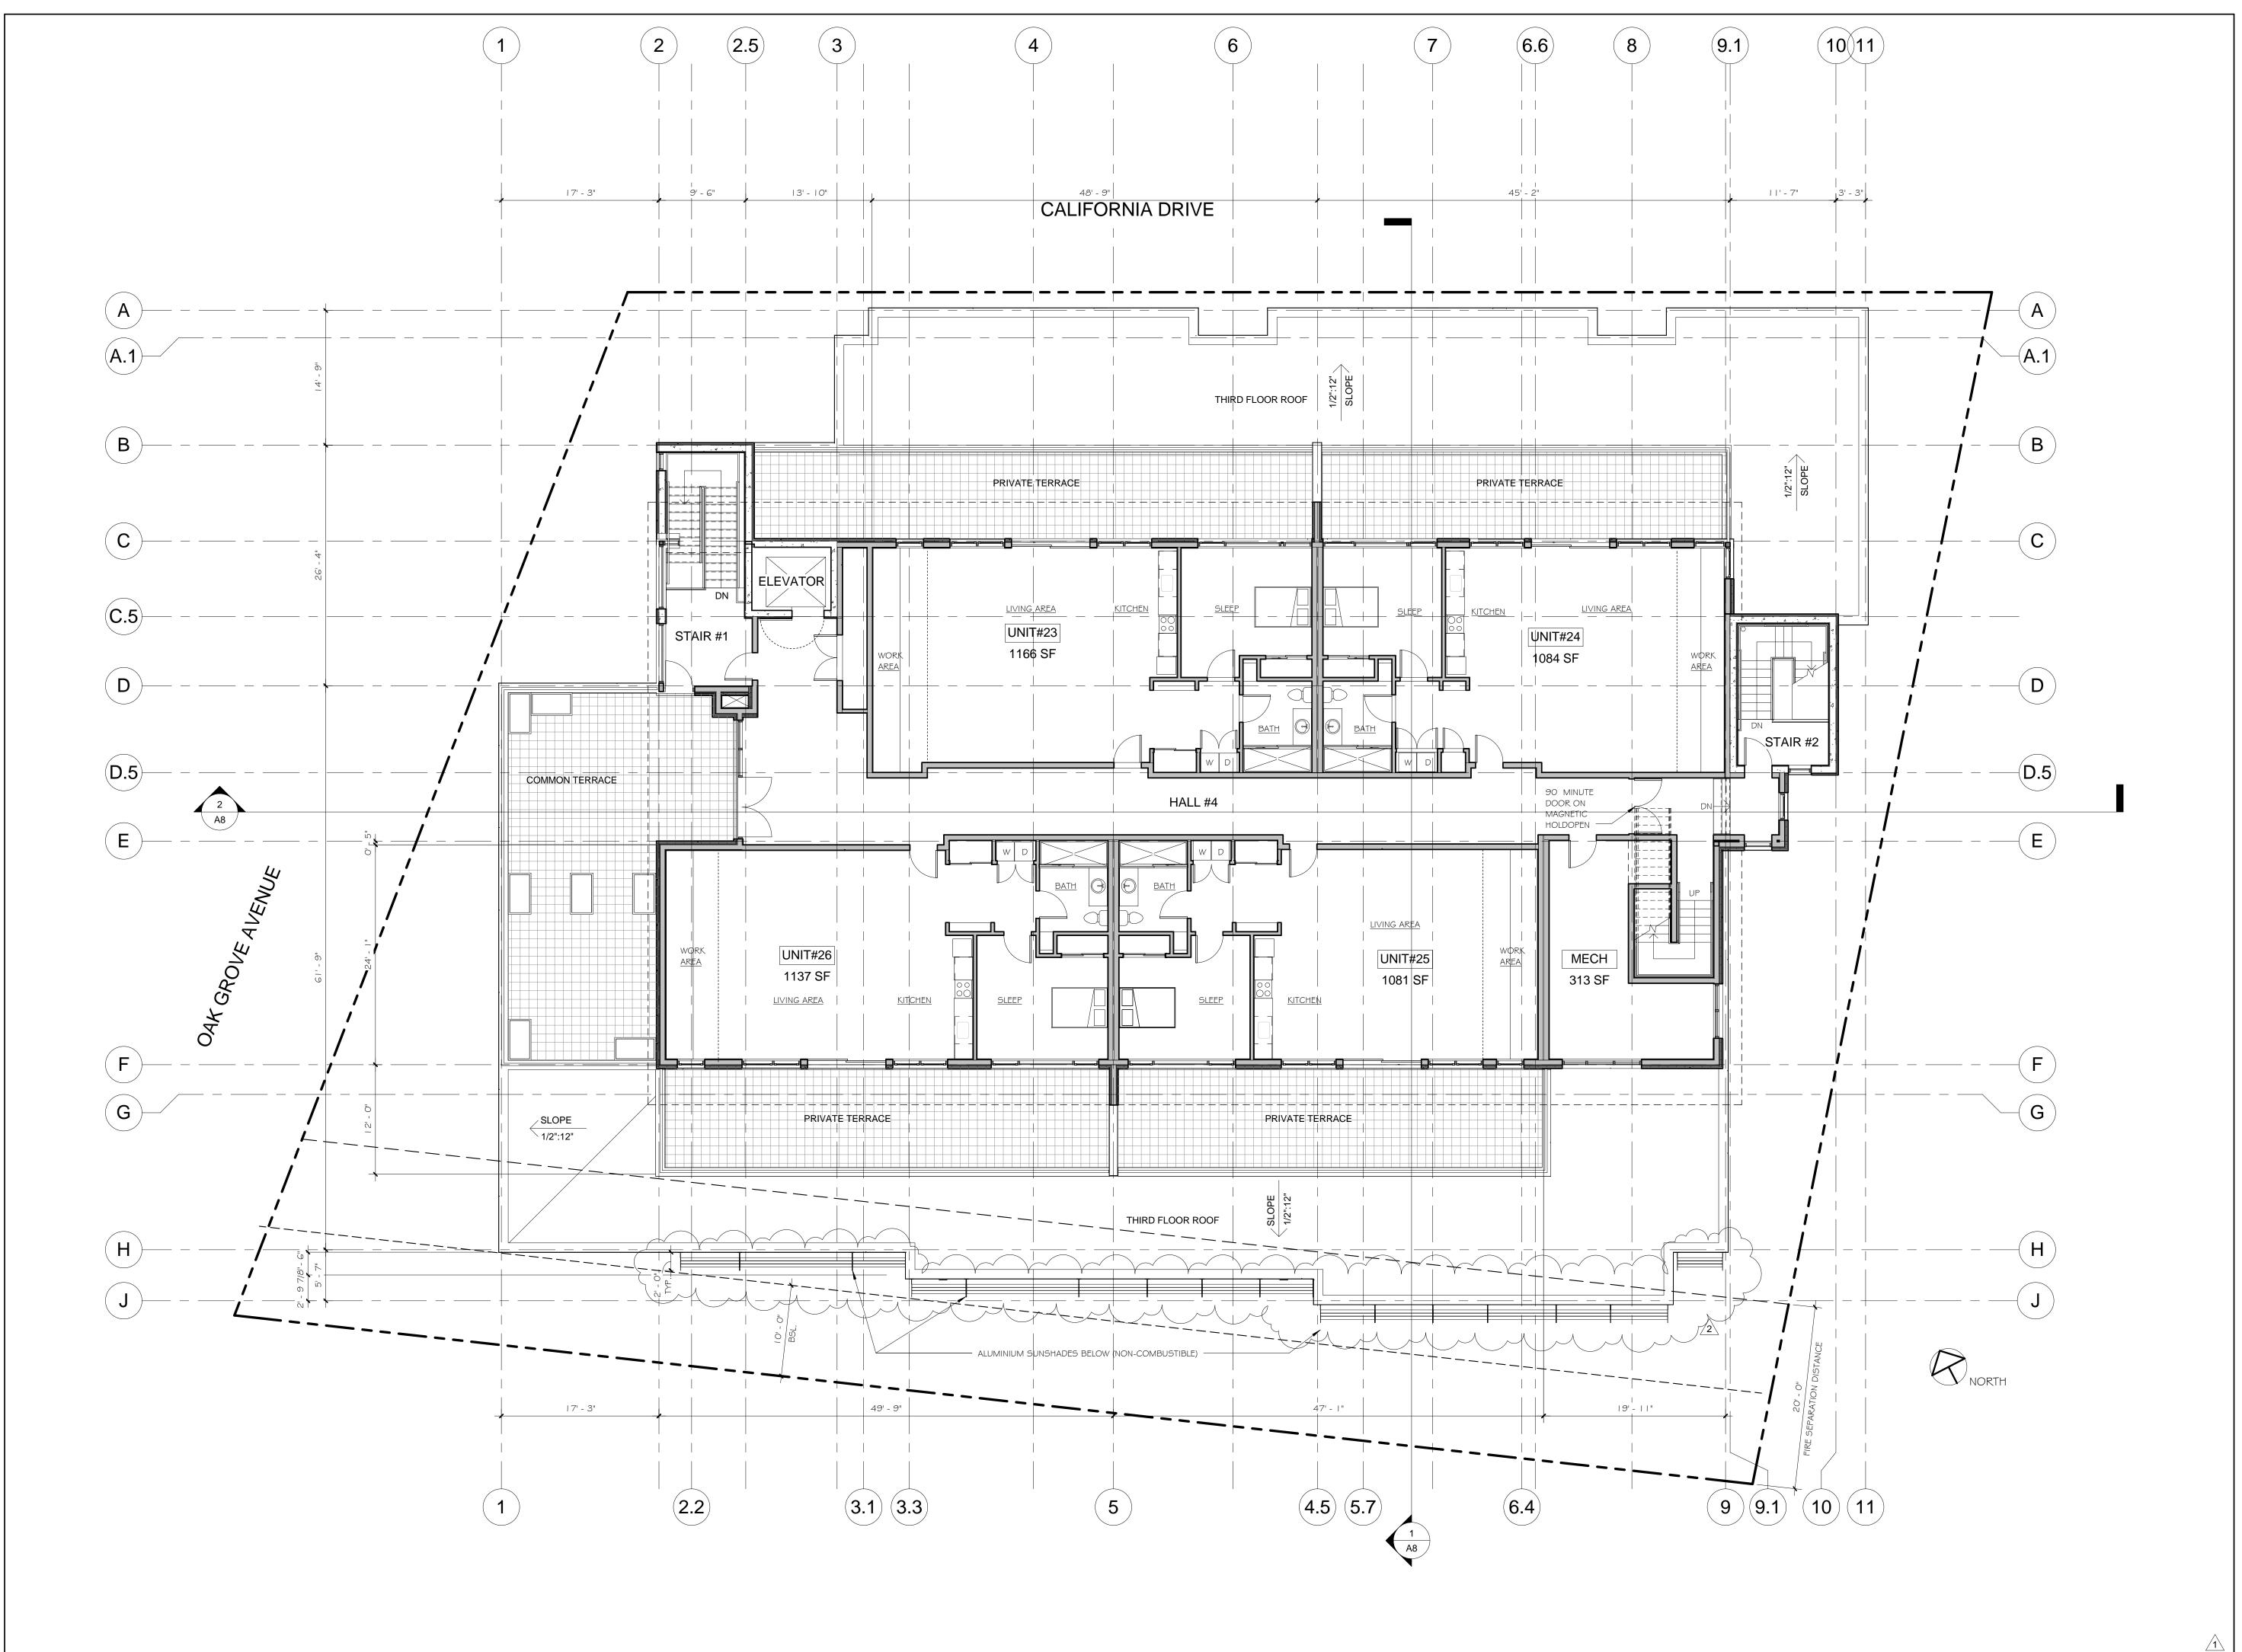



## California Drive Live-Work 619-625 California Dr. Burlingame, CA

APN#: 029-131-140 APN#: 029-131-150 APN#: 029-131-160

Owner: Ed Duffy / Renovattio Construction 415.533.4953

Architect: EASA Architecture 650.343.3452

650.343.3452


Surveyor: FredrickT Seher & Associates, Inc. 415.921.7690

Romig Engineers 650.591.5224 Civil Engineer:

Geotechnical Engineer:

Civil Engineer: MacLeod & Associates, Inc. 650.593.8580

Landscape Architect: Kikuchi + Kankel Design Group 650.726.7100

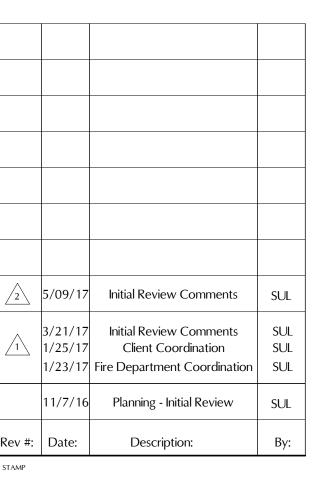


PRELIMINARY

\* NOT FOR CONSTRUCTION

SHEET TIT

FOURTH FLOOR / LOW ROOF PLAN

SCALE 1/8" = 1'-0"
SHEET
<b>A4</b>

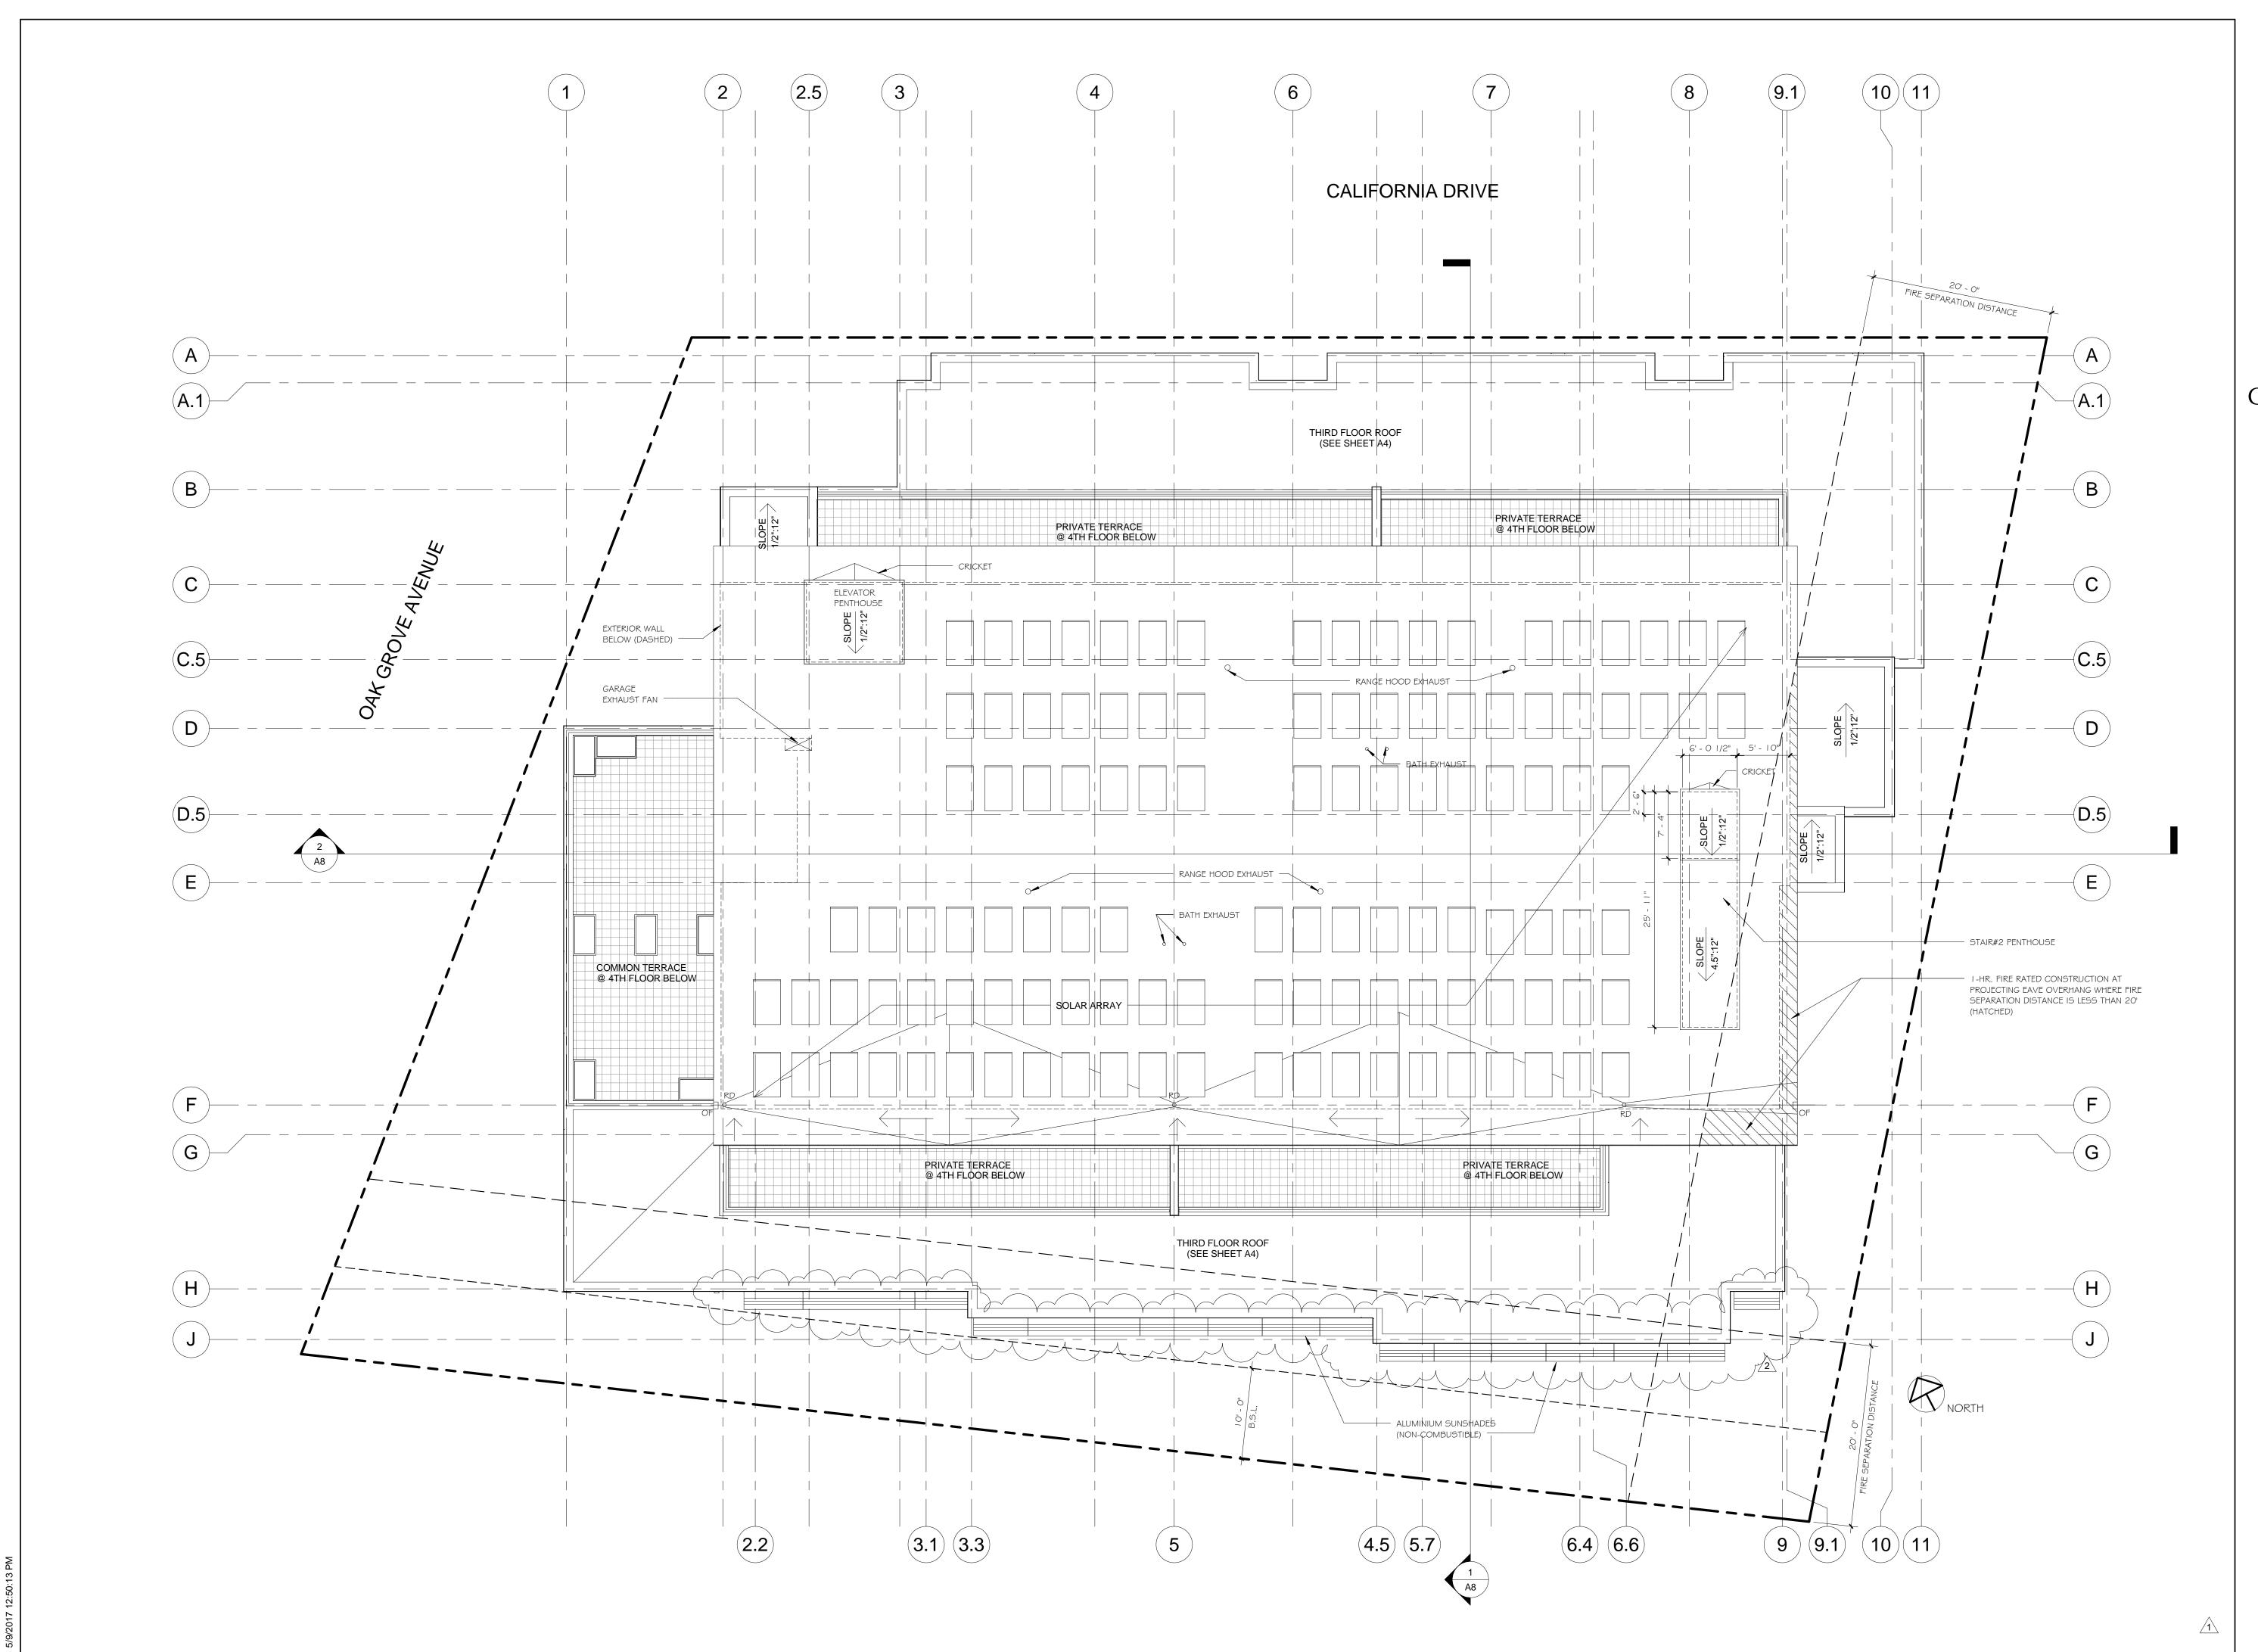

Ellis A. Schoichet AIA



Peninsula Building 307 South "B" Street #12 San Mateo CA 94401 650.343.3452

## California Drive Live-Work 619-625 California Dr. Burlingame, CA

APN#: 029-131-140 APN#: 029-131-150 APN#: 029-131-160

Owner: Ed Duffy / Renovattio Construction 415.533.4953

Architect: EASA Architecture


650.343.3452

Surveyor: FredrickT Seher & Associates, Inc. 415.921.7690

Geotechnical Engineer: Romig Engineers 650.591.5224

Civil Engineer: MacLeod & Associates, Inc. 650.593.8580

Landscape Architect: Kikuchi + Kankel Design Group 650.726.7100

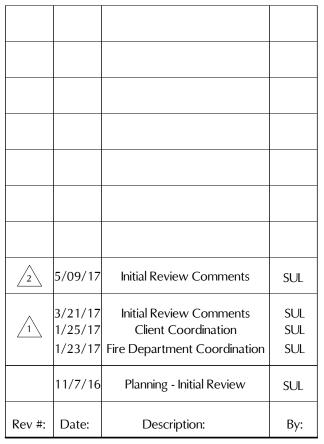

PRELIMINARY

\* NOT FOR CONSTRUCTION

SHEET TITLE

**ROOF PLAN** 

JOB#	15666	SCALE	1/8" = 1'-0"
DATE	11/07/16	SHEET	
DRAWN	SUL		٨ ٢
CHECKED	EAS		A <sub>5</sub>
REVIEWED			
		OF	SHEETS



Ellis A. Schoichet AIA



Peninsula Building 307 South "B" Street #12 San Mateo CA 94401 650.343.3452

## California Drive Live-Work 619-625 California Dr. Burlingame, CA

APN#: 029-131-140 APN#: 029-131-150 APN#: 029-131-160

Owner: Ed Duffy / Renovattio Construction 415.533.4953

Architect: EASA Architecture 650.343.3452


650.343.345*2* Surveyor:

FredrickT Seher & Associates, Inc. 415.921.7690

Geotechnical Engineer: Romig Engineers 650.591.5224

Civil Engineer: MacLeod & Associates, Inc. 650.593.8580

Landscape Architect: Kikuchi + Kankel Design Group 650.726.7100

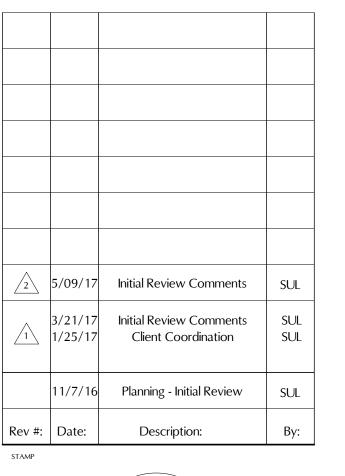

PRELIMINARY

\* NOT FOR GONSTRUCTION

SHEET TITLE

#### FRONT & REAR ELEVATIONS

<sub>ЈОВ#</sub> 15666	AS NOTED
DATE 11/07/16	SHEET
DRAWN SUL	A (
CHECKED EAS	A6
REVIEWED	
	OF SHEETS





## California Drive Live-Work 619-625 California Dr. Burlingame, CA

APN#: 029-131-140 APN#: 029-131-150 APN#: 029-131-160

Owner: Ed Duffy / Renovattio Construction 415.533.4953

Architect: EASA Architecture

650.343.3452 Surveyor:

FredrickT Seher & Associates, Inc. 415.921.7690

Geotechnical Engineer: Romig Engineers 650.591.5224

Civil Engineer: MacLeod & Associates, Inc. 650.593.8580

Landscape Architect: Kikuchi + Kankel Design Group 650.726.7100

2	5/09/17	Initial Review Comments	SU
_1	3/21/17 1/25/17	Initial Review Comments Client Coordination	SI SI
	11/7/16	Planning - Initial Review	SU
Rev #:	Date:	Description:	В




<u>/1</u>

SIDE ELEVATIONS

15666	AS NOTED
11/07/16	SHEET
rawn SUL	<b>^</b> 7
HECKED EAS	$\mathcal{A}$
EVIEWED	
	OF SHEETS

2 South-East Elevation (left side)
1/8" = 1'-0"

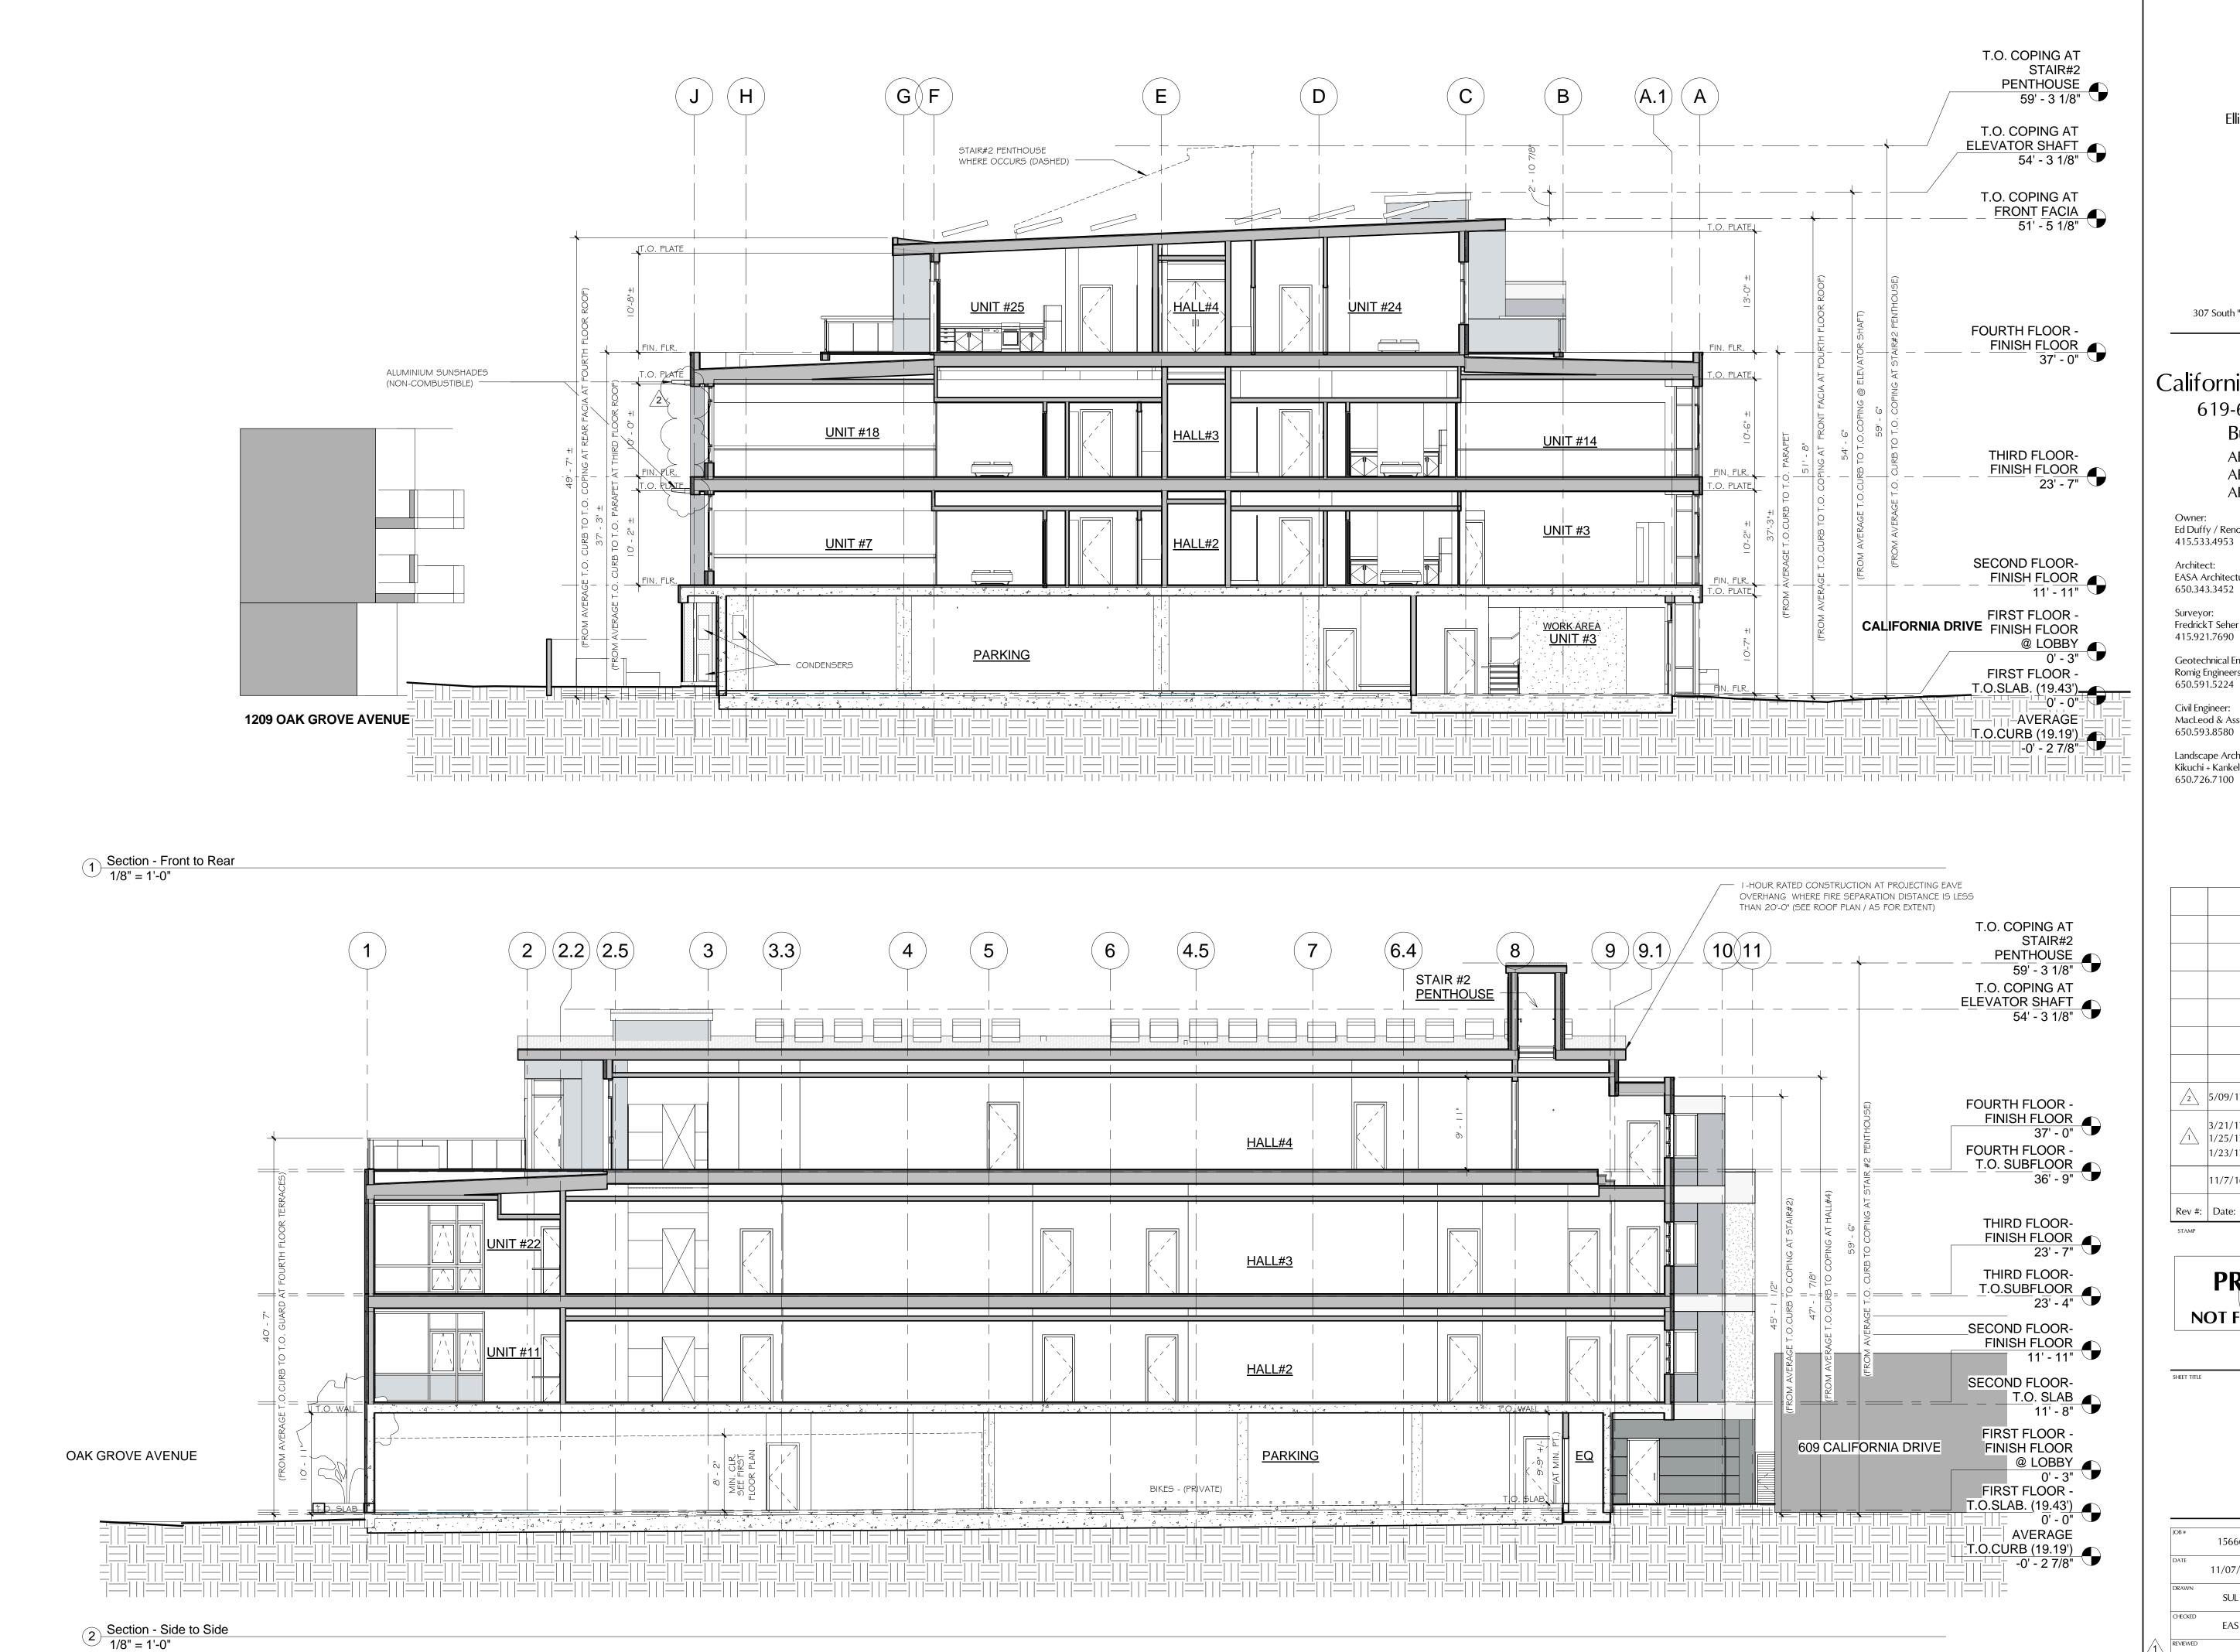



Peninsula Building 307 South "B" Street #12 San Mateo CA 94401

650.343.3452

#### California Drive Live-Work 619-625 California Dr. Burlingame, CA

APN#: 029-131-140 APN#: 029-131-150 APN#: 029-131-160

Ed Duffy / Renovattio Construction 415.533.4953

Architect: EASA Architecture


650.343.3452

Surveyor: FredrickT Seher & Associates, Inc. 415.921.7690

Geotechnical Engineer: Romig Engineers

Civil Engineer: MacLeod & Associates, Inc. 650.593.8580


Landscape Architect: Kikuchi + Kankel Design Group 650.726.7100

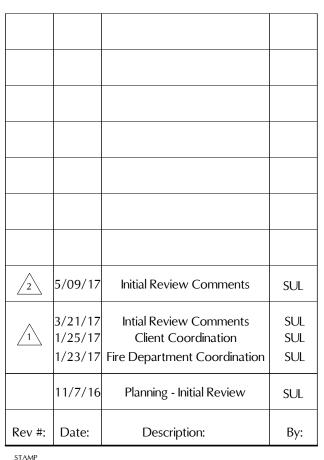



**SECTIONS** 

15666	SCALE AS NOTED
11/07/16	SHEET
SUL	ΛΟ
ECKED	Ao
TEWED	
	OF SHEETS

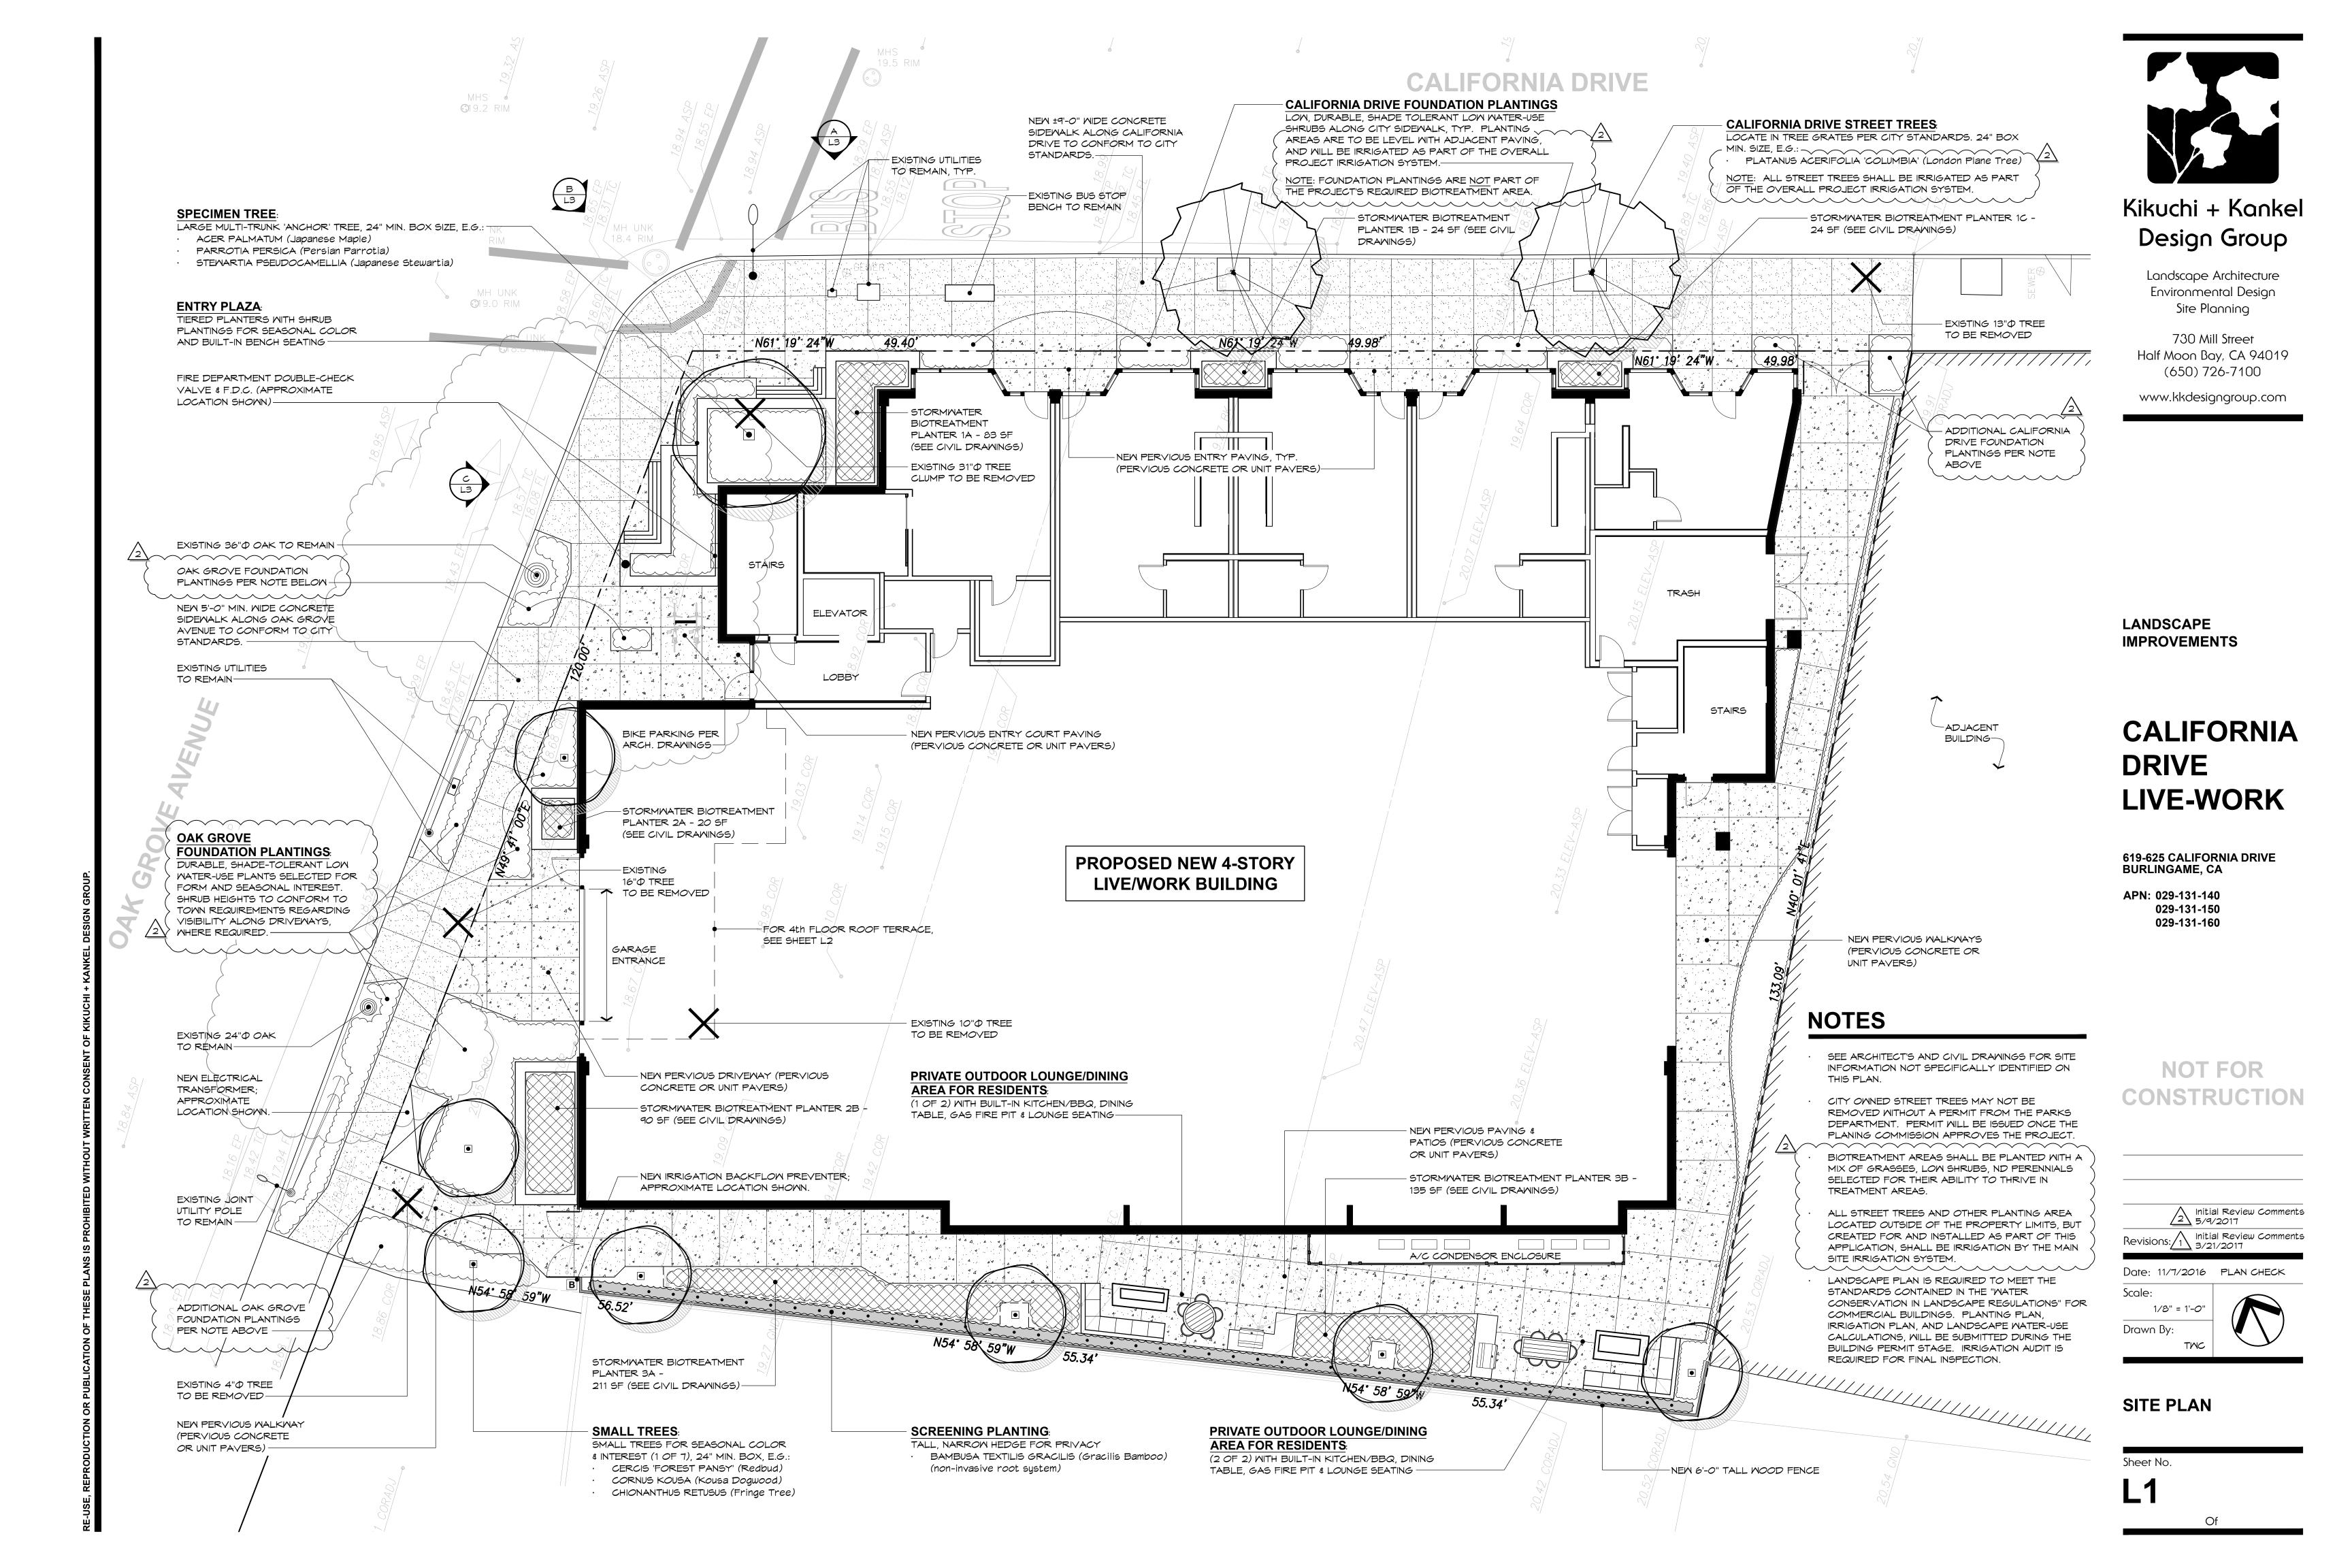



# Kikuchi + Kankel Design Group

Landscape Architecture Environmental Design Site Planning

730 Mill Street Half Moon Bay, CA 94019 (650) 726-7100

www.kkdesigngroup.com

LANDSCAPE IMPROVEMENTS

# CALIFORNIA DRIVE LIVE-WORK

619-625 CALIFORNIA DRIVE BURLINGAME, CA

029-131-160

APN: 029-131-140 029-131-150

NOT FOR CONSTRUCTION

Revisions: 1 Initial Review Comments 3/21/2017

Date: 11/7/2016 PLAN CHECK


Scale: 1/4" = 1'-Drawn By:



4TH FLOOR ROOF TERRACE PLAN

Sheet No.

Of

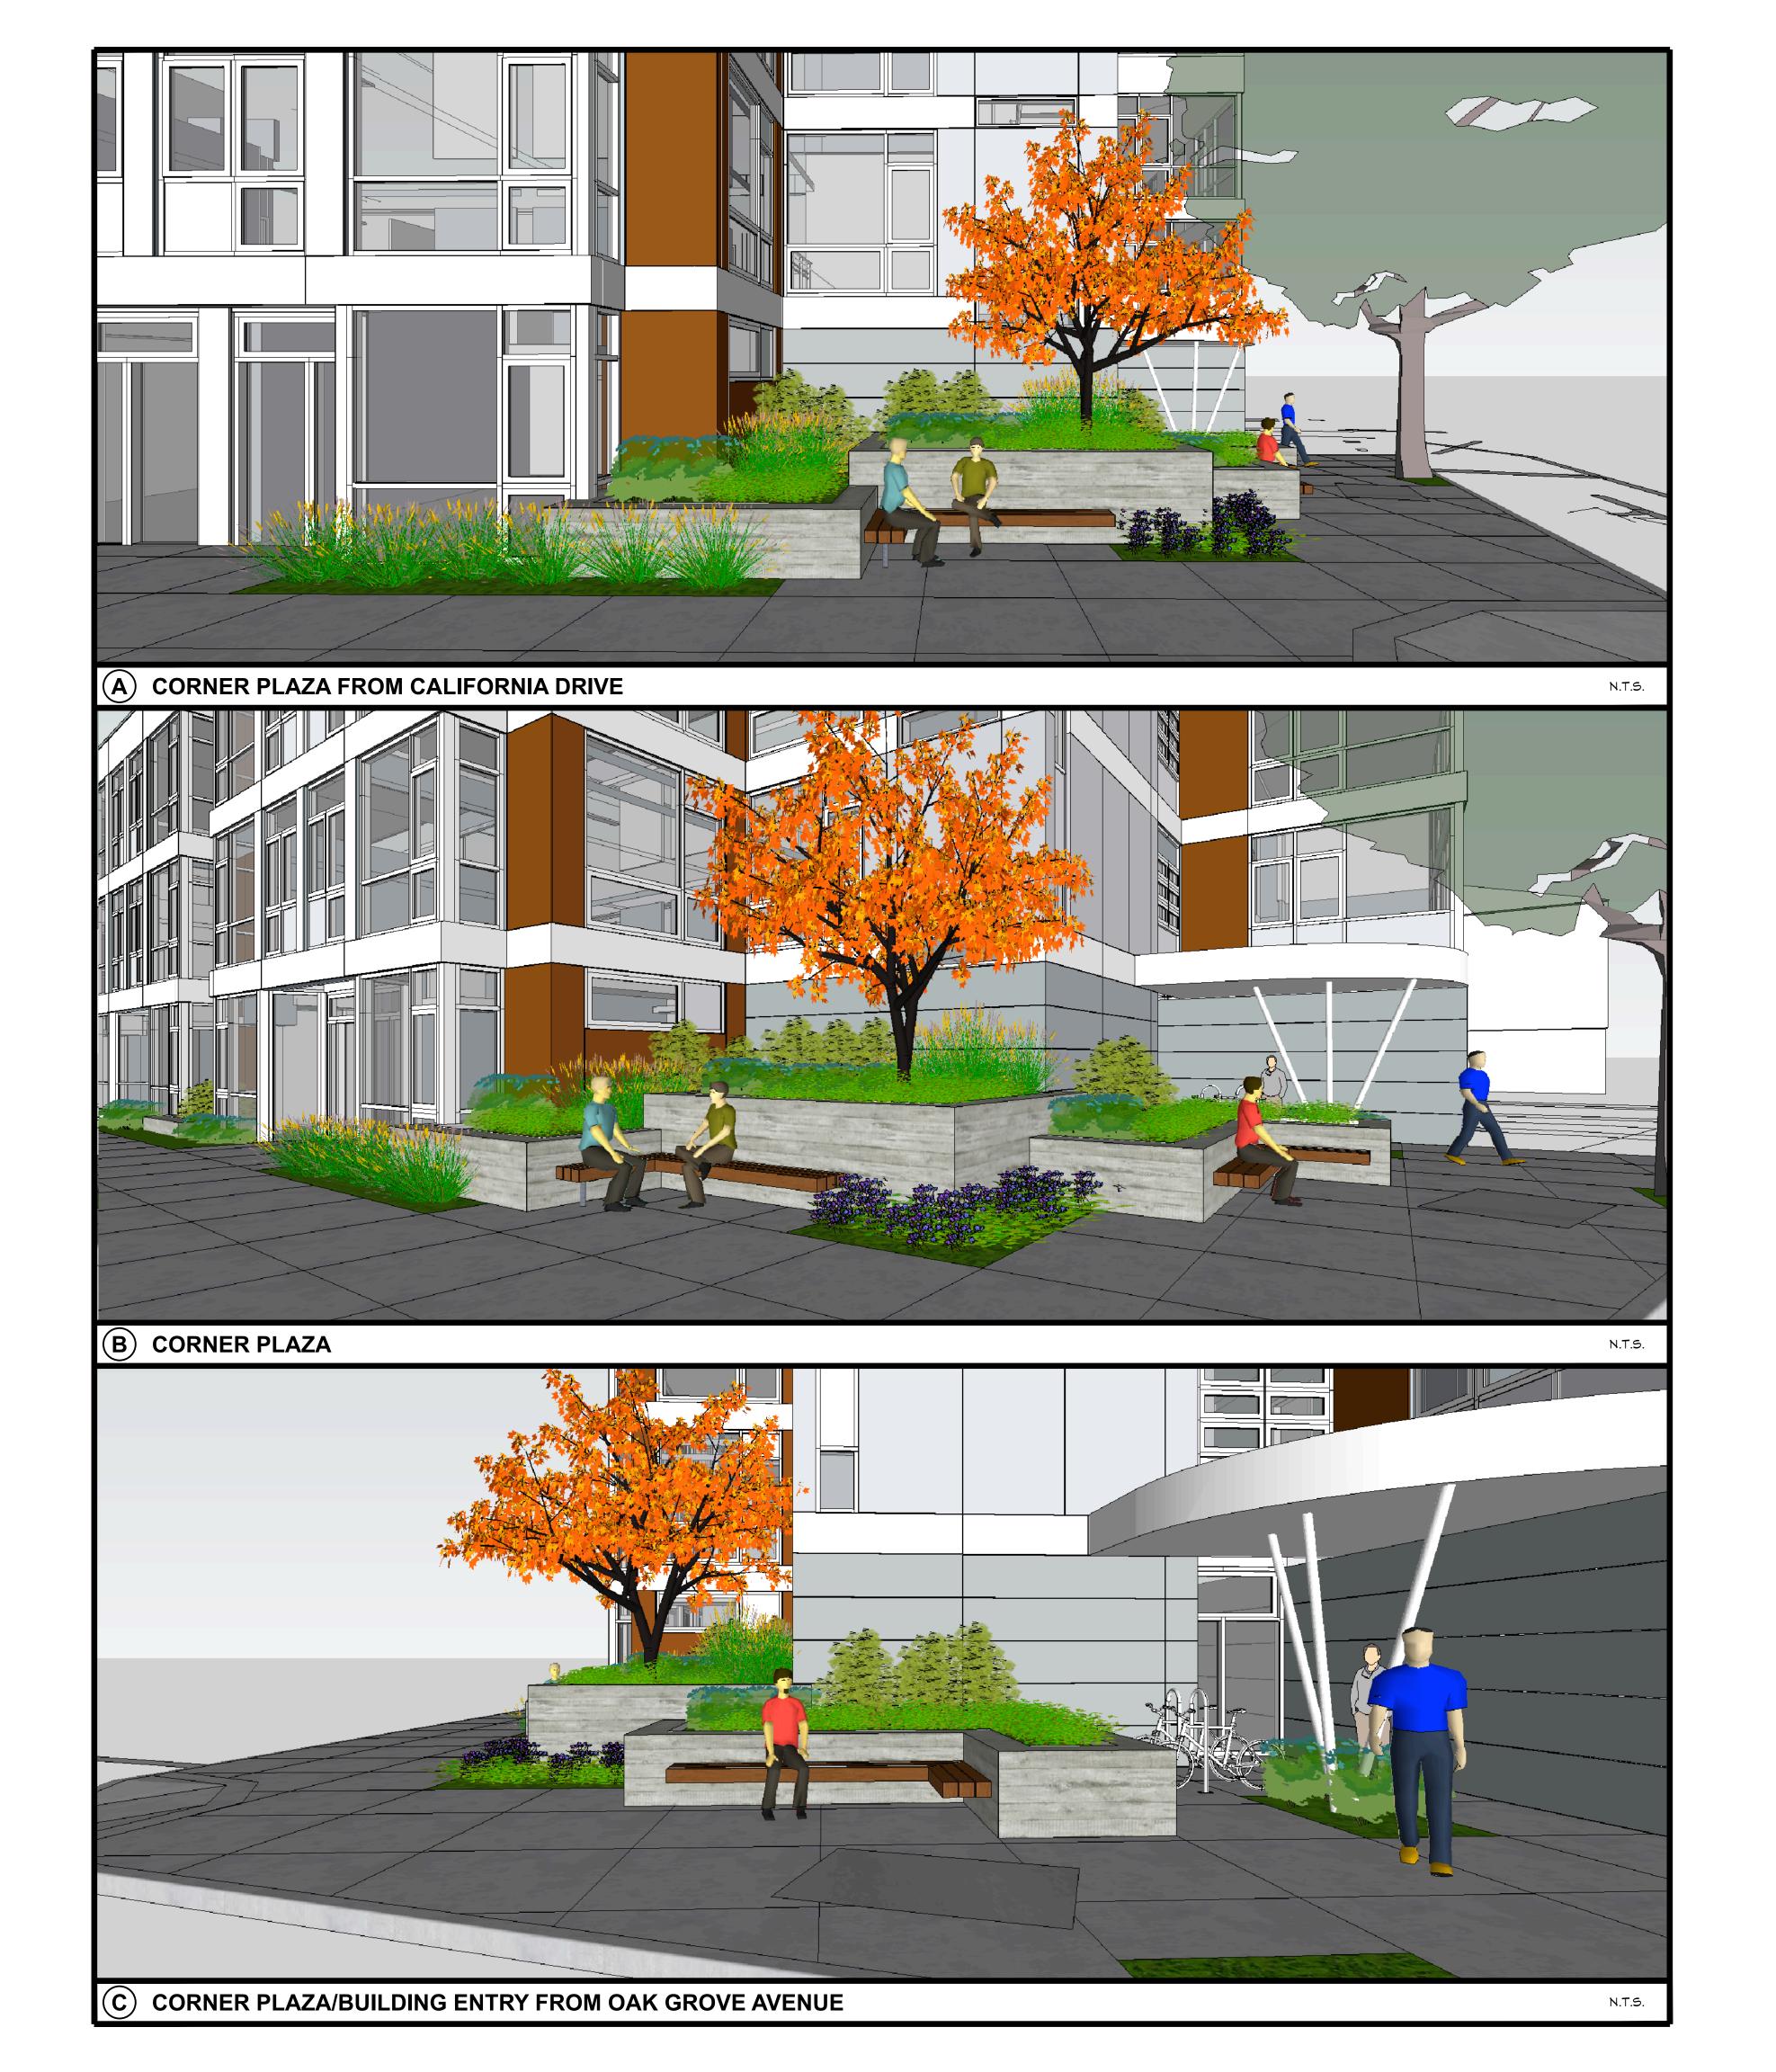



# Kikuchi + Kankel Design Group

Landscape Architecture Environmental Design Site Planning

730 Mill Street Half Moon Bay, CA 94019 (650) 726-7100

www.kkdesigngroup.com

LANDSCAPE IMPROVEMENTS

# CALIFORNIA DRIVE LIVE-WORK

619-625 CALIFORNIA DRIVE BURLINGAME, CA

APN: 029-131-140 029-131-150 029-131-160

# NOT FOR CONSTRUCTION

Revisions: Initial Review Comments 3/21/2017

Date: 11/7/2016 PLAN CHECK
Scale:

AS NOTED
Drawn By:

CORNER PLAZA
CONCEPT IMAGES

Sheet No.

Of

