

SCALE: 3/16"=1'-0"

3- LEFT(NORTH) ELEVATION: EXISTING SCALE: 3/16"=1'-0"

GENERAL NOTES I. FINISH GRADE SHALL SLOPE AWAY FROM FOUNDATIONS AT A 2% MIN. SLOPE FOR A MIN. OF 5'0" AT SOIL AND A MIN. OF 3' 0" AT CONCRETE.

II. TOP OF FIREPLACE CHIMNEYS TO EXTEND 2 FEET MIN. ABOVE ANY ROOFING MATERIAL WITHIN 10 FEET (MEASURED HORIZONTALLY) OF CHIMNEY AND 3 FEET MIN. ABOVE ANY ADJACENT ROOFING MATERIAL. V. PROVIDE WEATHER RESISTIVE BARRIERS AND, WHEN APPLIED OVER WOOD BASE SHEATHING, PROVIDE 2 LAYERS OF GRADE 'D' PAPER

VI. ALL WOOD MATERIAL EXPOSED TO WEATHER SHALLBE PRESSURE TREATED OR RED WOOD VII. ALL CONNECTORS USED IN CONJUNTION WITH PRESSURE TREATED LUMBER MUST BE HOT-DIPPED ZINC GALVANIZED AND A MIN. GALVANIZATION LEVEL OF G185.

WORK NOTES

1 EXISTING DOOR AND WINDOW TO BE REMOVED

(E) WOOD FENCE TO REMAIN

(3)—(E) COMPOSITE ROOF SHINGLES ROOF TO BE MODIFY

(N) STUCCO WALL EXTERIOR FINISH , MATCH (E)

(5)—(N) ALUM CLAD WOOD CASEMENT WINDOW

6 (N) COMPOSITE ROOF SHINGLES, MATERIAL AND STYLE MATCH (E)

7 NEW RECESSED ENTRY WITH SOLID WOOD DOOR & SIDELITE

(E) STUCCO WALL EXTERIOR FINISH TO REMAIN,

9 METAL GUTTER, TYP.

- 10 NEW WROUGHT IRON MTL VERTICAL RAILING WITH CAP, TYP.
- 11 NEW WOOD GARAGE DOOR
- (12)— HARD WOOD FINISH COLUMN, PAINTE TO WHITE, TYP.
- (13)— EXISTING STAIR AND LANDING TO BE REMOVED
- EXISTING RETAINING WALL TO REMAIN, NEW RETAINING WALL SHALL MATCH (E)
- NEW SOLID HORIZONTAL WOOD SIDING BD GURADRAIL @ ROOF DECK, PAINT TO MATCH STUCCO
- (16)— (N) 6'x4' ALUM CLAD WOOD CASEMENT EGRESS/RESCUE WINDOW, PROVIDE WINDOWS MEET EGRESS REQUIREMENTS AT LEAST ONE ESCAPE ROUTE FROM SLEEPING ROOM, 20" CLEAR WIDTH, 24" CLEAR HEIGHT, AND MIN. 5.7 SQ. FT. CLEAR OPENING. SILL HEIGHT NOT MORE THAN 44" ABOVE THE FLOOR,
- (17)— NEW WOOD DOOR ROOMS DOWN

AND NOT LESS THAN 24" AFF

(20)—(E) WOOD DOOR AND GARAGE DOOR TO BE REMOVED

(21)—(E) METAL RAILING AND STEPS TO BE REMOVED; (E) LANDING TO REMAIN

(22)—(E) METAL WINDOW TO BE REMOVED, TYP.


(23)—(E) WOOD RAILING TO BE REMOVED, TYP.


(24)—(N) ALUM CLAD WOOD FRENCH DOOR

(25)—(N) FLAT GLASS SKYLIGHT, TYP.

(26)—(N) RED BRICK FINISH STEPS

4- LEFT(NORTH) ELEVATION: PROPOSED

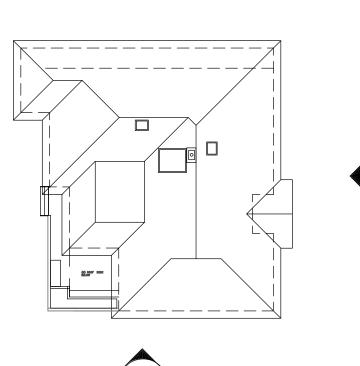

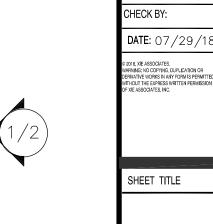

SHEET TITLE

DRAWN BY: DM

BUILDING **ELEVATIONS**

2721


MARTINEZ DR.

BURLINGAME

CALIFORNIA


KEY PLAN

A3.0

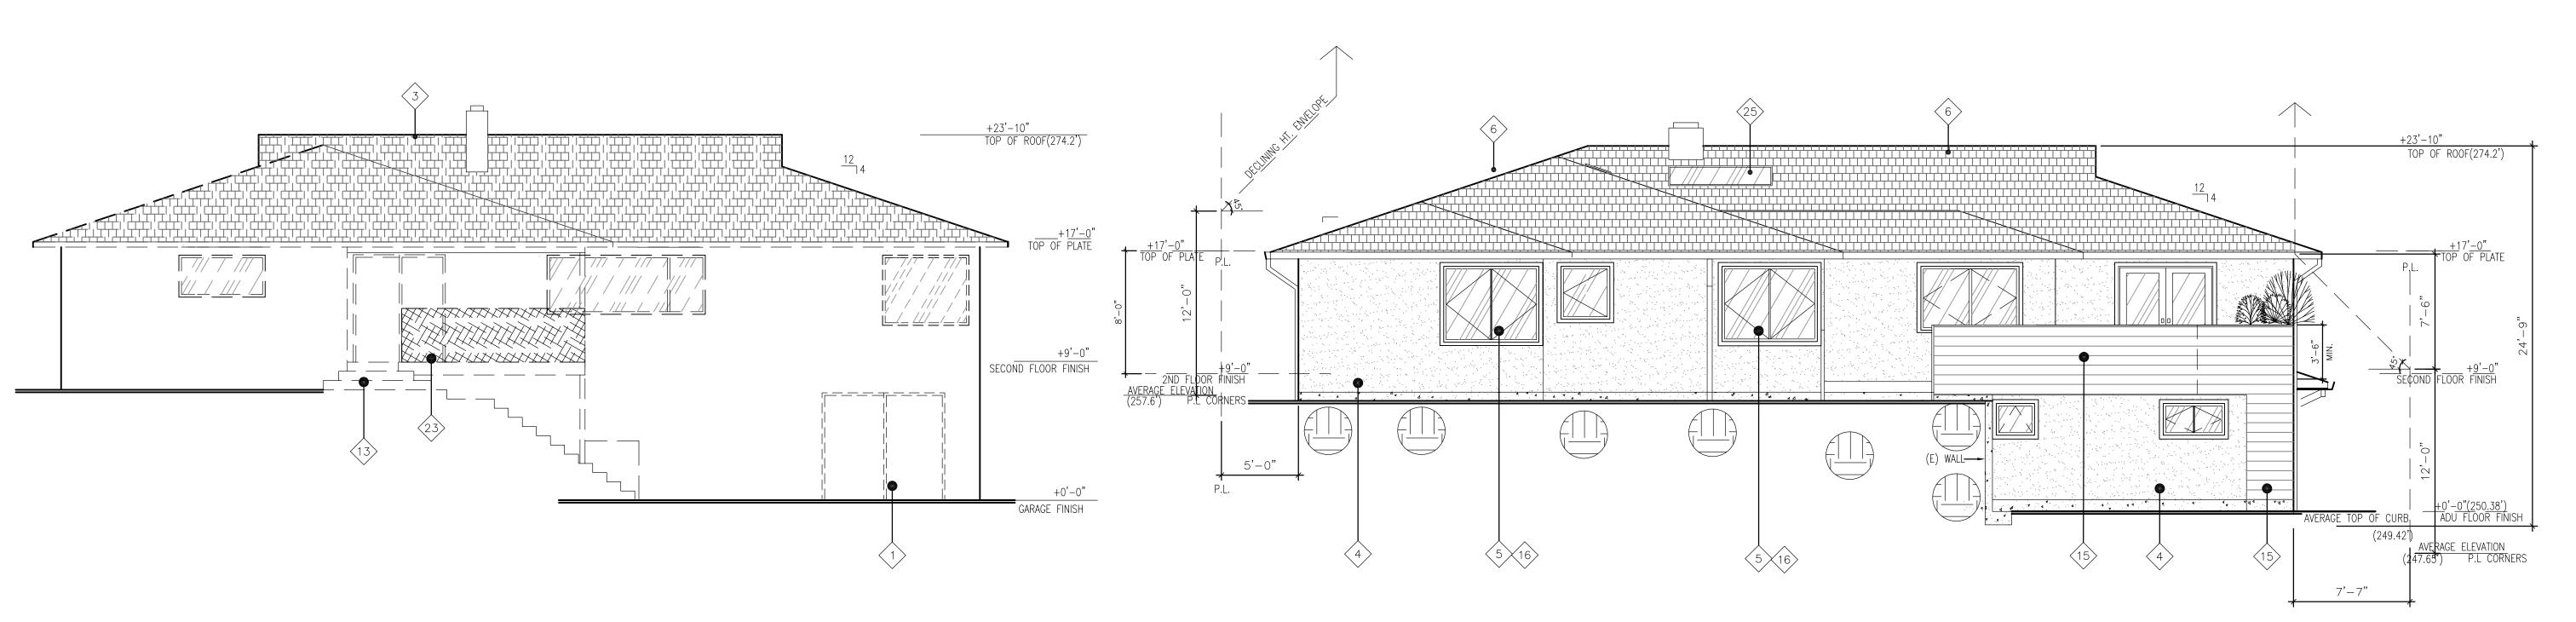

1-EAST (REAR) ELEVATION: EXISTING

SCALE: 3/16"=1'-0"

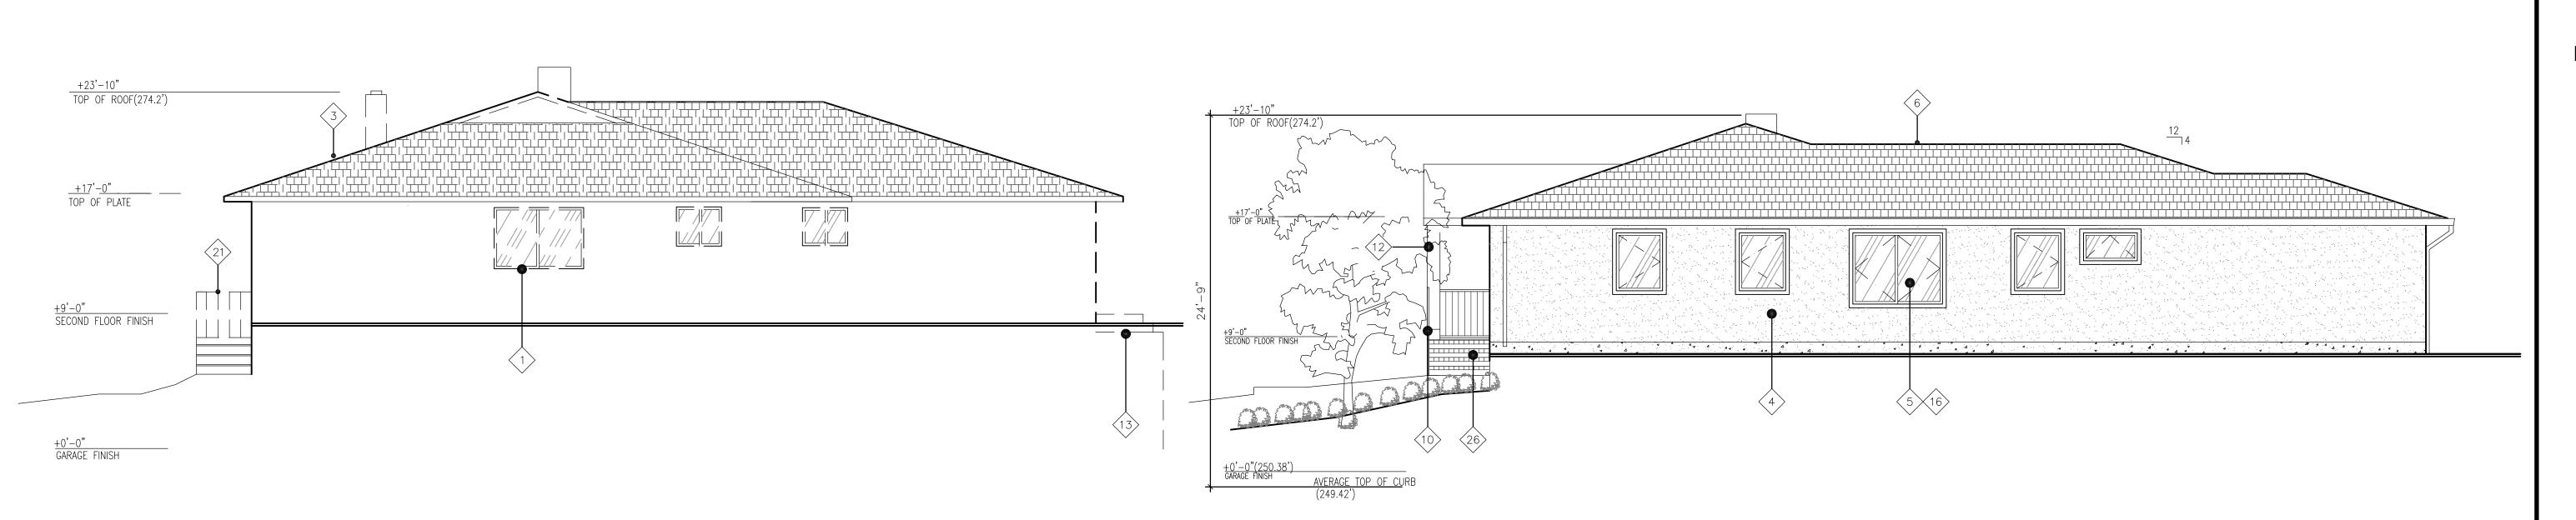

3-SOUTH(RIGHT) ELEVATION: EXISTING

SCALE: 3/16"=1'-0"

GENERAL NOTES

I. FINISH GRADE SHALL SLOPE AWAY FROM FOUNDATIONS AT A 2% MIN. SLOPE FOR A MIN. OF 5' 0" AT SOIL AND A MIN. OF 3' O" AT CONCRETE. II. TOP OF FIREPLACE CHIMNEYS TO EXTEND 2 FEET MIN.

ABOVE ANY ROOFING MATERIAL WITHIN 10 FEET (MEASURED HORIZONTALLY) OF CHIMNEY AND 3 FEET MIN. ABOVE ANY ADJACENT ROOFING MATERIAL. V. PROVIDE WEATHER RESISTIVE BARRIERS AND, WHEN APPLIED OVER WOOD BASE SHEATHING, PROVIDE 2 LAYERS OF GRADE 'D' PAPER

VI. ALL WOOD MATERIAL EXPOSED TO WEATHER SHALLBE PRESSURE TREATED OR RED WOOD VII. ALL CONNECTORS USED IN CONJUNTION WITH PRESSURE TREATED LUMBER MUST BE HOT-DIPPED ZINC GALVANIZED AND A MIN. GALVANIZATION LEVEL OF G185.

WORK NOTES

1 EXISTING DOOR AND WINDOW TO BE REMOVED

(E) WOOD FENCE TO REMAIN

(3)—(E) COMPOSITE ROOF SHINGLES ROOF TO BE MODIFY

4 — (N) STUCCO WALL EXTERIOR FINISH, MATCH (E)

(5)—(N) ALUM CLAD WOOD CASEMENT WINDOW

6 (N) COMPOSITE ROOF SHINGLES, MATERIAL AND STYLE MATCH (E)

7 NEW RECESSED ENTRY WITH SOLID WOOD DOOR

(E) STUCCO WALL EXTERIOR FINISH TO REMAIN,

9 METAL GUTTER W/SCREENING, TYP.

10 NEW WROUGHT IRON MTL VERTICAL RAILING WITH CAP, TYP.

11 NEW WOOD GARAGE DOOR

12 HARD WOOD FINISH COLUMN, PAINTE TO WHITE, TYP.

13 - EXISTING STAIR AND LANDING TO BE REMOVED

NEW SOLID HORIZONTAL WOOD SIDING BD GURADRAIL @ ROOF DECK AND WALL, PAINT TO MATCH STUCCO

(N) 6'x5' ALUM CLAD WOOD CASEMENT EGRESS/RESCUE WINDOW, PROVIDE WINDOWS MEET EGRESS REQUIREMENTS AT LEAST ONE ESCAPE ROUTE FROM SLEEPING ROOM, 20" CLEAR WIDTH, 24" CLEAR HEIGHT, AND MIN. 5.7 SQ. FT. CLEAR OPENING. SILL HEIGHT NOT MORE THAN 44" ABOVE THE FLOOR, AND NOT LESS THAN 24" AFF

4-SOUTH(RIGHT) ELEVATION: PROPOSED

SCALE: 3/16"=1'-0"

SCALE: 3/16"=1'-0"

(20)—(E) WOOD DOOR AND GARAGE TO BE REMOVED

2-EAST (REAR) ELEVATION: PROPOSED

(E) METAL RAILING AND STEPS TO BE REMOVED; (E) LANDING TO REMAIN


(E) METAL WINDOW TO BE REMOVED, TYP.

(E) WOOD RAILING TO BE REMOVED, TYP.

(24)—(N) ALUM CLAD WOOD FRENCH DOOR

(25)—(N) FLAT GLASS SKYLIGHT, TYP.

26 (N) RED BRICK FINISH STEPS

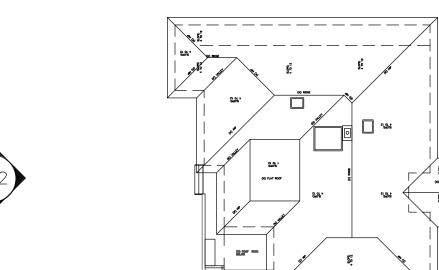

PROJECT:

RESIDENTIAL **REMODEL** & ADDITION

FOR

LIN FAMILY

XIE ASSOCIATES, INC. Architectural Design & Planning 1 CRESCENT WAY #5412 N FRANCISCO, CA 94134 el: (415) 652-3047 ax:(415) 656-0542 mail: bill@xiearchdesign.com


> 2721 MARTINEZ DR. **BURLINGAME CALIFORNIA**




SHEET TITLE

EXTERIOR ELEVATIONS

A3.1

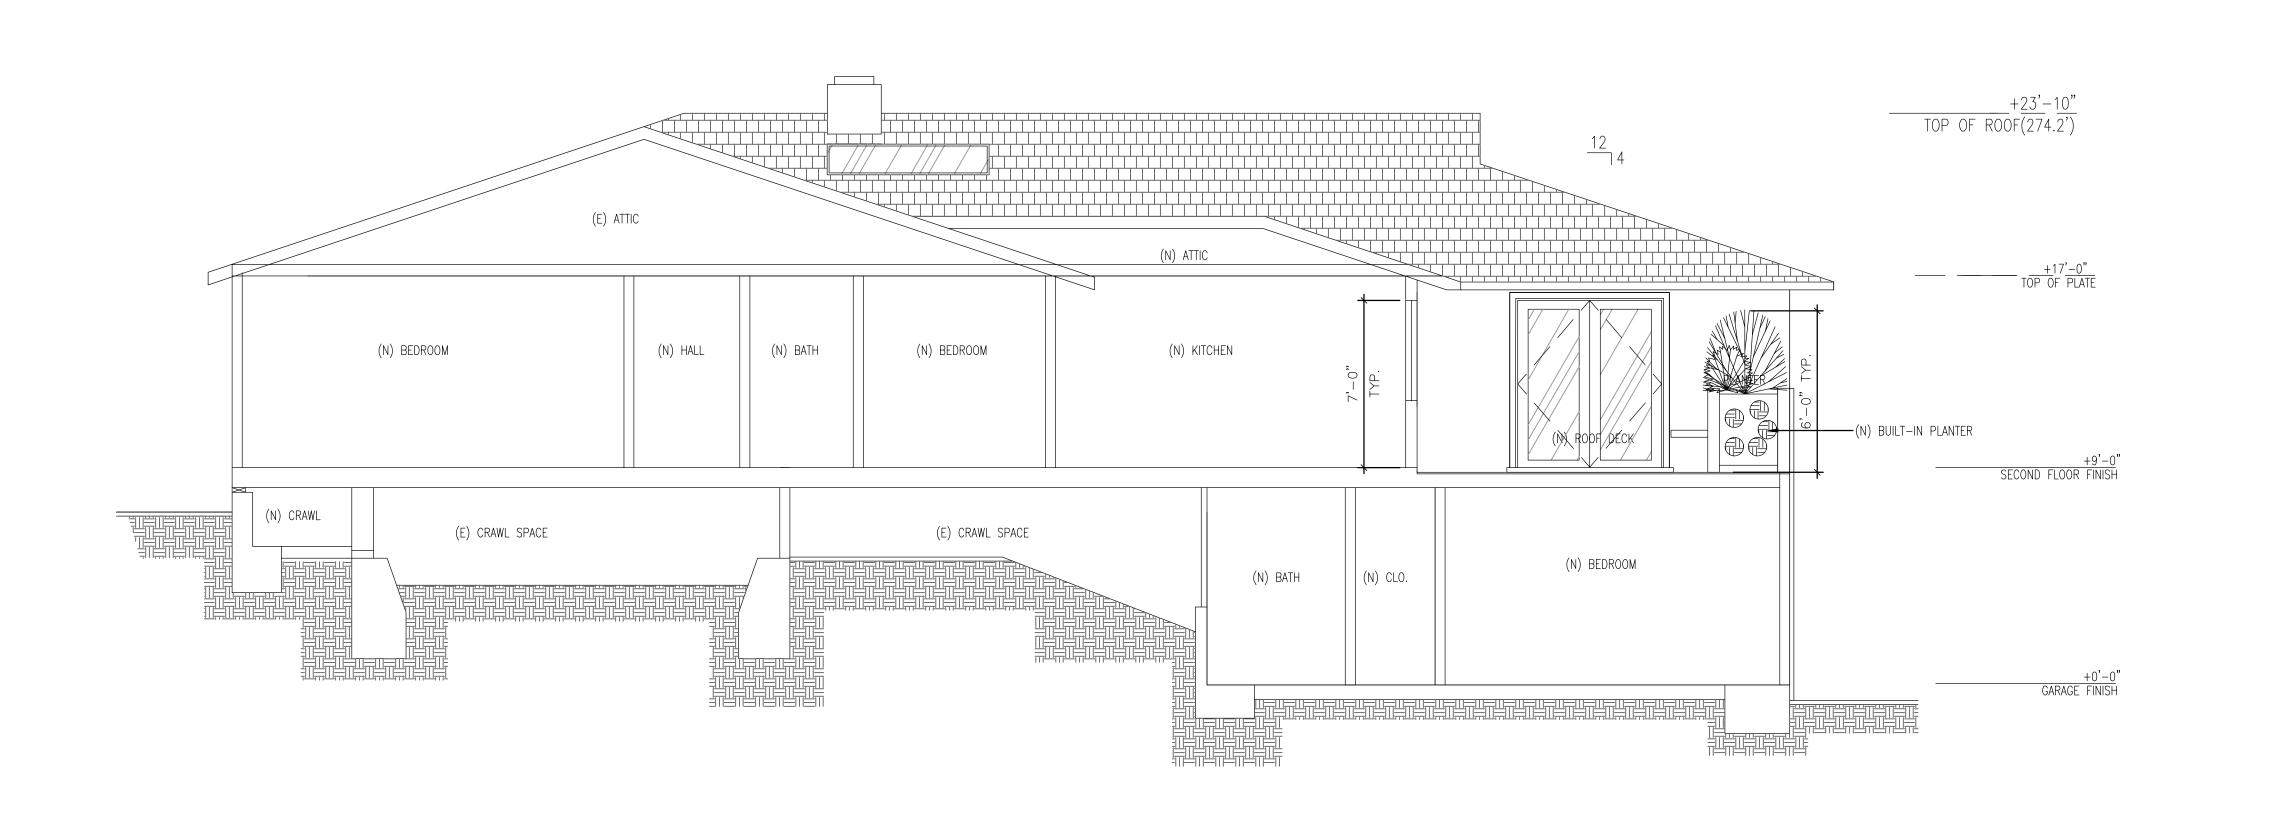

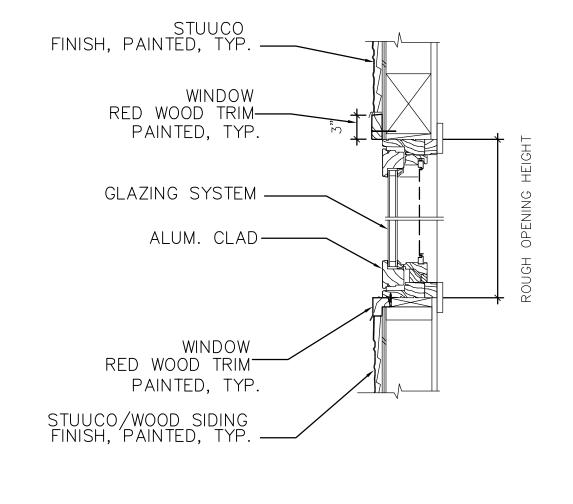

A1-WINDOW SECTION, TYP.

2721 MARTINEZ DR. BURLINGAME

CALIFORNIA

PROJECT:

RESIDENTIAL

REMODEL & ADDITION

FOR

LIN FAMILY


XIE ASSOCIATES, INC. Architectural Design & Planning

501 CRESCENT WAY #5412 SAN FRANCISCO, CA 94134

Email: bill@xiearchdesign.com

Tel: (415) 652-3047 Fax:(415) 656-0542

N.T.S

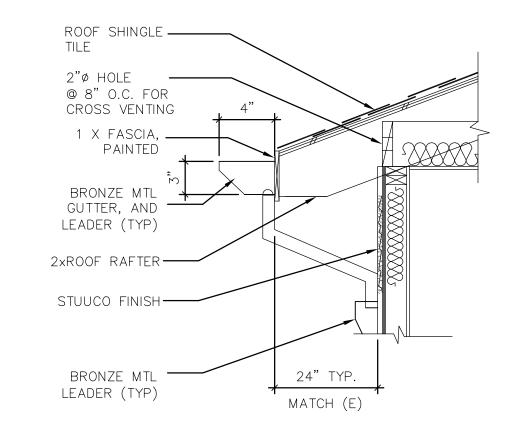

A2- EAVE DETAIL

SHEATHING

1/2" GYP. BD.

2 X6 DF#2 STUDS
AT 16" O.C. U.N.O.

MIN. 7/8" STUCCO ON
2 LAYERS GRADE D
PAPER AND LATH

R-19 FIBERGLASS BATT
INSULATION AT NEW
EXTERIOR WALLS (TYP)


SHEET TITLE

DRAWN BY: DM

N.T.S

BUILDING SECTIONS

A3-TYP. EXTERIOR WALL W/STUUCO N.T.S

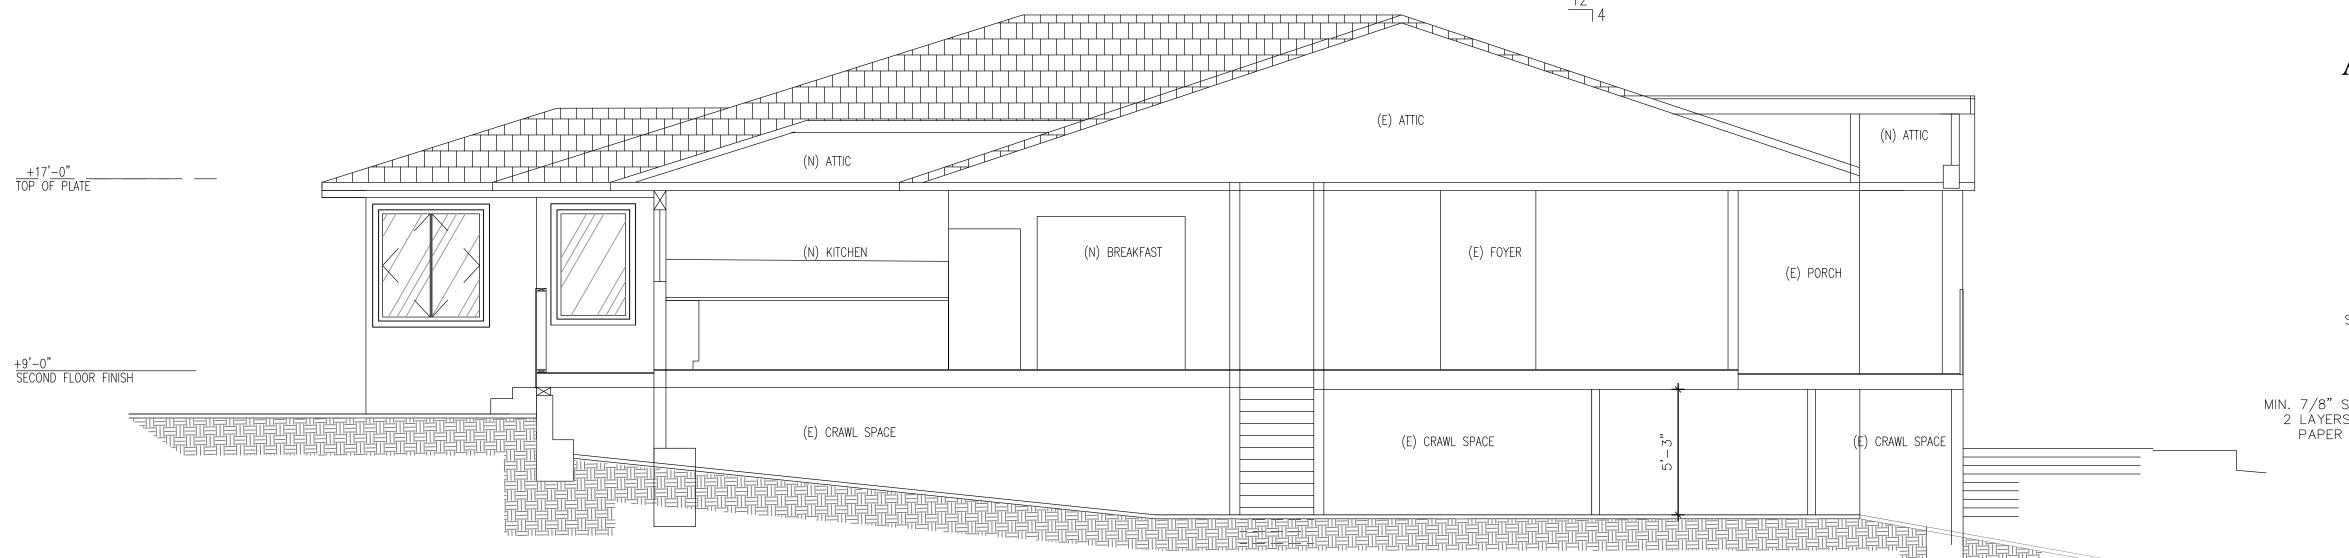


2- BUILDING SECTION: B-B SCALE: 1/4"=1'-0"


1- BUILDING SECTION: A-A
SCALE: 1/4"=1'-0"

<u>+24'-8"</u> ____

+0'-0"
GARAGE FINISH

A4.0

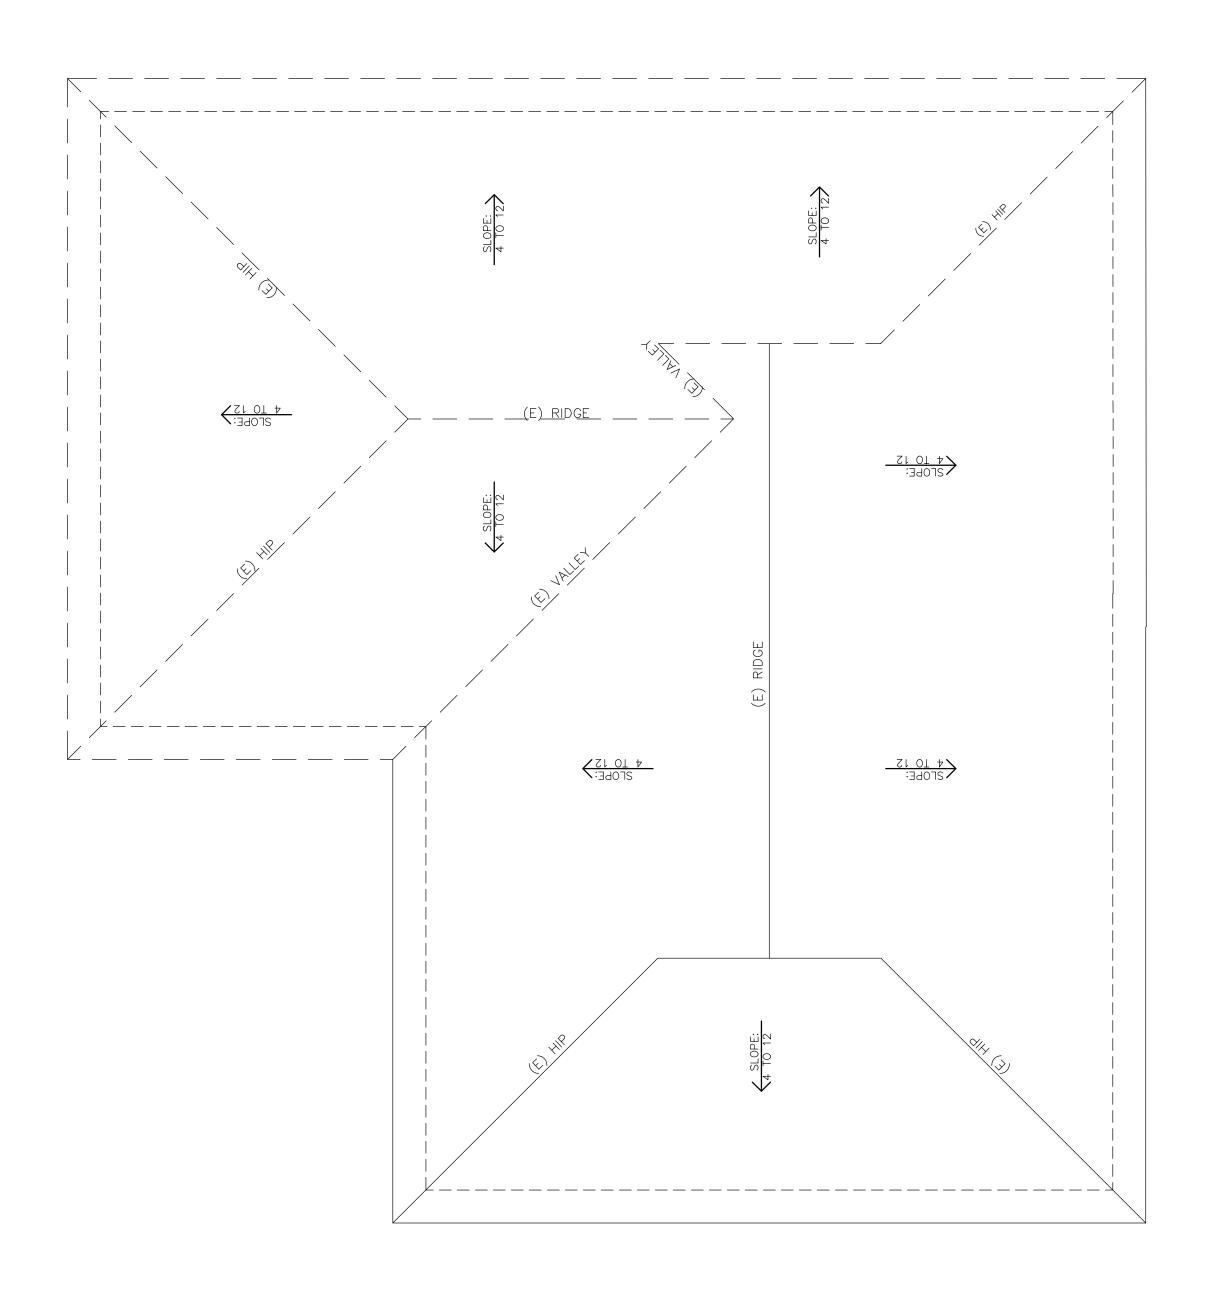

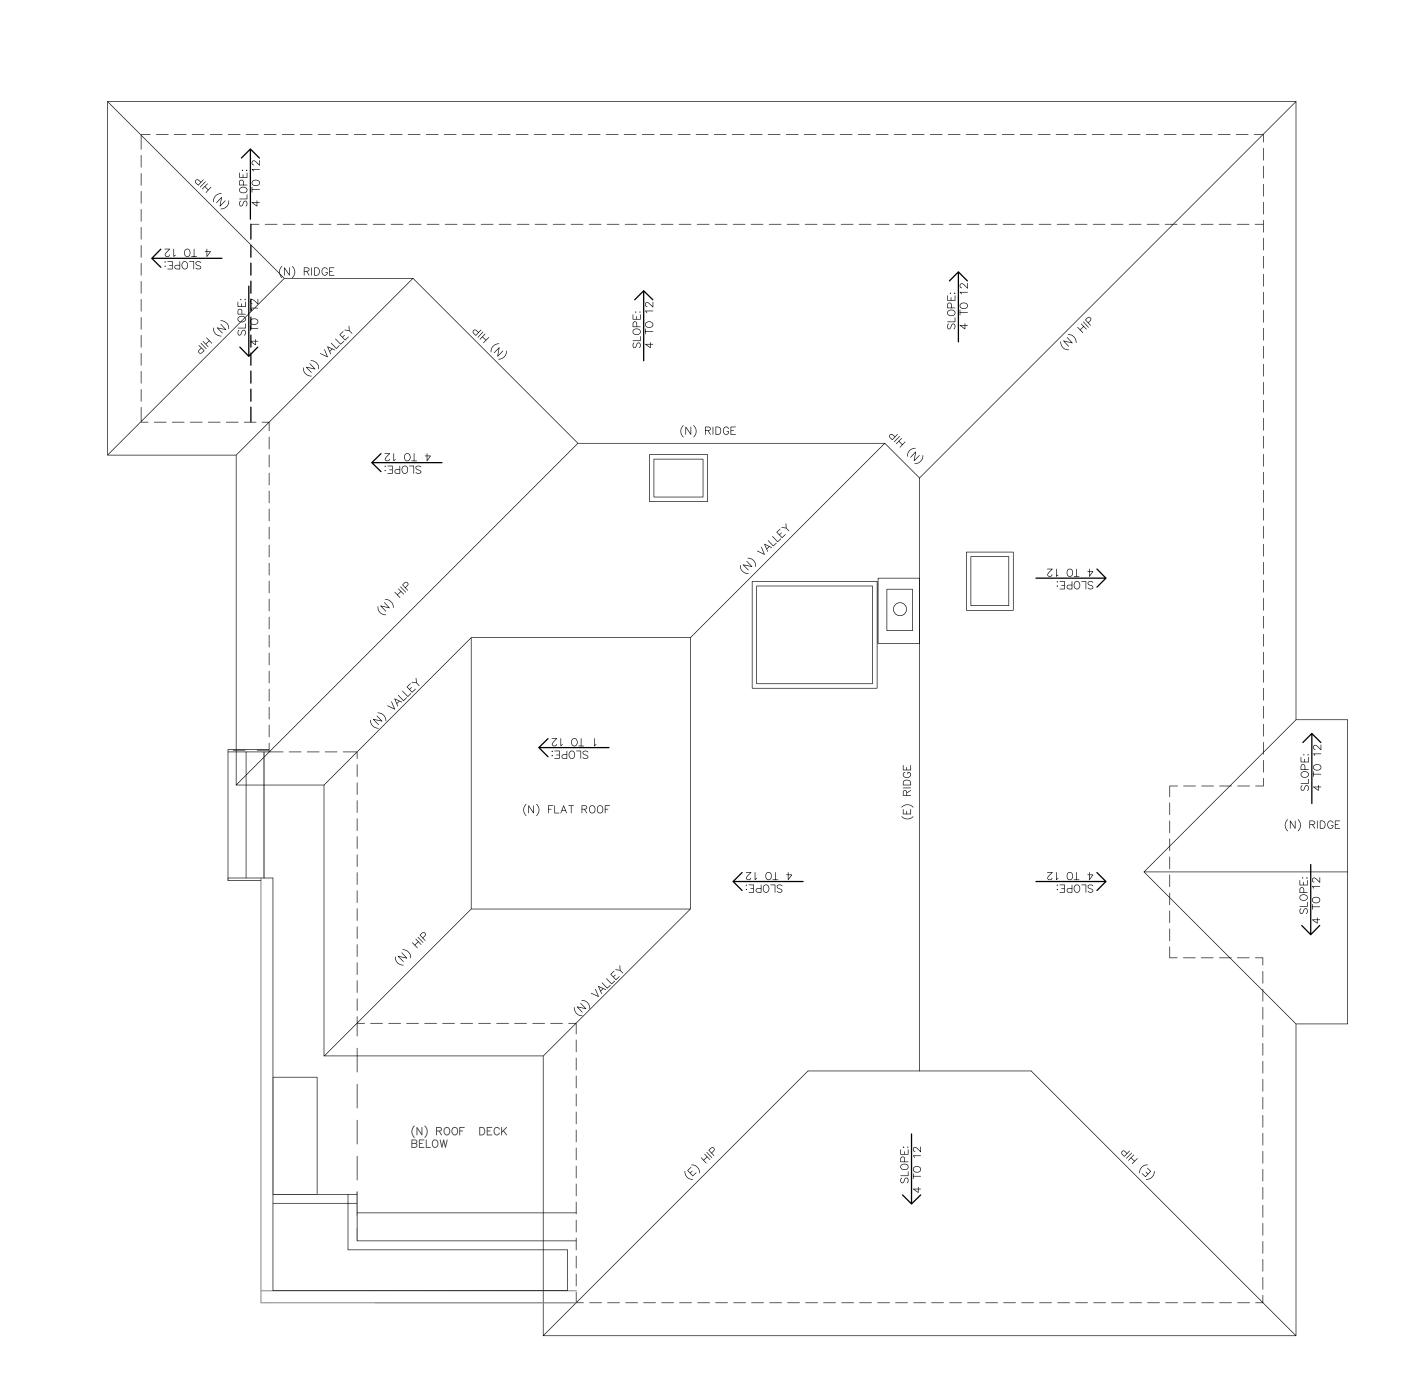

PROJECT:

RESIDENTIAL REMODEL & ADDITION

EΩ

LIN FAMILY

XIE ASSOCIATES, INC.
Architectural Design & Planning

501 CRESCENT WAY #5412
SAN FRANCISCO, CA 94134

Tel: (415) 652-3047
Fax: (415) 656-0542
Email: bill@xiearchdesign.com

2721 MARTINEZ DR. BURLINGAME CALIFORNIA

DRAWN BY: DM

CHECK BY:

DATE: 07/29/1


D 2018, NE ASSOCIATES, WARNING: NO COPPING, DUPLICATION OR DEBNATURE WORSE IN AM FORM IS PERSISTED WITHOUT THE EXPRESS WRITTEN PERMISSION OF NE ASSOCIATES, INC.




SHEET TITLE

ROOF PLANS

A2.2

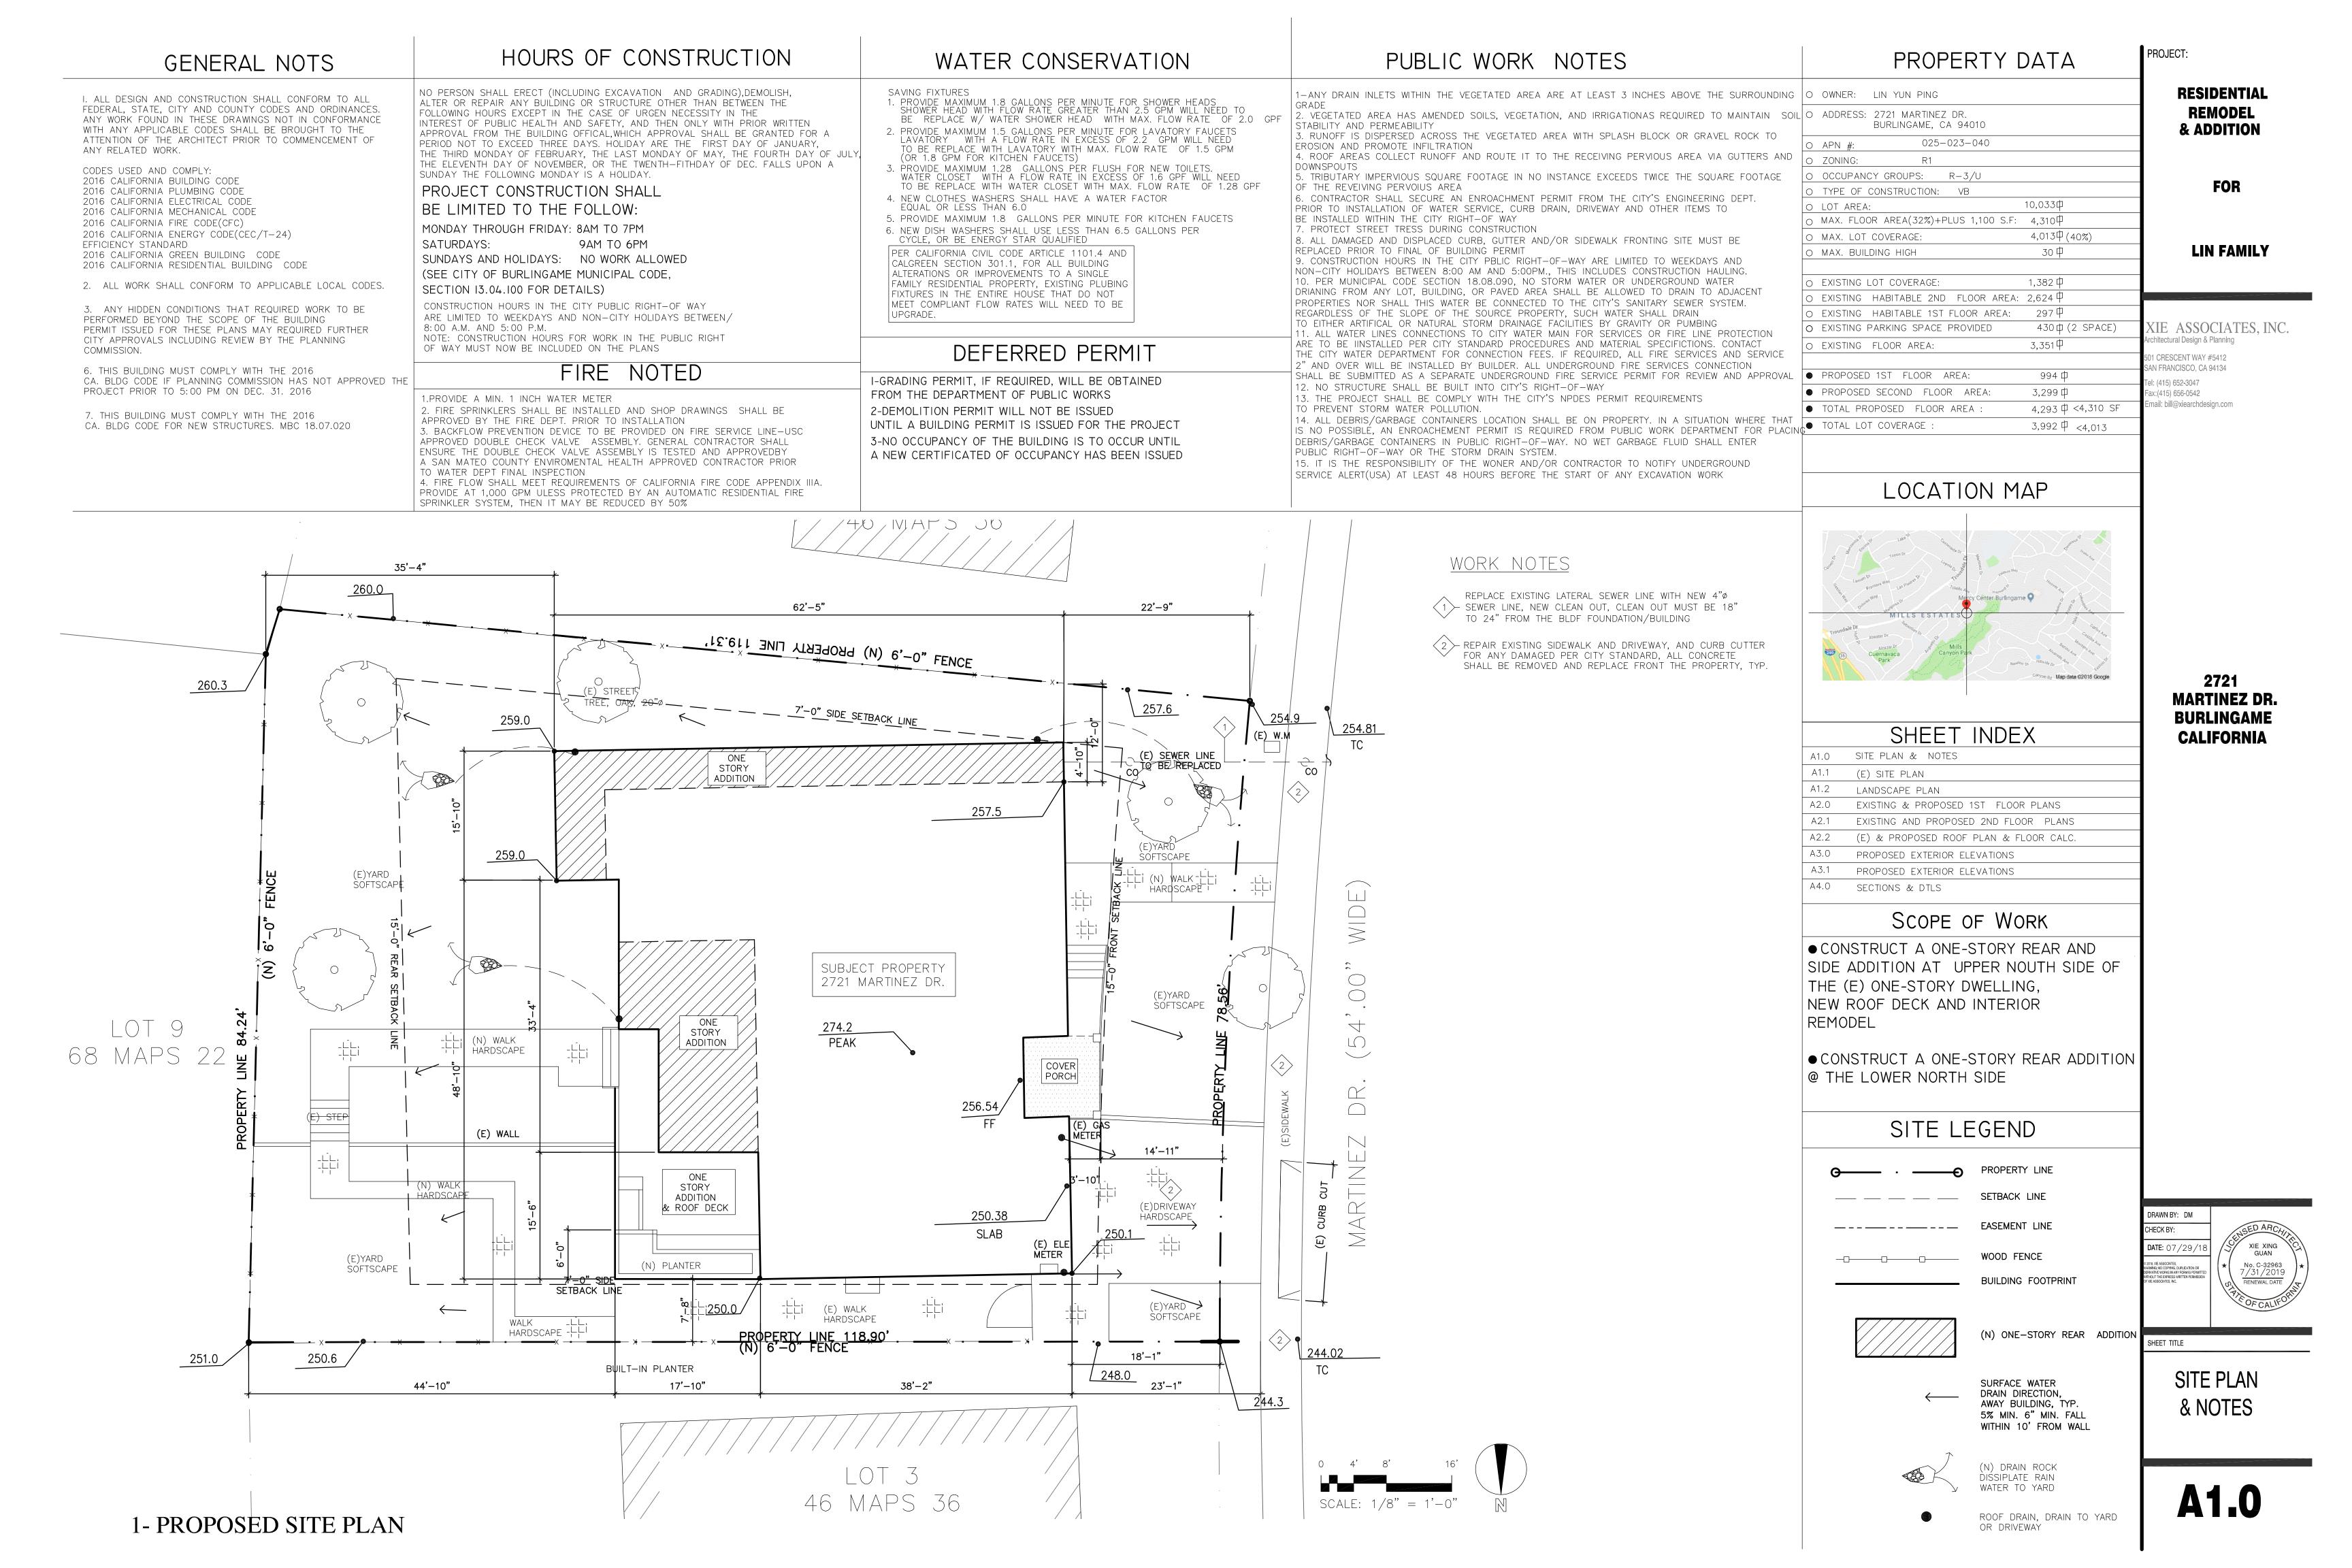

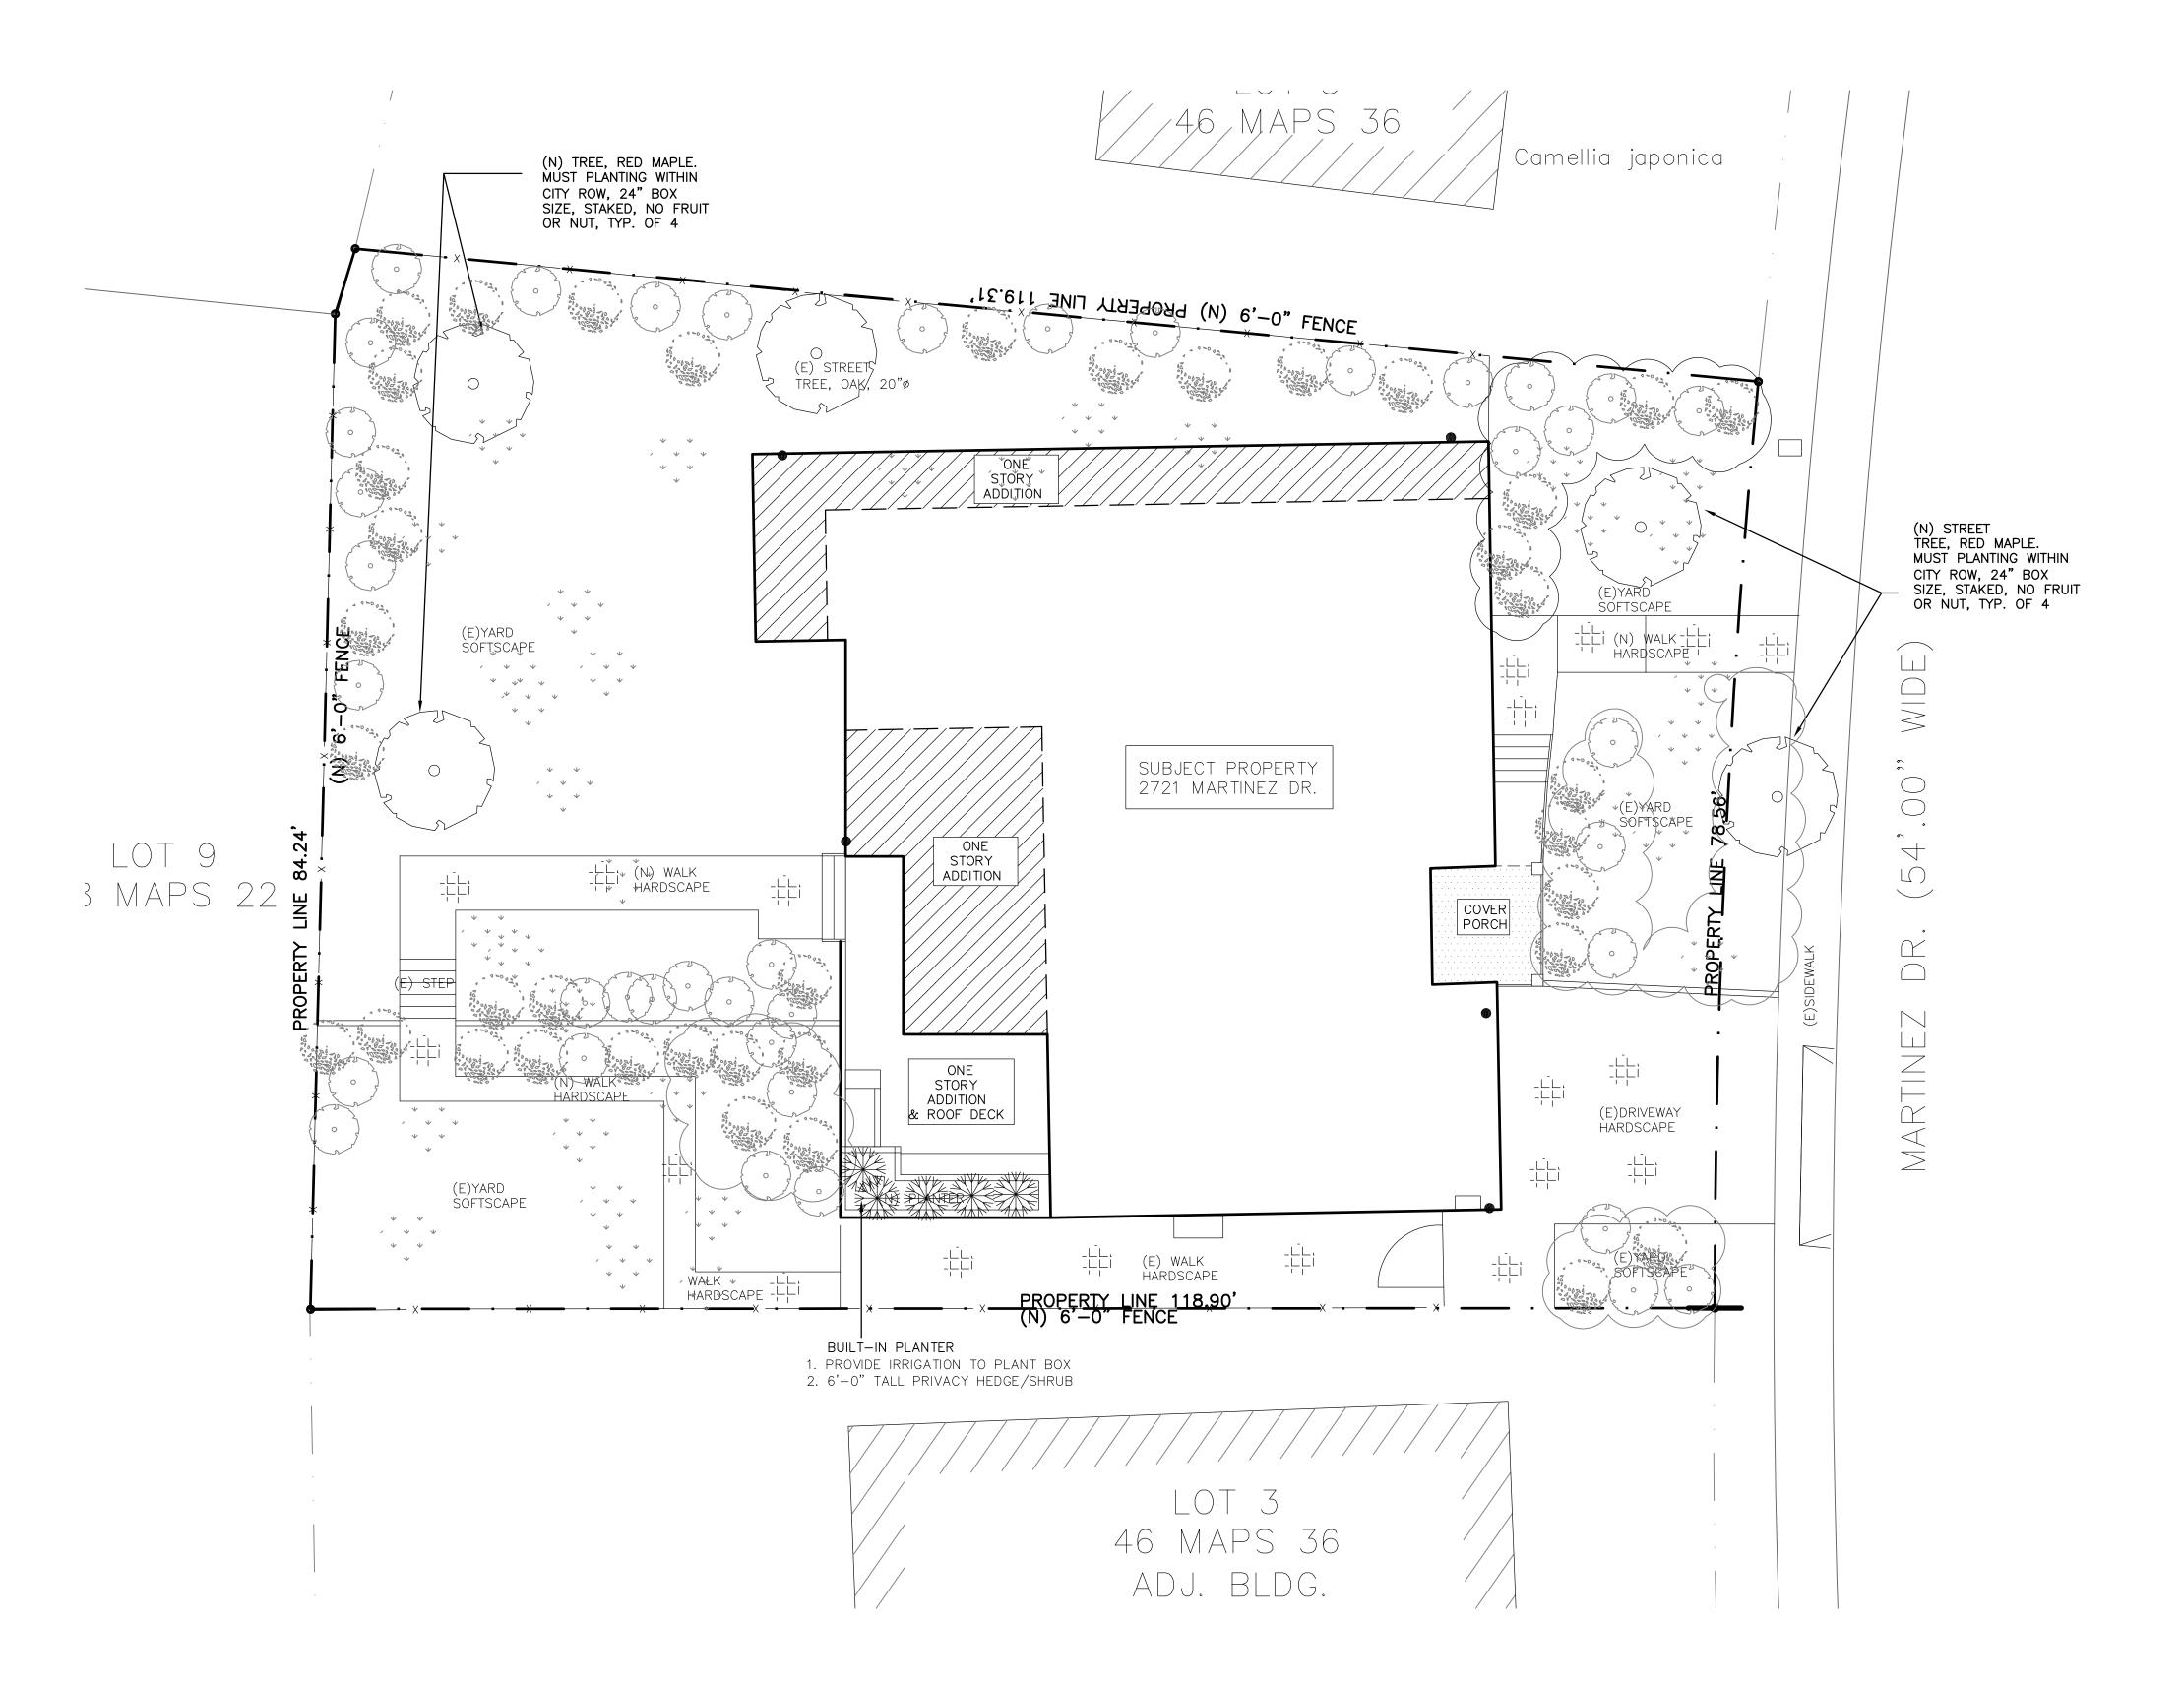

PLANT LIST

TREES	BOTANICAL NAME	COMMON NAME	SIZE	SPACING	QTY	WTR USE
	(E) TREE	(E) TREE		PER PLAN	4	
SHRUB						
	(E) SHRUB SOFTSCAPE PREVIOUS SURFACE					
	(E) SHRUB SOFTSCAPE PREVIOUS SURFACE					
	(E) SHRUB SOFTSCAPE PREVIOUS SURFACE					
	CAMELLIA JAPONICA	CAMELLIA	5 GALLON		6	LOW
GRASSES						
* * * * * *	(E) GRASS SOFTSCAPE PREVIOUS SURFACE					
	STONE PAVING					

1. IRRIGATION TO BE PER CITY OF BURLINGAME STANDARDS

2. ALL PLANTING AREAS TO IRRIGATED BY AN AUTOMATIC IRRIGATION SYSTEM UTILIZING A WEATHER-BASED CONTROLLER AND LOW-FLOW HEADS TO MEET ALL REQUIREMENT PER CITY OF BURLINGAME STANDARDS 3. EXISTING LANDSCAPE TO REMAIN

4. ALL NEW PLANTING TO BE ADDRESS AT FINAL BUILDING

PERMIT DRAWINGS

NO EXISTING TREE OVER 48" CIRCUMFERENCE AT 54" FROM BASE TO BE REMOVED

RESIDENTIAL

PROJECT:

REMODEL & ADDITION

LIN FAMILY

XIE ASSOCIATES, INC. Architectural Design & Planning 501 CRESCENT WAY #5412

SAN FRANCISCO, CA 94134 Tel: (415) 652-3047 Fax:(415) 656-0542 Email: bill@xiearchdesign.com

> 2721 **MARTINEZ DR. BURLINGAME CALIFORNIA**

LANDSCAPE PLAN

