


GRAPHIC SCALES: 1/16" = 1'-0" 25' 0 1' 5' 10' 15' 0 15' 0 1' 5' 10' 15' 0 15'

LEFT ELEVATION SCALE: 1/4" = 1'-0"

EGRESS WINDOW CHART						
WINDOW	SIZE	NET CLEAR OPENING AREA	SILL HEIGHT			
1	36" X 60"	32" X 58" = 12.89 sf	+36" A.F.F.			
2	36" X 48"	32" X 44" = 9.78 sf	+36" A.F.F.			
3	36" X 84"	34" X 84" = 19.83 sf	SWING DOOR			
4	36" X 54"	32" X 52" = 11.55 sf	+30" A.F.F.			

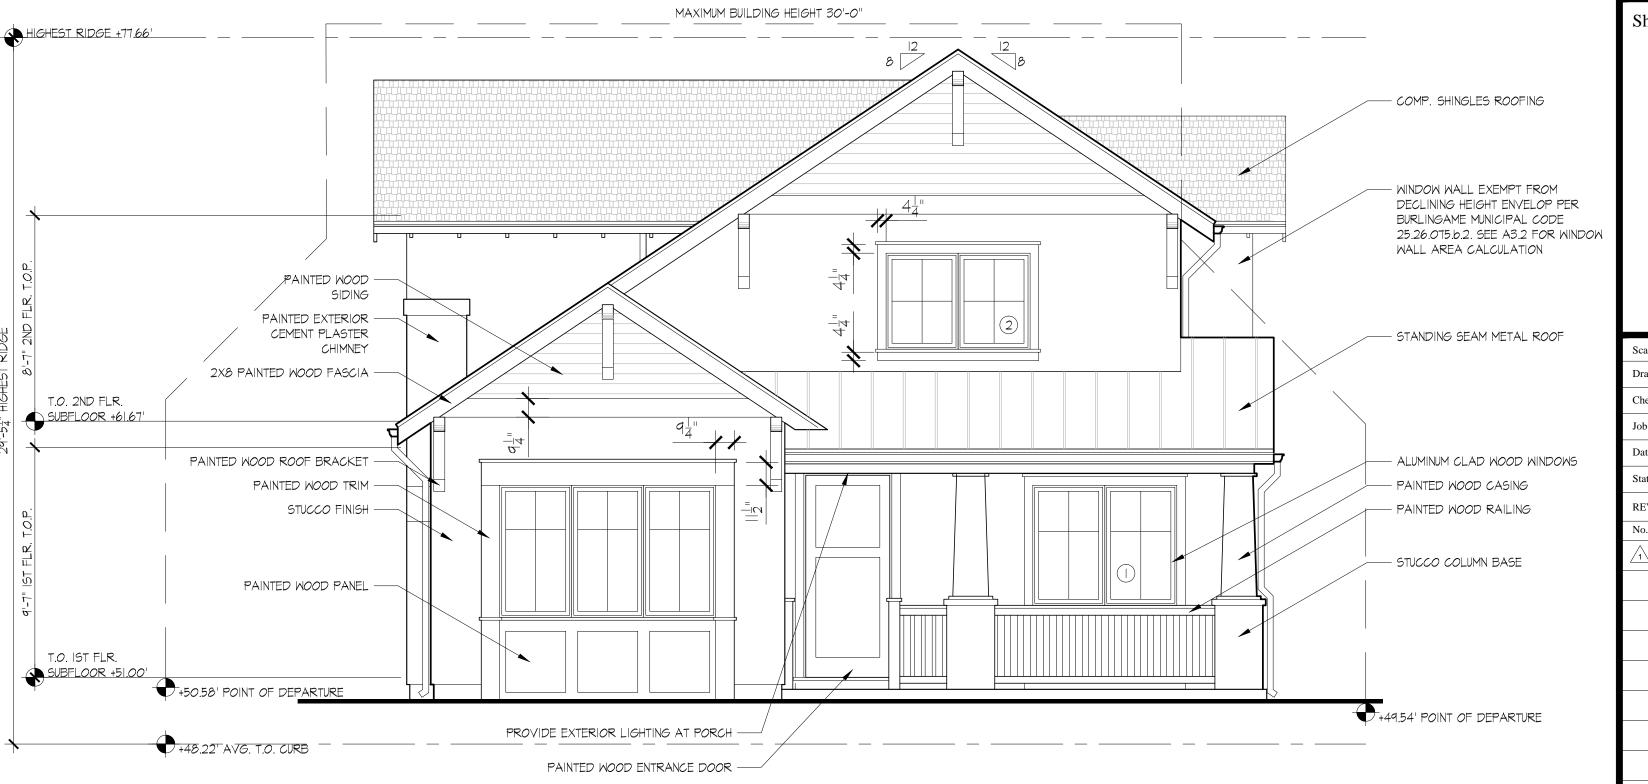

FRONT ELEVATION SCALE: 1/4" = 1'-0"

TRG ARCHITEC 1014 Howard Avenue San Mateo, California 94401 FAX 650.579.0115 650.579.5762 E-Mail: admin@trgarch.com

> Architect: T.RANDOLPH GRANGE C-22.222

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Consultant(s):

Project:

McVEIGH Residence New Residence

APN: 028-284-040

329 Occidental Ave Burlingame, CA 94010

Owner(s):

JULIA AND JOE McVEIGH

Sheet Contents:

EXTERIOR ELEVATIONS

AS NOTED Drawn by: Checked By: TRG PLANNING SUBMITTAL 12-11-18 REVISIONS No. Revisions By Date App CR 01-16-19 **REVISION SET 1**

TRG ARCHITECT

1014 Howard Avenue

San Mateo, California 94401 FAX 650.579.0115



10'-0"

4'-8"

WINDOW WALL AREA CALCULATION

TOP PLATE

PROVIDED

AREA : 85.21 SF MIN. WINDOW AREA:

FINISHED FLOOR

PAINTED WOOD ROOF BRACKET -PAINTED WOOD SIDING 2X8 PAINTED WOOD FASCIA -MAXIMUM BUILDING HEIGHT 30'-0" HIGHEST RIDGE +77.66' COMP. SHINGLES ROOFING — EXEMPT FROM DECLINING HEIGHT -ENVELOP PER BURLINGAME MUNICIPAL CODE 25.26.075.b.2. PAINTED WOOD PANEL -PAINTED EXTERIOR CEMENT -PLASTER CHIMNEY - STUCCO FINISH - STANDING SEAM METAL ROOF WOOD TRELLIS W/ STANDING SEAM T.O. 2ND FLR. METAL ROOF SUBFLOOR +61.67' PAINTED WOOD CASING -STUCCO COLUMN BASE — - ALUMINUM CLAD WOOD WINDOWS - PAINTED WOOD TRIM - PAINTED WOOD PANEL T.O. IST FLR. SUBFLOOR +51.00' +50.58' POINT OF DEPARTURE +49.54' POINT OF DEPARTURE PROVIDE EXTERIOR LIGHTING AT PORCH ---+48.22' AVG. T.O. CURB

REAR ELEVATION

RIGHT ELEVATION

SCALE: 1/4" = 1'-0"

SCALE: 1/4" = 1'-0"



650.579.5762 E-Mail: admin@trgarch.com Architect: T.RANDOLPH GRANGE C-22.222

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Project:

McVEIGH RESIDENCE New Residence

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329 Occidental Ave Burlingame, CA 94010

Owner(s):

JULIA AND JOE McVEIGH

Sheet Contents:

EXTERIOR ELEVATIONS

Scale:	AS NOTED						
Drawn by:							
Checked By: TRG							
Job:							
Date:	te: PLANNING SUBMITTAL 12-11-18						
Status:							
REVISIONS							
No.	Revisions	Ву	Date	Appr.			
1	REVISION SET 1	CR	01-16-19				
Sheet:							

RG ARCHITECTURE +
INTERIOR DESIGN

1014 Howard Avenue San Mateo, California 94401 FAX 650.579.0115 650.579.5762 E-Mail: admin@trgarch.com

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Protection Act of 1990. This protection includes, but is not limited to the overall form as well as the arrangement and composition of spaces and elements of the design. Under such protection, unauthorized use of these plans, work, or project represented, can legally result in the cessation of construction or building being seized and/or monetary compensation to TRG Architects.

McVEIGH Residence

New Residence

APN: 028-284-040

329 Occidental Ave

Burlingame, CA 94010

JULIA AND JOE McVEIGH

PROPOSED GARAGE

FLOOR PLAN &

ELEVATIONS

PLANNING SUBMITTAL 12-11-18

By Date Ap

CR 01-16-19


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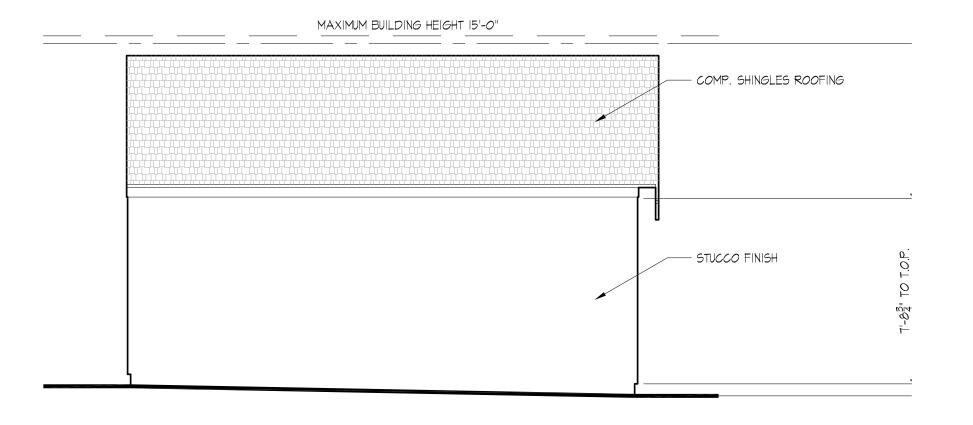
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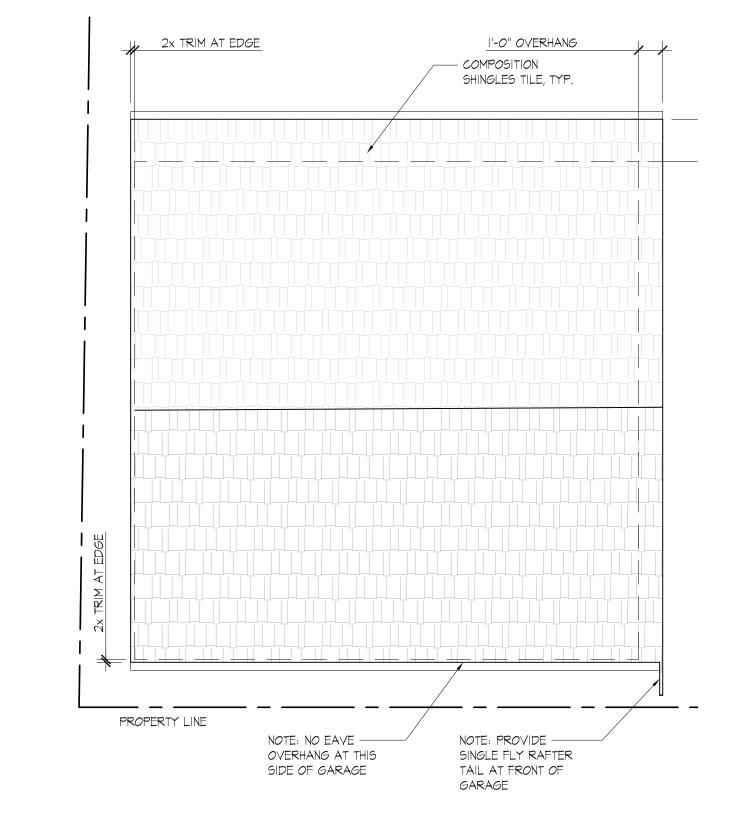
Project:

Owner(s):

Sheet Contents:






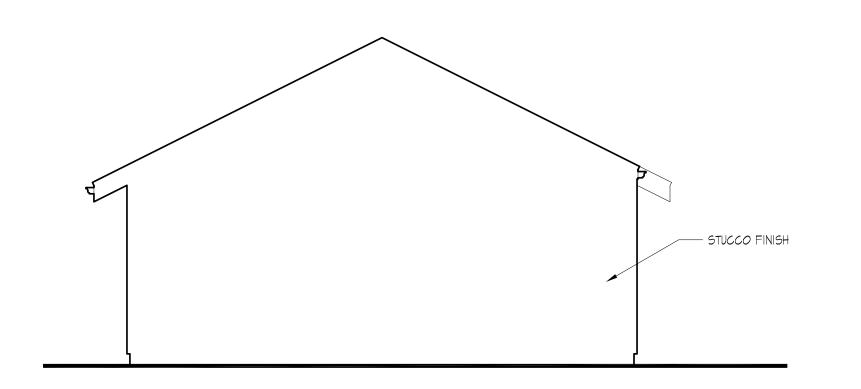



PROPOSED GARAGE LEFT ELEVATION



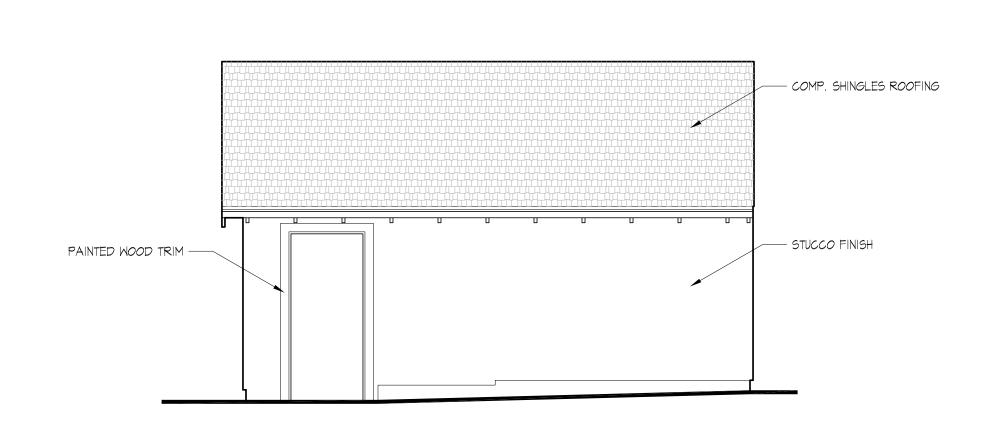

SCALE: 1/4" = 1'-0"

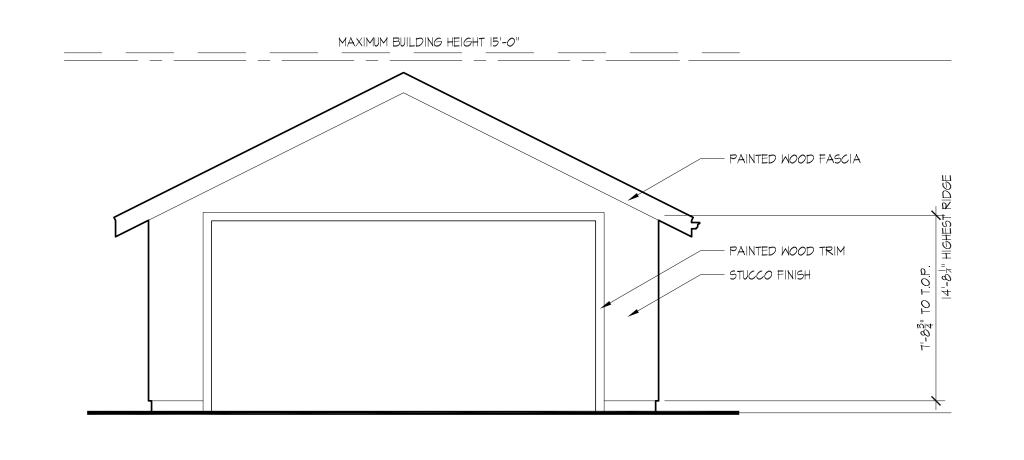

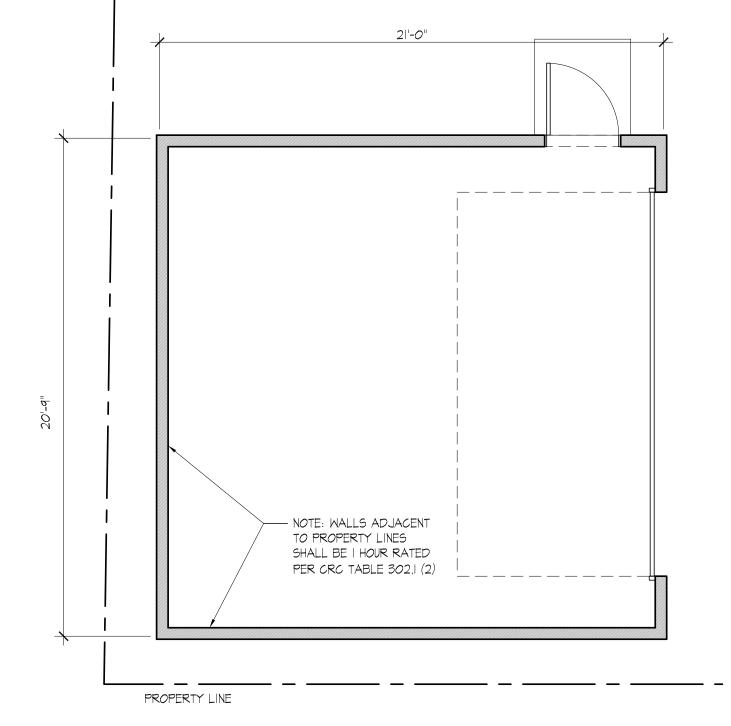



PROPOSED GARAGE REAR ELEVATION

PROPOSED GARAGE FRONT ELEVATION

SCALE: 1/4" = 1'-0"

PROPOSED GARAGE FLOOR PLAN

SCALE: 1/4" = 1'-0"

Sheet: **A3.3**Of ____ Sheets

CONSTRUCTION SHALL COMPLY WITH THE FOLLOWING CODES:

-2016 CALIFORNIA BUILDING CODE -2016 CALIFORNIA RESIDENTIAL CODE

-2016 CALIFORNIA ELECTRICAL CODE -2016 CALIFORNIA MECHANICAL CODE -2016 CALIFORNIA PLUMBING CODE -2016 CALIFORNIA ENERGY CODE

-2016 CALIFORNIA FIRE CODE -2016 CALIFORNIA GREEN BUILDING STANDARDS CODE

-INCLUDING ALL AMENDMENTS AS ADOPTED IN ORDINANCE 1856-2010, 1889-2016

PLANS SHALL COMPLY WITH THE 2016 CALIFORNIA ENERGY EFFICIENCY STANDARDS

PLANS SHALL COMPLY WITH THE 2010 UNIFORM FIRE CODE AS AMENDED BY THE CITY OF BURLINGAME.

CONSTRUCTION HOURS:

NO PERSON SHALL ERECT (INCLUDING EXCAVATE AND GRADING), DEMOLISH, ALTER OR REPAIR ANY BUILDING OR STRUCTURE OTHER THAN BETWEEN THE FOLLOWING HOURS STATED BELOW. HOLIDAYS ARE THE FIRST DAY OF JANUARY, THE THIRD MONDAY IN JANUARY, THE THIRD MONDAY OF FEBRUARY, THE LAST MONDAY OF MAY, JULY 4, THE FIRST MONDAY OF SEPTEMBER, THE SECOND MONDAY IN OCTOBER, NOVEMBER II, THE FOURTH THURSDAY OF NOVEMBER AND THE TWENTY-FIFTH DAY OF DECEMBER. WHENEVER A HOLIDAY FALLS ON A SUNDAY, THE MONDAY FOLLOWING IS ALSO A HOLIDAY. WHENEVER A HOLIDAY DEFINED ABOVE FALLS ON A SATURDAY, THE FRIDAY PRECEDING IS ALSO A HOLIDAY THE FOLLOWING MONDAY IS A HOLIDAY.

CONSTRUCTION HOURS SHALL BE AS NOTED PER BURLINGAME MUNICIPAL CODE, SECTION 13.04.100:

WEEKDAYS 8:00AM - 7:00PM SATURDAYS: 9:00AM - 6:00PM SUNDAYS AND HOLIDAYS: NO WORK ALLOWED (SEE CITY OF BURLINGAME MUNICIPAL CODE, SECTION 13.04.100 FOR DETAILS) CONSTRUCTION HOURS IN THE CITY PUBLIC RIGHT-OF-WAY ARE LIMITED TO WEEKDAYS AND NON-CITY HOLIDAYS BETWEEN 8:00 A.M. AND 5:00 P.M.

GENERAL NOTES:

GENERAL CONTRACTOR AND ALL SUBCONTRACTORS ARE RESPONSIBLE FOR OBTAINING ALL REQUIRED PERMITS PRIOR TO COMMENCEMENT OF WORK.

DO NOT SCALE DRAWINGS. VERIFY ALL DIMENSIONS IN FIELD. REPORT ANY DISCREPANCIES TO ARCHITECT AND STRUCTURAL ENGINEER BEFORE PROCEEDING W/

ALL DIMENSIONS ARE TO FACE OF CONCRETE FOOTING OR STUD, U.N.O. SEE LEGEND.

PRIOR TO COMMENCEMENT OF WORK, THE GENERAL CONTRACTOR AND SUB-CONTRACORS SHALL REVIEW THE PLANS, VERIFY DIMENSIONS AND CONDITIONS IN THE FIELD AND NOTIFY THE ARCHITECT OF ANY DISCREPANCIES OR INCONSISTENCIES WHICH MIGHT AFFECT THE WORK TO BE DONE.

CONTRACTOR SHALL PROTECT ALL MATERIALS AND CONSTRUCTION FROM DAMAGE WHICH MAY OCCUR FROM CONSTRUCTION, DEMOLITION, DUST, WATER, ETC. AND SHALL LEAVE THE PREMISES CLEAN AND IN AN ORDERLY MANNER. CONTRACTOR IS RESPONSIBLE FOR MAKING ALL WORK PLUMB, LEVEL, OF SOUND CONSTRUCTION, AND IN COMPLIANCE WITH ALL LOCAL BUILDING CODES. CONTRACTOR TO VERIFY ALL CONDITIONS PRIOR TO THE EXECUTION OF THE WORK, AND NOTIFY THE ARCHITECT OF ANY INCONSISTENCIES WHICH MAY AFFECT THE WORK TO BE DONE.

REFER TO LEGEND BELOW & NOTES ON DEMO PLAN FOR STRUCTURAL ELEMENTS TO BE ALTERED OR REMOVED. REPORT ANY DISCREPANCIES TO ARCHITECT PRIOR TO COMMENCEMENT OF WORK.

PRIOR TO DEMOLITION, VERIFY W/ OWNER & ARCHITECT ALL MECH, EQUIP. PLUMBING FIXTURES, ELECTRICAL EQUIP., LIGHTING, CABINETRY, WINDOWS, DOORS OR OTHER INTERIOR ELEMENTS TO BE REMOVED, REUSED, RECYCLED OR DISCARDED.

GENERAL CONTRACTOR TO VERIFY EXISTING STRUCTURAL & LOAD TRANSFER CONDITIONS PRIOR TO DEMOLITION & INSURE ADEQUATE TEMPORARY SHORING IS PROVIDED AS NEEDED DURING CONSTRUCTION.

ANY REMOVAL OF ASBESTOS SHALL COMPLY W/ ALL APPLICABLE LAWS AND ORDINANCES.

PROJECT NOTES:

THIS PROJECT SHALL COMPLY WITH THE CITY'S NPDES PERMIT REQUIREMENT TO PREVENT STORM WATER POLLUTION. A COPY OF THE CITY'S METHODS OF PREVENTING STORM WATER POLLUTION WILL BE ATTACHED TO THE CONSTRUCTION DOCUMENTS WHEN SUBMITTED TO THE BUILDING DEPT.

ANY HIDDEN CONDITIONS THAT REQUIRE WORK TO BE PERFORMED BEYOND THE SCOPE OF THE BUILDING PERMIT ISSUED FOR THESE PLANS MAY REQUIRE FURTHER CITY APPROVALS INCLUDING REVIEW BY THE PLANNING COMMISSION. THE BUILDING OWNER, PROJECT DESIGNER AND/OR CONTRACTOR MUST SUBMIT A REVISION TO THE CITY FOR ANY WORK NOT GRAPHICALLY ILLUSTRATED IN THESE PLANS PRIOR TO PERFORMING THIS WORK.

PROJECT NOTES (CONTINUED):

THE PROJECT SHALL DESIGN AND CONSTRUCT FRONTAGE PUBLIC IMPROVEMENTS INCLUDING CURB, GUTTER, SIDEWALK AND OTHER NECESSARY APPURTENANT WORK PER CITY'S STANDARDS.

0 5' 25' 0 1' 5' 10' 15' 0 1' 5' 10' 12' 0 1' 4' 0 1' 1' 1/8" = 1'-0" 3/16" = 1'-0" 3/4" = 1'-0"

ALL INTERIOR WALLS & CEILINGS TO BE 5/8" GYPSUM BOARD U.N.O.

EXTERIOR LIGHTING:

EXTERIOR LIGHTING SHALL BE DESIGNED AND LOCATED SO THAT THE CONE OF LIGHT AND/OR GLARE FROM THE LIGHTING ELEMENT IS KEPT ENTIRELY ON THE PROPERTY OR BELOW THE TOP OF ANY FENCE, EDGE OR WALL (BURLINGAME MUNICIPAL CODE 18.16.030).

EXTERIOR LIGHTING OUTLETS AND FIXTURES SHALL NOT BE LOCATED MORE THAN 9' ABOVE ADJACENT GRADE OR REQUIRED LANDING; WALLS OR PORTIONS OF WALLS SHALL NOT BE FLOODLIT; ONLY SHIELDED LIGHT FIXTURES WHICH FOCUS LIGHT DOWNWARD SHALL BE ALLOWED, EXCEPT FOR ILLUMINATED STREET NUMBER REQUIRED BY THE FIRE DEPARTMENT.

LIGHTING SHALL BE PROVIDED AT ALL EXTERIOR LANDINGS.

RESIDENTIAL FIRE SPRINKLER SYSTEM REQUIRED:

- A RESIDENTIAL FIRE SPRINKLER SYSTEM SHALL BE PROVIDED THROUGHOUT THE BUILDING. FIRE SPRINKLER PLANS SHALL BE SUBMITTED UNDER SEPARATE PERMIT
- THROUGH THE FIRE DEPARTMENT FOR APPROVAL PRIOR TO INSTALLATION. PROVIDE BACKFLOW PREVENTION DEVICE; USE APPROVED DOUBLE CHECK VALVE ASSEMBLY. GC SHALL ENSURE THE DOUBLE CHECK VALVE SHALL BE TESTED AND APPROVED BY A SAN MATEO COUNTY ENVIRONMENTAL HEALTH APPROVED CONTRACTOR PRIOR TO WATER DEP. FINAL INSPECTION.
- MIN. ONE INCH WATER METER REQUIRED. FIRE FLOW SHALL MEET ROMNT'S OF CFC APPENDIX B. FIRE FLOW FOR RESIDENTIAL BUILDINGS LESS THAN 3600sf SHALL BE PROVIDED AT 1000 gpm UNLESS PROTECTED BY AND AUTOMATIC RESIDENTIAL FIRE SPRINKLER SYSTEM, THEN IT MAY BE REDUCED BY 50%. CONTACT BURLINGAME ENGINEERING DEPT.

DEFERRED SUBMITTALS:

PROVIDE DEFERRED SUBMITTALS FOR THE FOLLOWING ITEMS:

- FIRE SPRINKLER SYSTEM
- TRUSS DESIGN PACKAGE CONTRACTOR SHALL SUBMIT FINAL TRUSS DESIGN PACKAGE TO ARCHITECT AND STRUCTURAL ENGINEER FOR REVIEW PRIOR TO PLACEMENT OF ORDER ..

ALL DEFERRED SUBMITTALS (SHOP DRAWINGS ALONG WITH CALCULATIONS NOTED TO BE SIGNED BY A REGISTERED CALIFORNIA ENGINEER) AS REQUIRED FOR THIS PROJECT SHALL FIRST BE SUBMITTED TO THE PROJECT ARCHITECT AND/OR ENGINEER OF RECORD FOR REVIEW AND COORDINATION. FOLLOWING THE COMPLETION OF THE REVIEW AND COORDINATION BY THE ENGINEER OF RECORD, A SUBMITTAL MAY THEN BE MADE TO THE CITY BUILDING DEPARTMENT FOR REVIEW AND APPROVAL, WHICH SHALL INCLUDE A LETTER STATING, "THIS REVIEW AND COORDINATION HAS BEEN PERFORMED AND COMPLETED. PLANS AND CALCULATIONS FOR THE DEFERRED ITEMS ARE FOUND TO BE ACCEPTABLE (E.G., WITH REGARD TO GEOMETRY, LOAD CONDITIONS, ETC.) WITH NO EXCEPTIONS."

LEGEND <u>WALLS</u> ☐ (E) WALL TO REMAIN WALL OR ITEM TO BE REMOVED OPENING TO BE INFILLED (N) WALL STUD to STUD STUD to FACE OF FINISH STUD to CENTERLINE

CONTACTS VICINITY MAP

ARCHITECTS

TRG ARCHITECTS, INC.

1014 HOWARD AVENUE, SAN MATEO, CA 94401 650.579.5762tel


650.579.0115 fax


SURVEYOR & CIVIL ENGINEERING

KAVANAGH ENGINEERING

708 CAROLAN AVE, **BURLINGAME CA 94010** 650.579-1944 tel



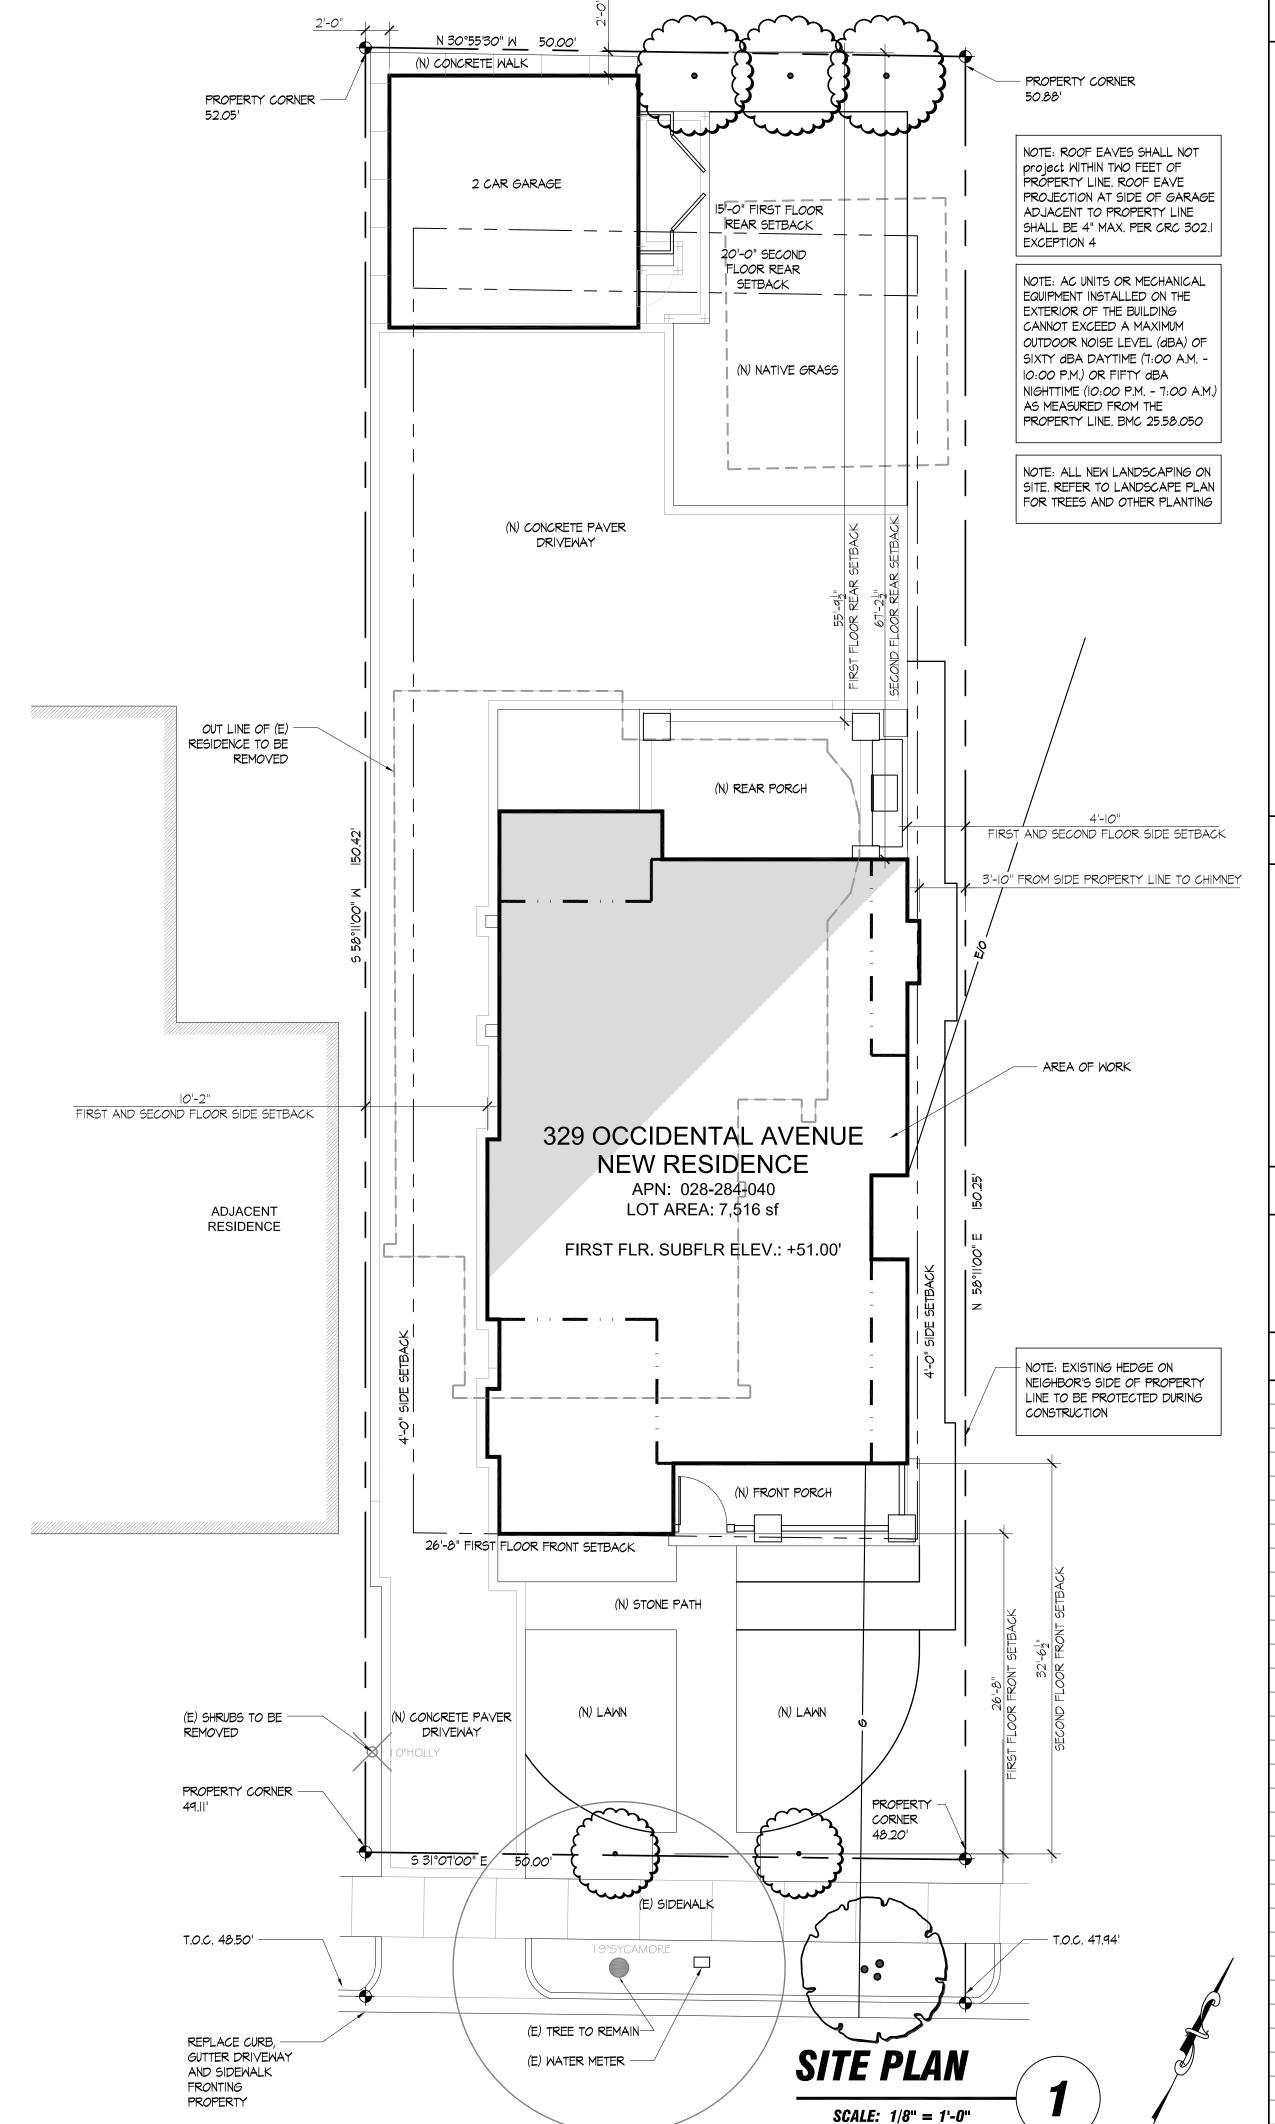

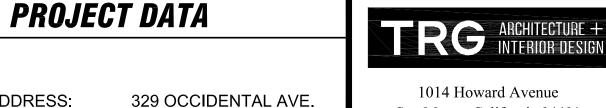

BURLINGAME, CA 94010

JULIA AND JOE McVEIGH

028-284-040

7,515.6 sf

3,006.24 sf

3,904.99 sf

2,064 sf

1,403 sf

3,903 sf

436 sf

129 sf

San Mateo, California 94401 FAX 650.579.0115 650.579.5762 E-Mail: admin@trgarch.com

Architect: T.RANDOLPH GRANGE C-22,222 EXP 10/19 /

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Consultant(s):

Project:

PROPOSED LOT COVERAGE: 2,084 sf (N) HOUSE & CHIMNEY: (N) 2nd STORY CANTILEVER: 0 sf 436 sf (N) GARAGE: 129 sf (N) COVERED PORCH: (N) REAR DECK: 0 sf 2,649 sf (N) TOTAL LOT COVERAGE:

PROJECT ADDRESS:

PARCEL NUMBER:

MAX LOT COVER (40%):

MAX. FLOOR AREA (32%

PROPOSED FLOOR AREA:

(N) 1st FLOOR:

(N) GARAGE

TOTAL FLOOR AREA:

(N) 2nd FLOOR:

(N) COVERED PORCH:

(200sf exemption)

+ 1,100sf + 400 sf for

detached garage)

OWNER:

LOT AREA:

35.25 % LOT COVERAGE %:

FRONT SETBACK

HOUSE# SETBACK #301 OCCIDENTAL AVE #309 OCCIDENTAL AVE 24.1' #315 OCCIDENTAL AVE #317 OCCIDENTAL AVE 26.0' #321 OCCIDENTAL AVE 19.8. #325 OCCIDENTAL AVE 26.5' #329 OCCIDENTAL AVE 38.0' #333 OCCIDENTAL AVE 34.0' #341 OCCIDENTAL AVE

329 Occidental Ave Burlingame, CA 94010

McVEIGH

RESIDENCE

New Residence

APN: 028-284-040

Owner(s):

Sheet Contents:

JULIA AND JOE McVEIGH

PROJECT SCOPE

REMOVAL OF EXISTING RESIDENCE AND GARAGE.

COVER SHEET

#1601 CHAPIN AVE

A0.1

AVERAGE FRONT SETBACK = 26.65'

CONSTRUCTION OF NEW TWO STORY RESIDENCE AND GARAGE.

SHEET INDEX NEIGHBORHOOD PHOTOS

PROPOSED FIRST FLOOR PLAN PROPOSED SECOND FLOOR PLAN PROPOSED ROOF PLAN A3.1 EXTERIOR ELEVATIONS EXTERIOR ELEVATIONS PROPOSED GARAGE FLOOR PLAN & ELEVATIONS BUILDING SECTION LANDSCAPE & IRRIGATION PLAN TOPOGRAPHIC MAP & BOUNDARY SURVEY

COVER SHEET

AS NOTED Checked By: TRG PLANNING SUBMITTAL 12-11-18

REVISIONS

No. Revisions By Date Ap COMMENTS RESPONSE-1 | CR | 01-16-19

NOTE: CRC SECTION 18.10.100 APPENDIX C, FIGURE C AMENDED -EXIT TERMINALS OF MECHANICAL DRAFT AND DIRECT-VENT VENTING SYSTEMS. THE FIGURE IN APPENDIX C OF THE 2016 CALIFORNIA RESIDENTIAL CODE IS AMENDED BY ADDING THE FOLLOWING NOTE: NOTE: WHERE THE PROPERTY LINE IS LESS THAN TEN (10) FEET FORM TEH EXIT TERMINAL OF ANY NEWLY INSTALLED OR REPLACEMENT HIGH EFFICIENCY MECHANICAL EQUIPMENT THE PIPE SIZE OF THE FINAL TEN (10) FEET OF ANY TERMINAL MUST BE INCREASED TO THREE INCHES (3"), OR AS AN ALTERNATIVE, MANUFACTURER APPROVED BAFFLES MUST BE INSTALLED (ORD. 1856 SECTION 7 (2010); ORD. 1889 SECTION 8 (2103))

1'-6" OVERHANG, TYP.

NOTE: MAIN RESIDENCE ROOF EAVES SHALL NOT PROJECT WITHIN 2'-0" OF PROPERTY LINE

- NOTE: OVERHANGS AT HOUSE MORE THAN 3'

FROM PROPERTY LINE. NO FIRE RESISTANCE

RATED REQUIRED PER CRC TABLE R302.1(2) PROPERTY LINE - COMPOSITION SHINGLE ROOFING, TYP. - SEE A2.2 FOR LOW ROOF SLOPES STANDING SEAM — METAL ROOF, TYP. 8:12 8:12 SOLAR PANELS 8.12 1'-6" OVERHANG, TYP.

PROPOSED ROOF PLAN

SCALE: 1/4" = 1'-0"

ARCHITECTURE +
INTERIOR DESIGN 1014 Howard Avenue

San Mateo, California 94401 FAX 650.579.0115 650.579.5762 E-Mail: admin@trgarch.com

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Project:

McVEIGH RESIDENCE

New Residence APN: 028-284-040

329 Occidental Ave Burlingame, CA 94010

Owner(s):

JULIA AND JOE McVEIGH

Sheet Contents:

PROPOSED ROOF PLAN

AS NOTED Checked By: TRG PLANNING SUBMITTAL 12-11-18

REVISIONS

By Date Ap No. Revisions **REVISION SET 1**

CR 01-16-19

A2.3

RC ARCHITECTURE +
INTERIOR DESIGN

1014 Howard Avenue San Mateo, California 94401 FAX 650.579.0115

650.579.5762 E-Mail: admin@trgarch.com

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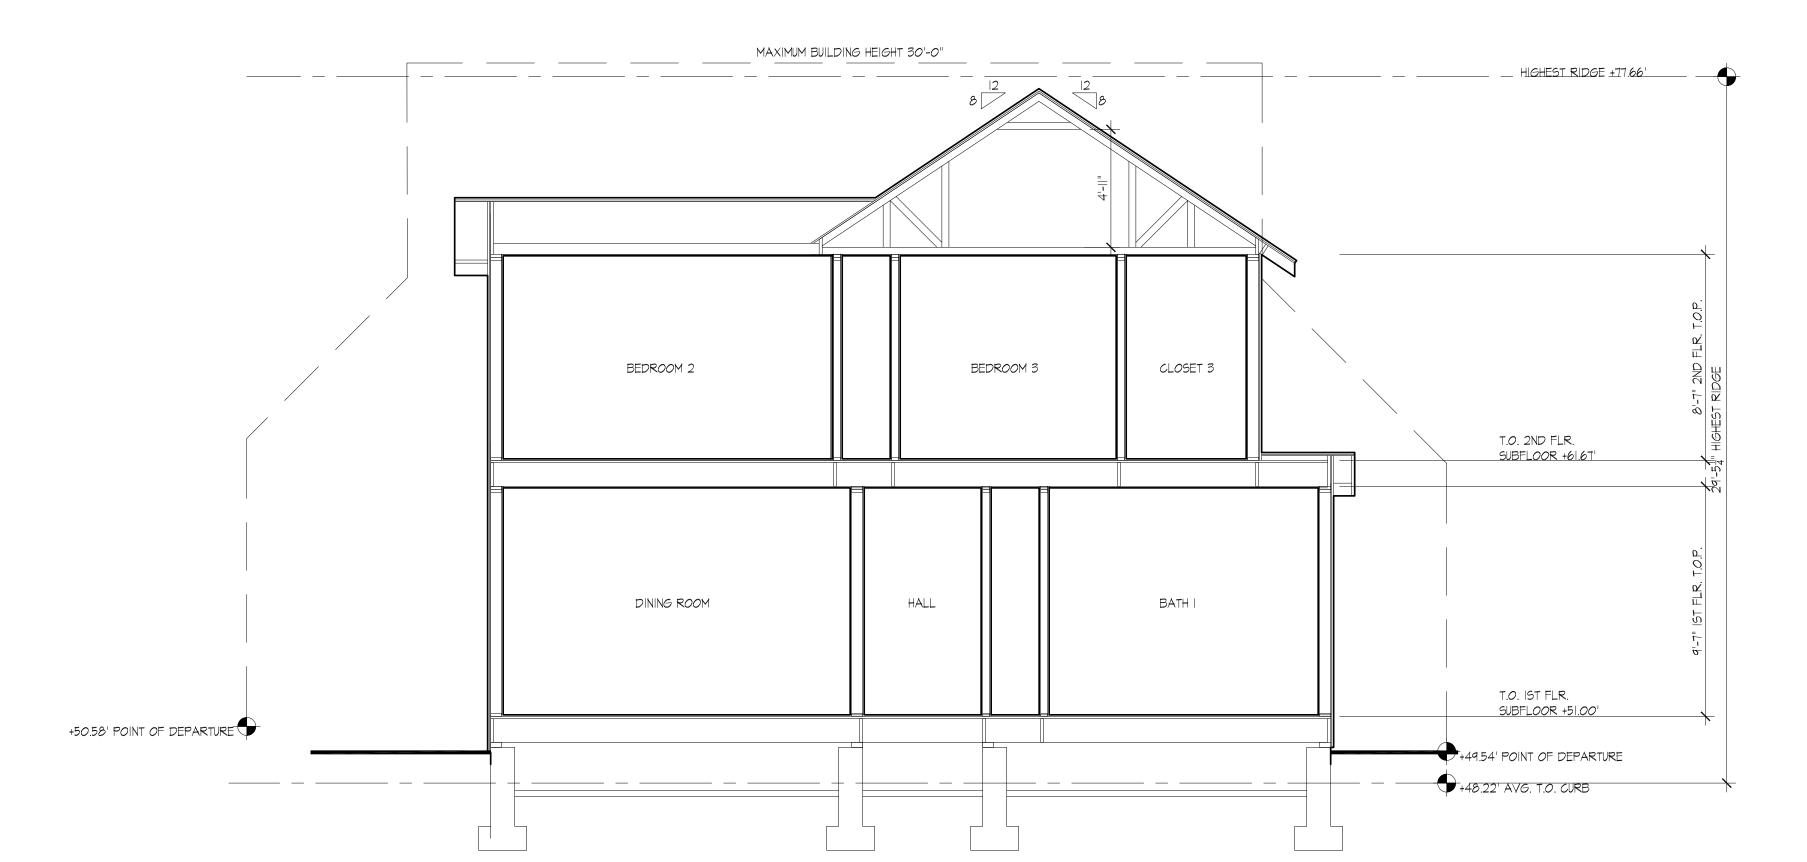
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BUILDING SECTION


Scale: AS NOTED Checked By: TRG (DD-MM-YY) REVISIONS By Date App

A4.1

NOTE: PRE-MANUFACTURED ATTIC TRUSSES TO LIMIT HEAD HEIGHT TO UNDER 5'-0" THROUGHOUT ATTIC.



BUILDING SECTION SCALE: 1/4" = 1'-0"

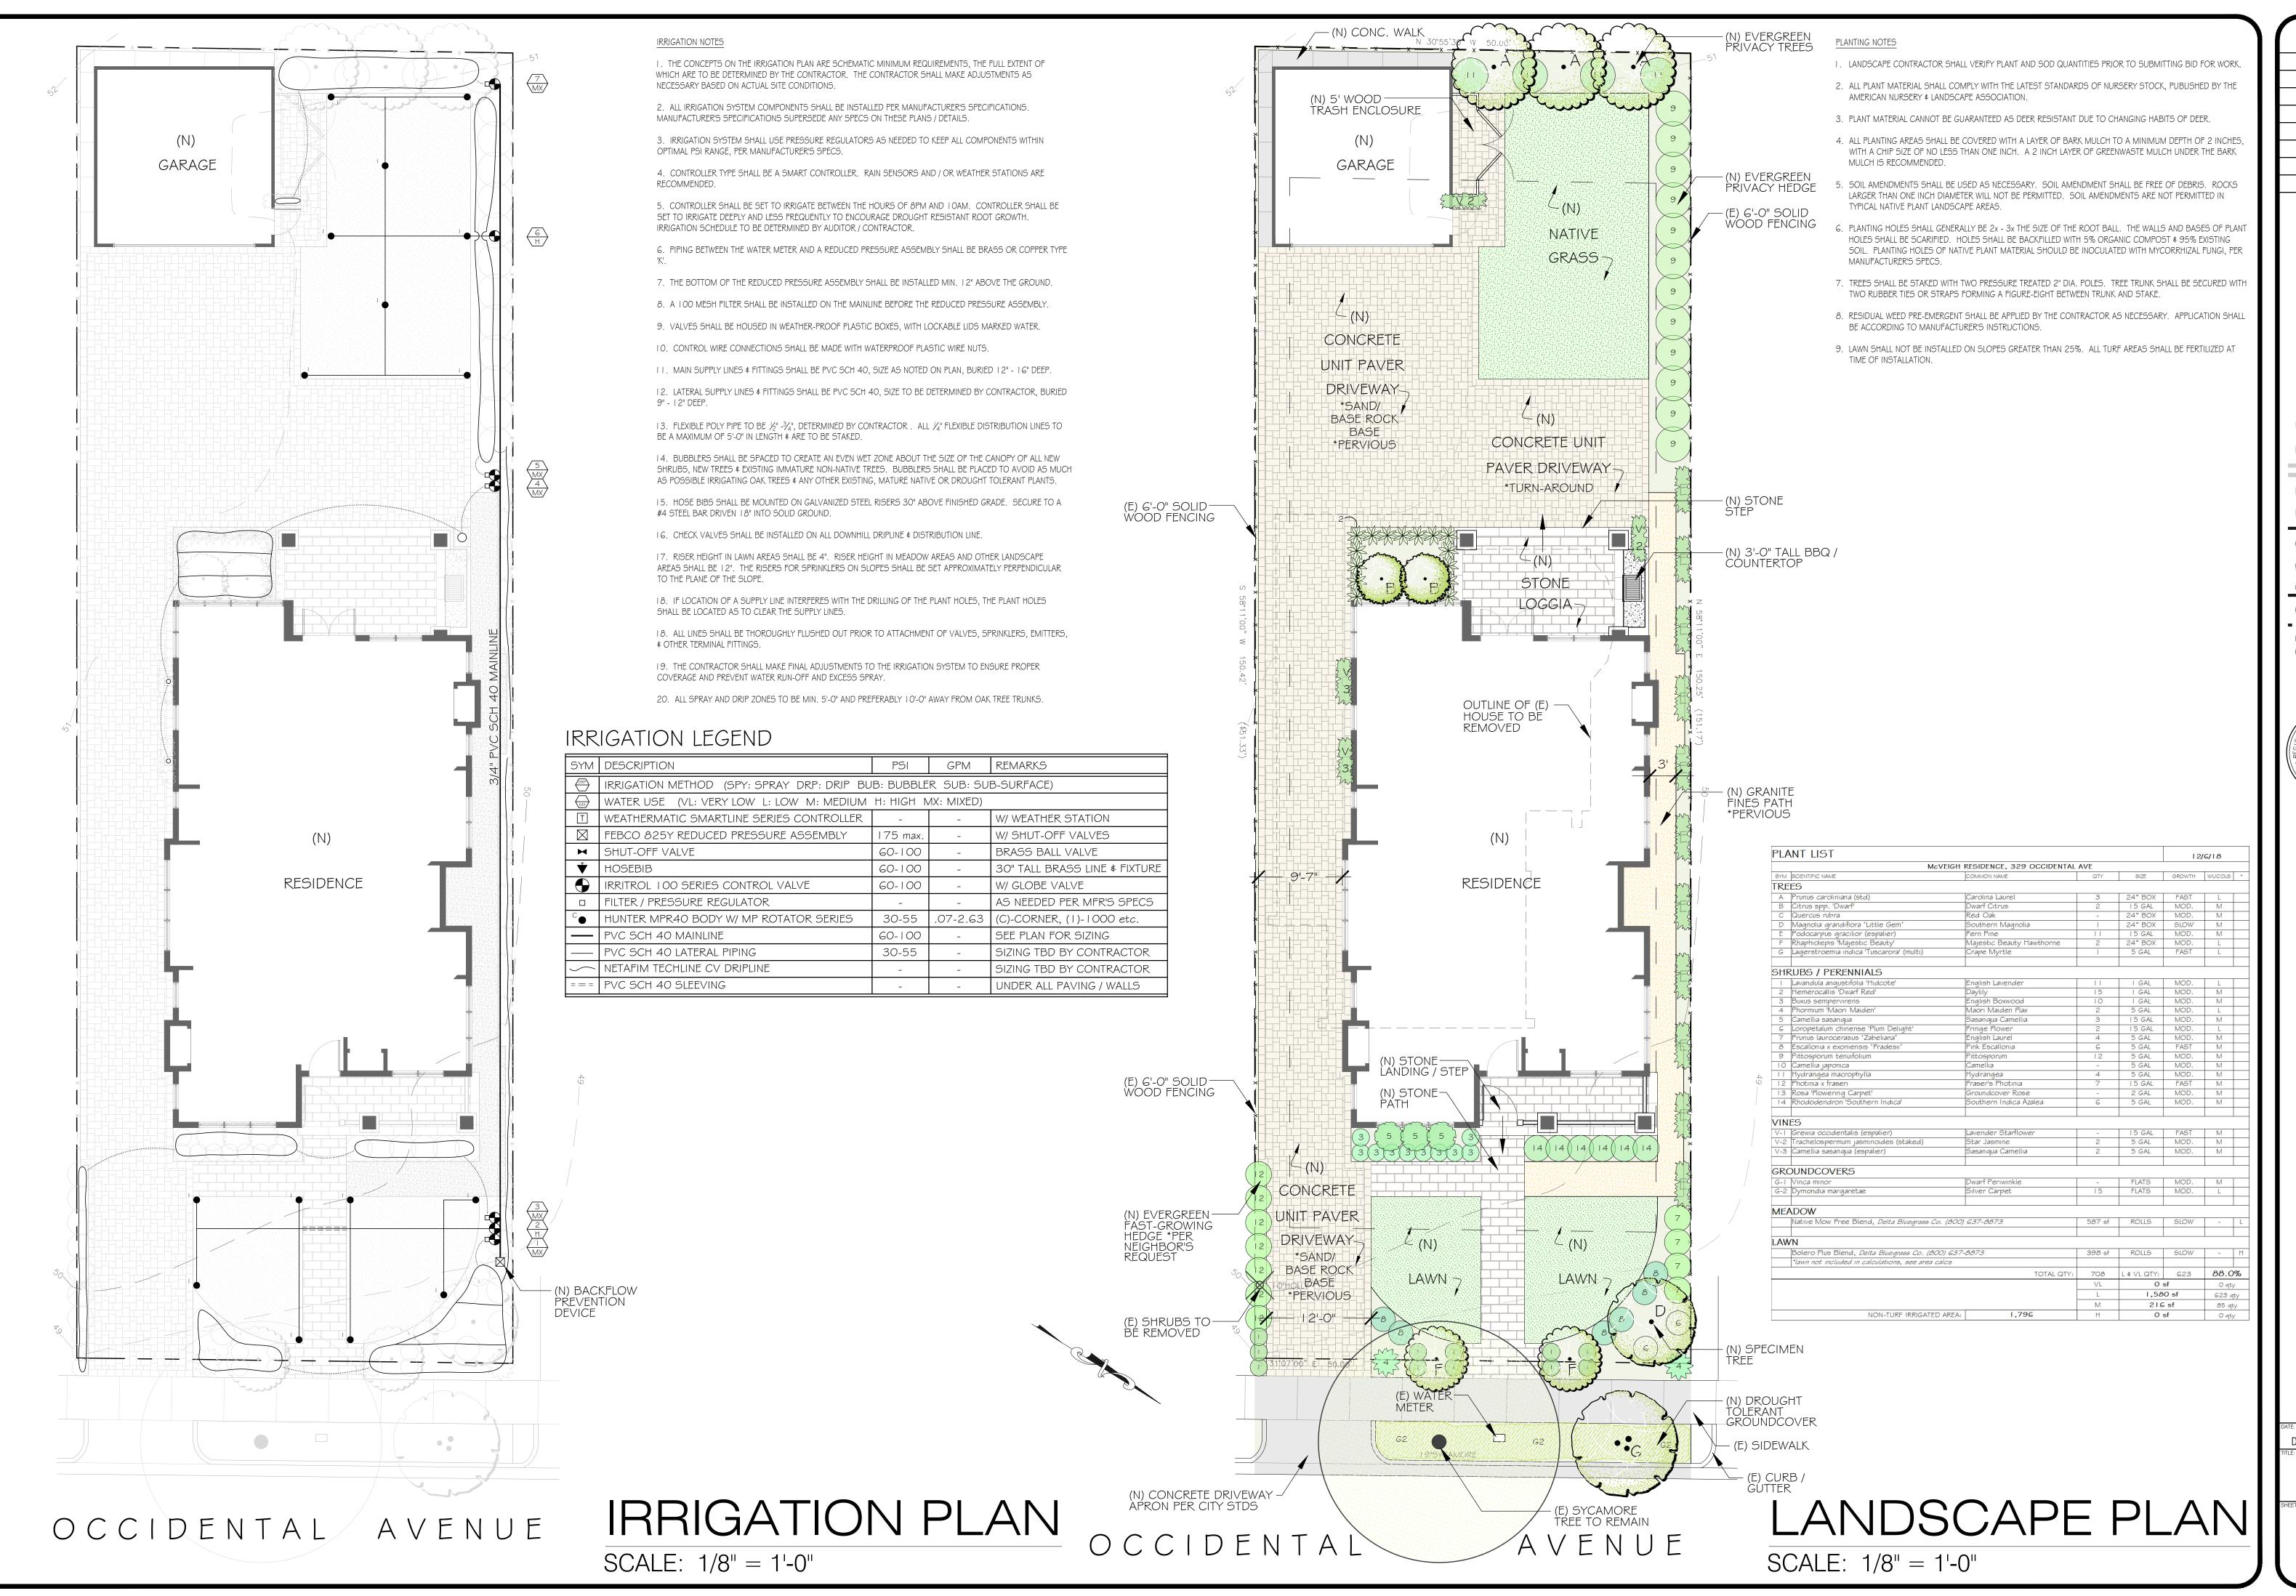

REVISIONS

Bovet Road #314

Mateo, CA 94402

850-372-9220

ax: 650-372-9219

ichaelcallan landscape archit

ANDSCAPE

ANDSCA

CVEIGH RESIDENCE

DECEMBER 6, 2018

LANDSCAPE

L1.0