






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Millbrae
California 94030
415.754.3066



CONSULTANTS

LEEE

LEE RESIDENCE REMODEL
3016 ARGUELLO DR
BURLINGAME, CALIFORNIA 94010
OWNER
JAX LEE AND ANNIE YEOH
3016 Arguello Dr
Burlingame, California 94010


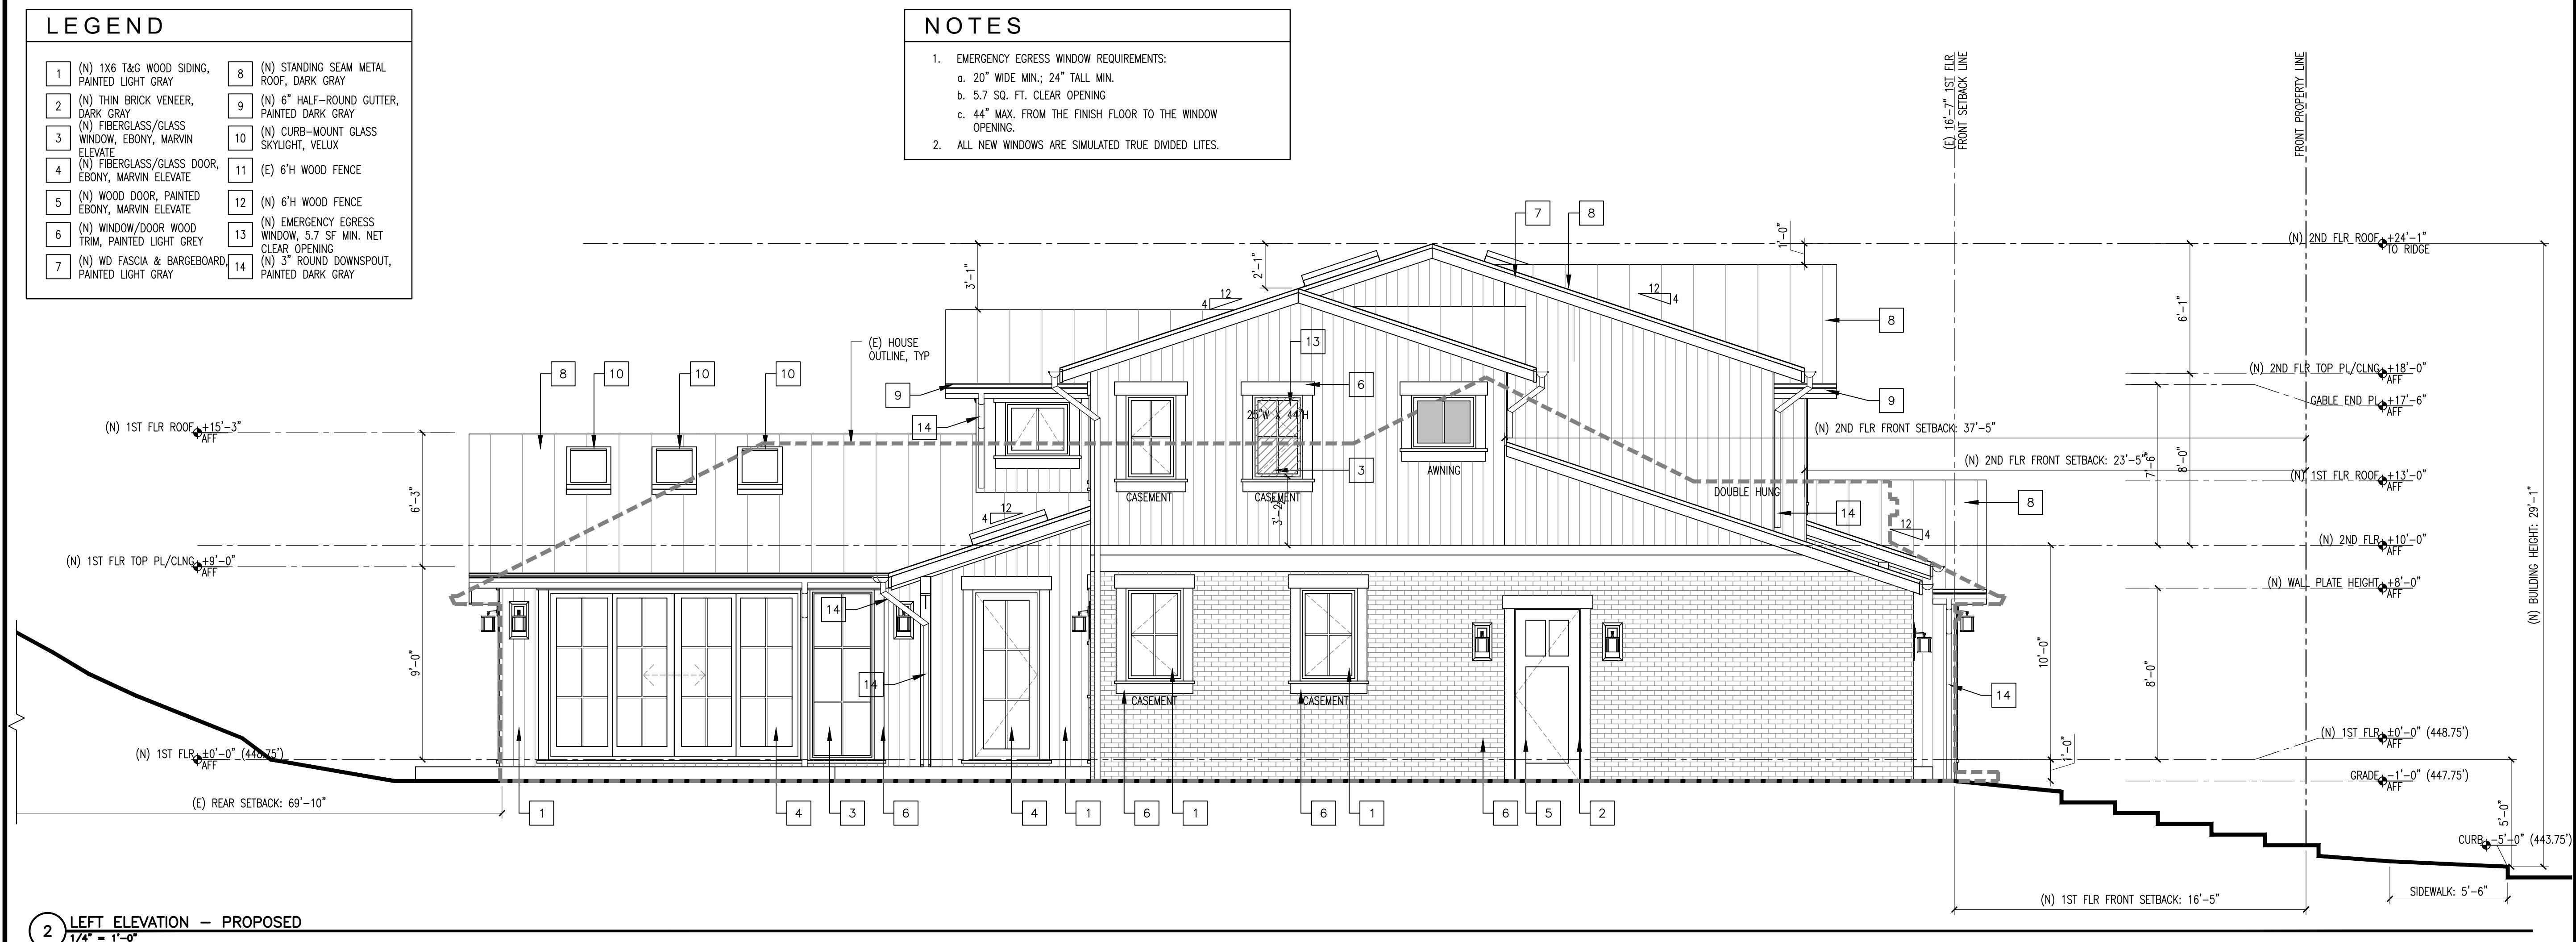


2 LEFT ELEVATION - PROPOSED

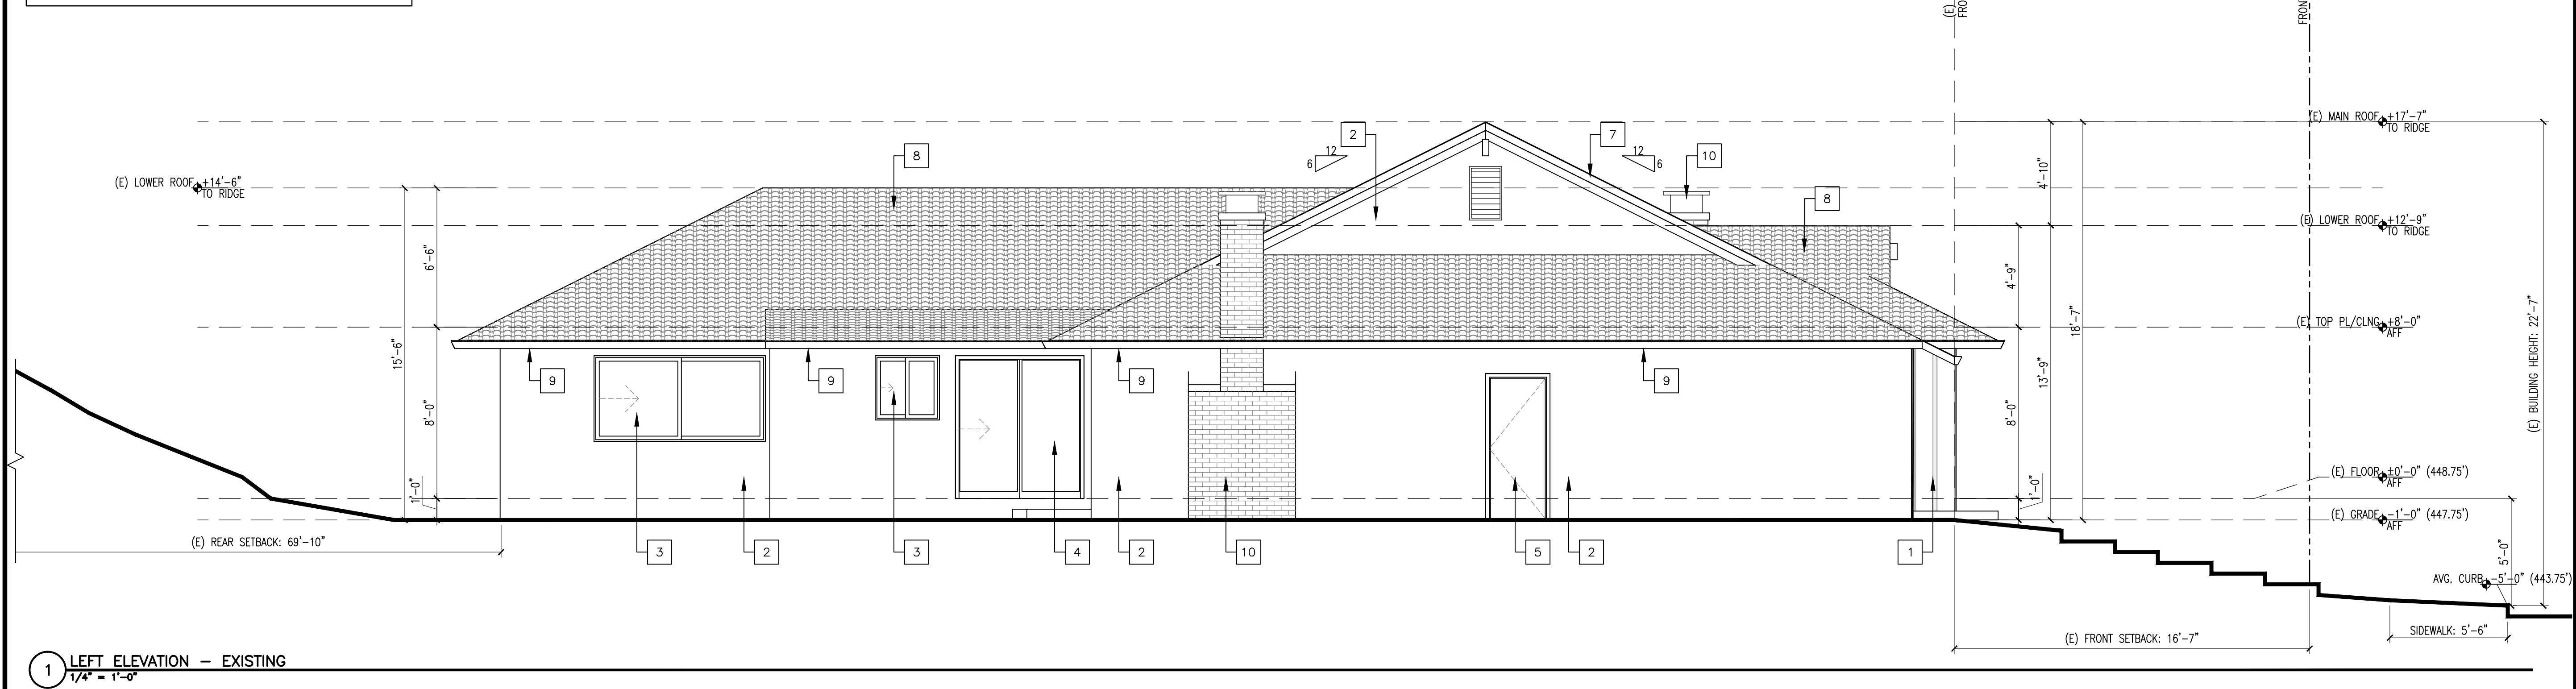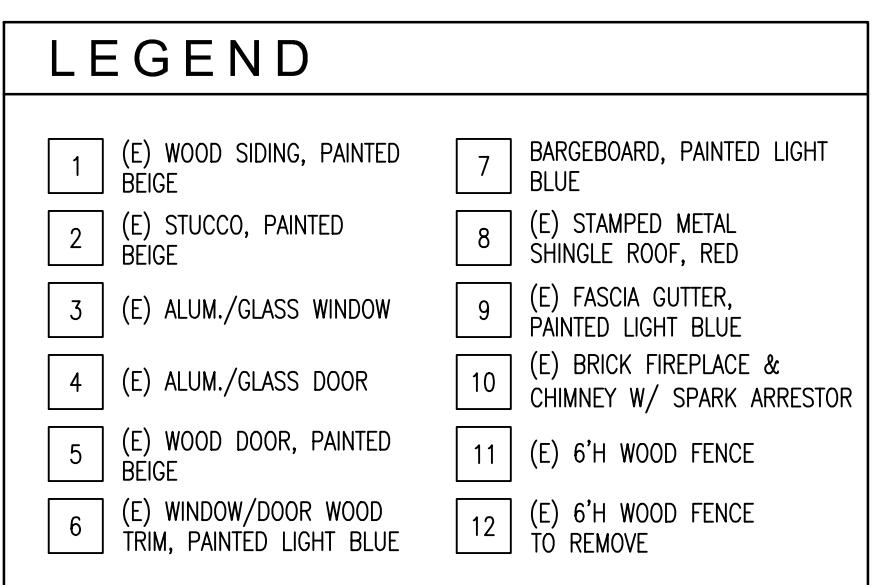

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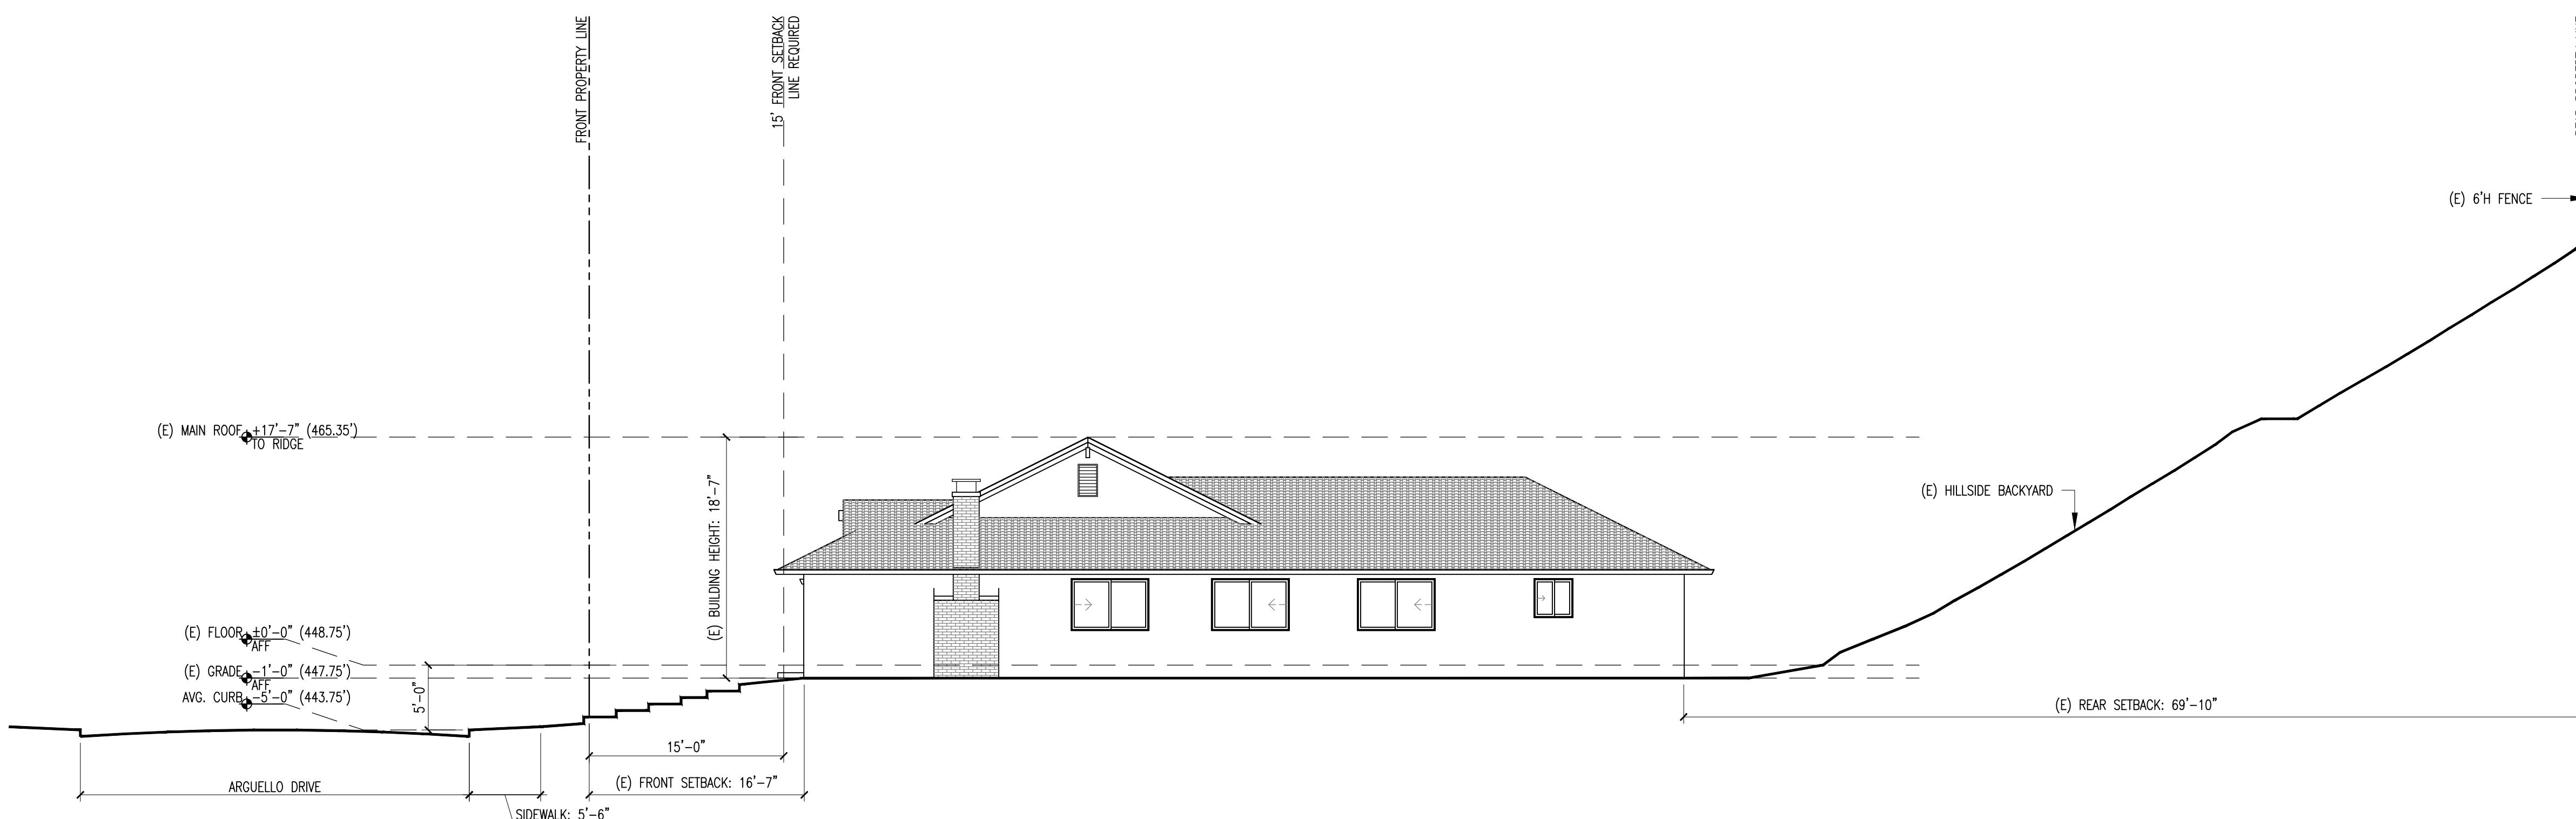
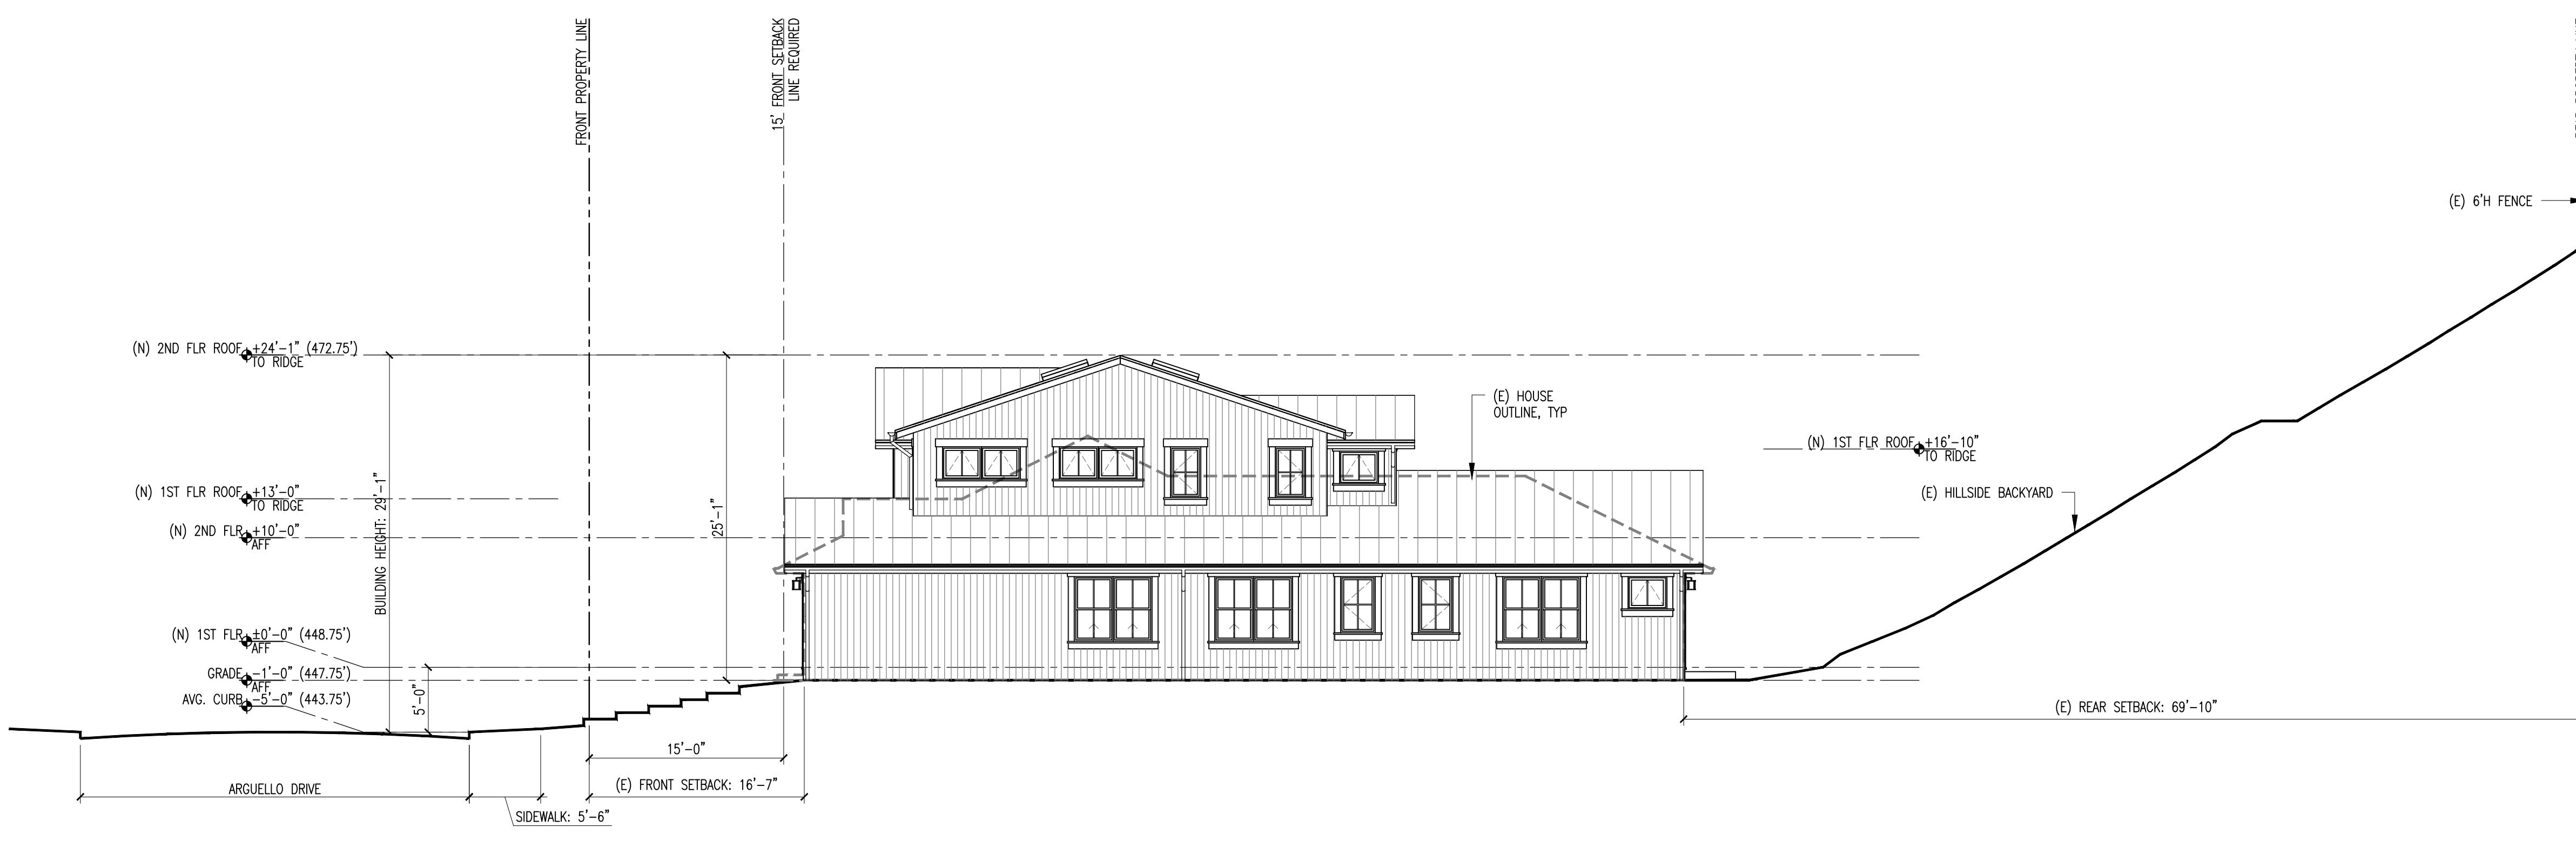
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CONSULTANTS

Comm

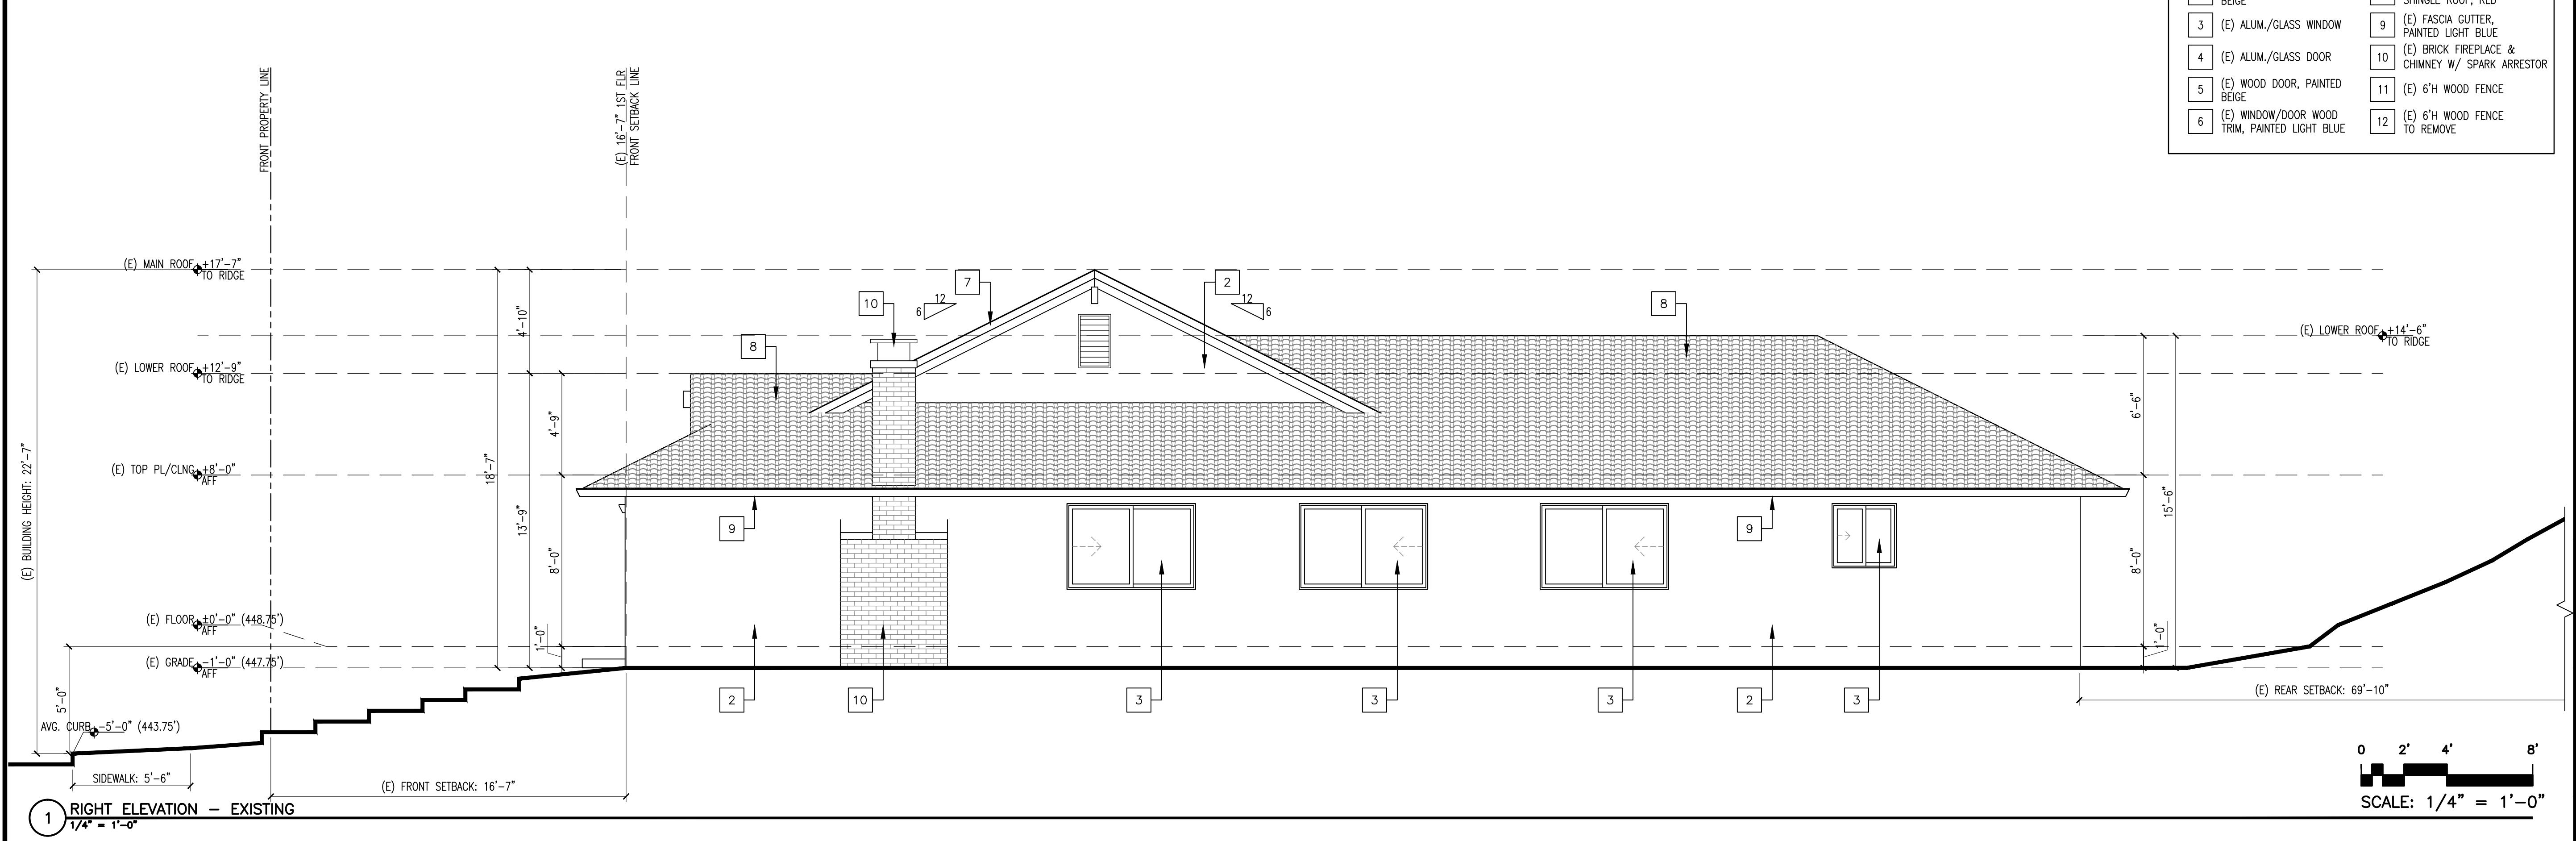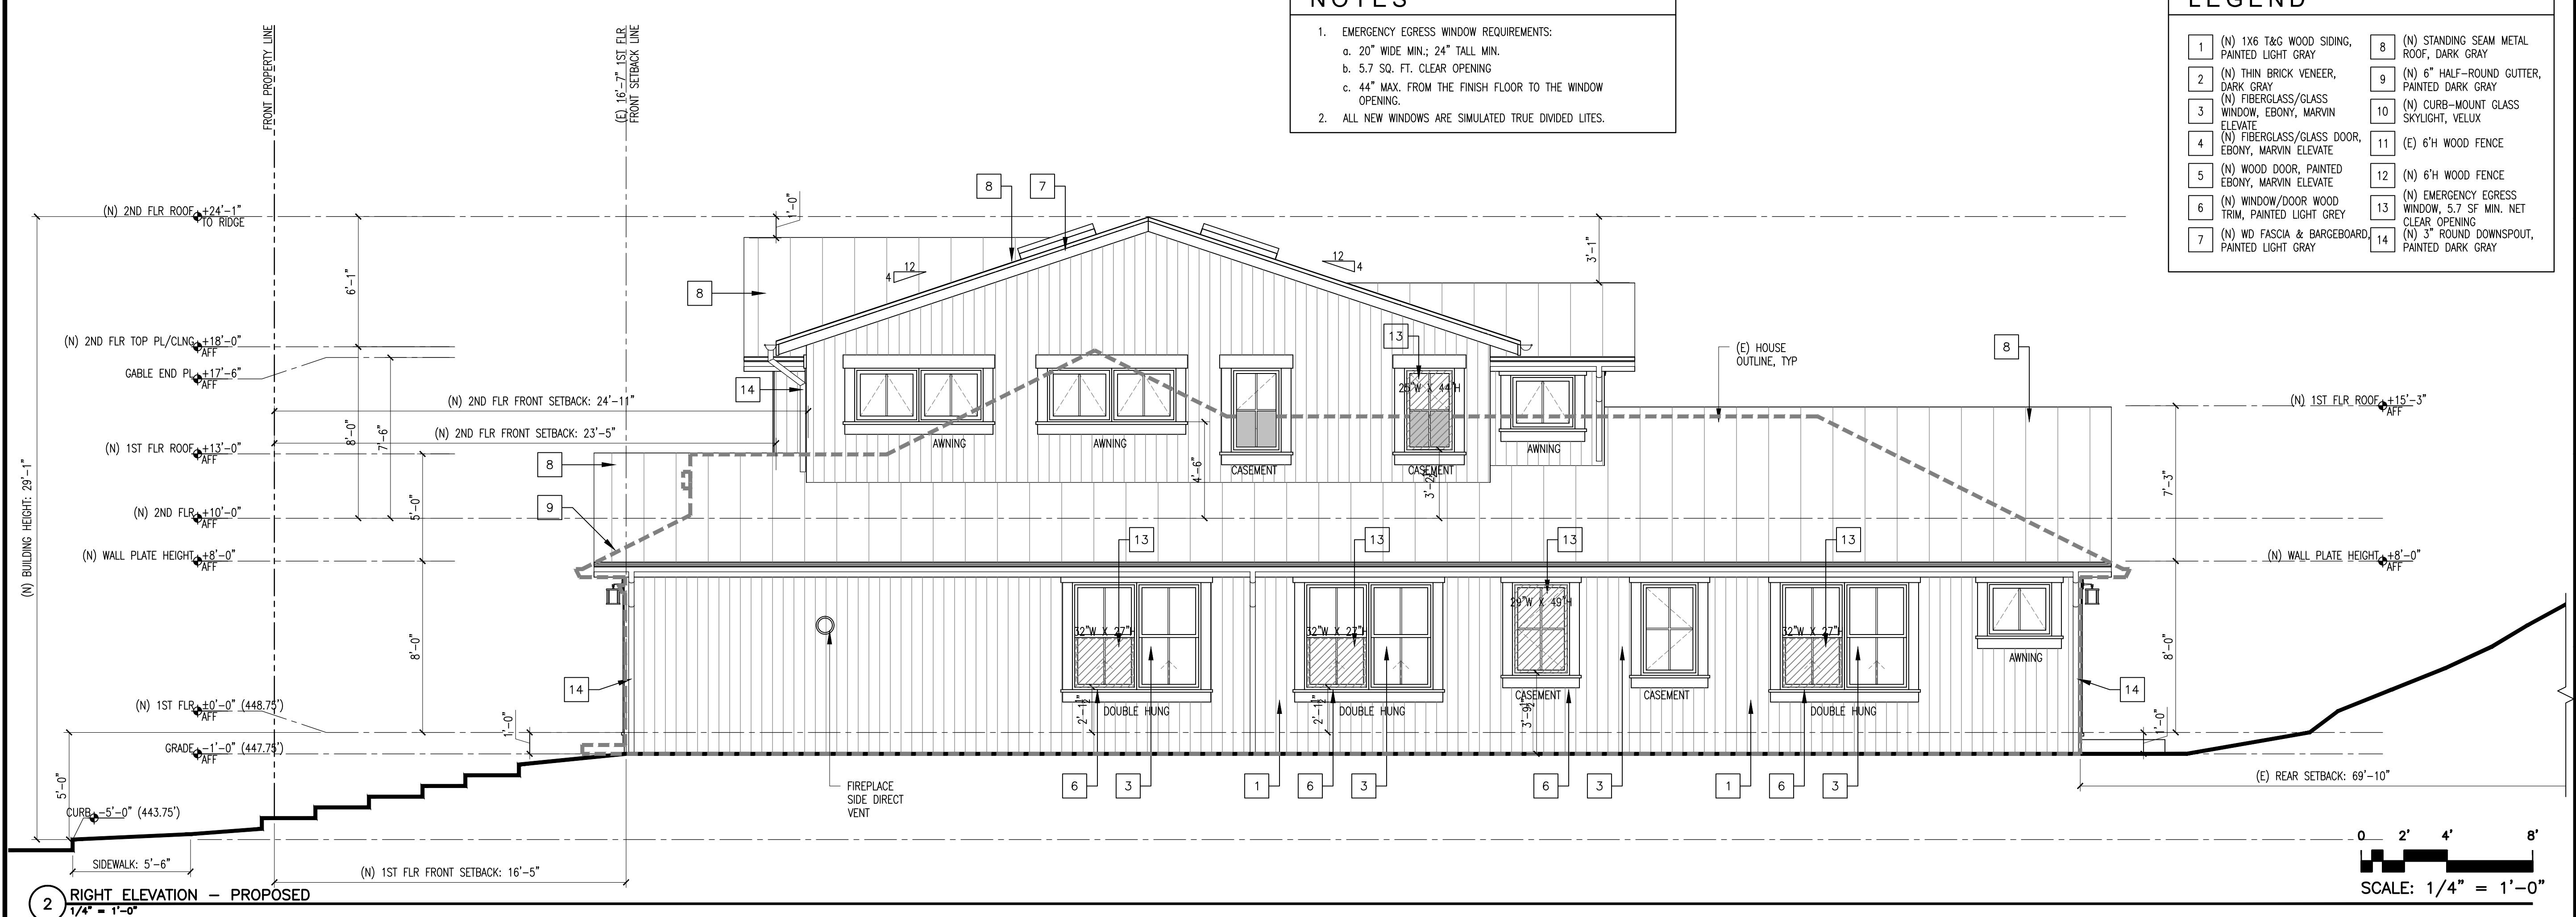LEE RESIDENCE REMODEL
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BURLINGAME, CALIFORNIA 94010
OWNER
JAX LEE AND ANNIE YEOH
3016 Arguello Dr
Burlingame, California 94010

0 4' 8' 16'
SCALE: 1/8" = 1'-0"




08.09.19	DESIGN REVIEW SUBMITTAL	
11.25.19	DESIGN REVIEW RESUBMITTAL	
12.16.19	DESIGN REVIEW RESUBMITTAL	
02.14.20	DESIGN REVIEW RESUBMITTAL	
MARK	DATE	DESCRIPTION
PROJECT NO:	1903	
CAD DWG FILE:	1903-A-301 SITE SECTIONS - EXISTING AND PROPOSED.DWG	
DRAWN BY:	-	
CHK'D BY:	-	
COPYRIGHT:		

SHEET TITLE
SITE SECTIONS - EXISTING
AND PROPOSED

0 4' 8' 16'
SCALE: 1/8" = 1'-0"

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LEE RESIDENCE REMODEL
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09.30.19 DESIGN REVIEW RESUBMITTAL
12.23.19 DESIGN REVIEW RESUBMITTAL
02.14.20 DESIGN REVIEW RESUBMITTAL

MARK DATE DESCRIPTION

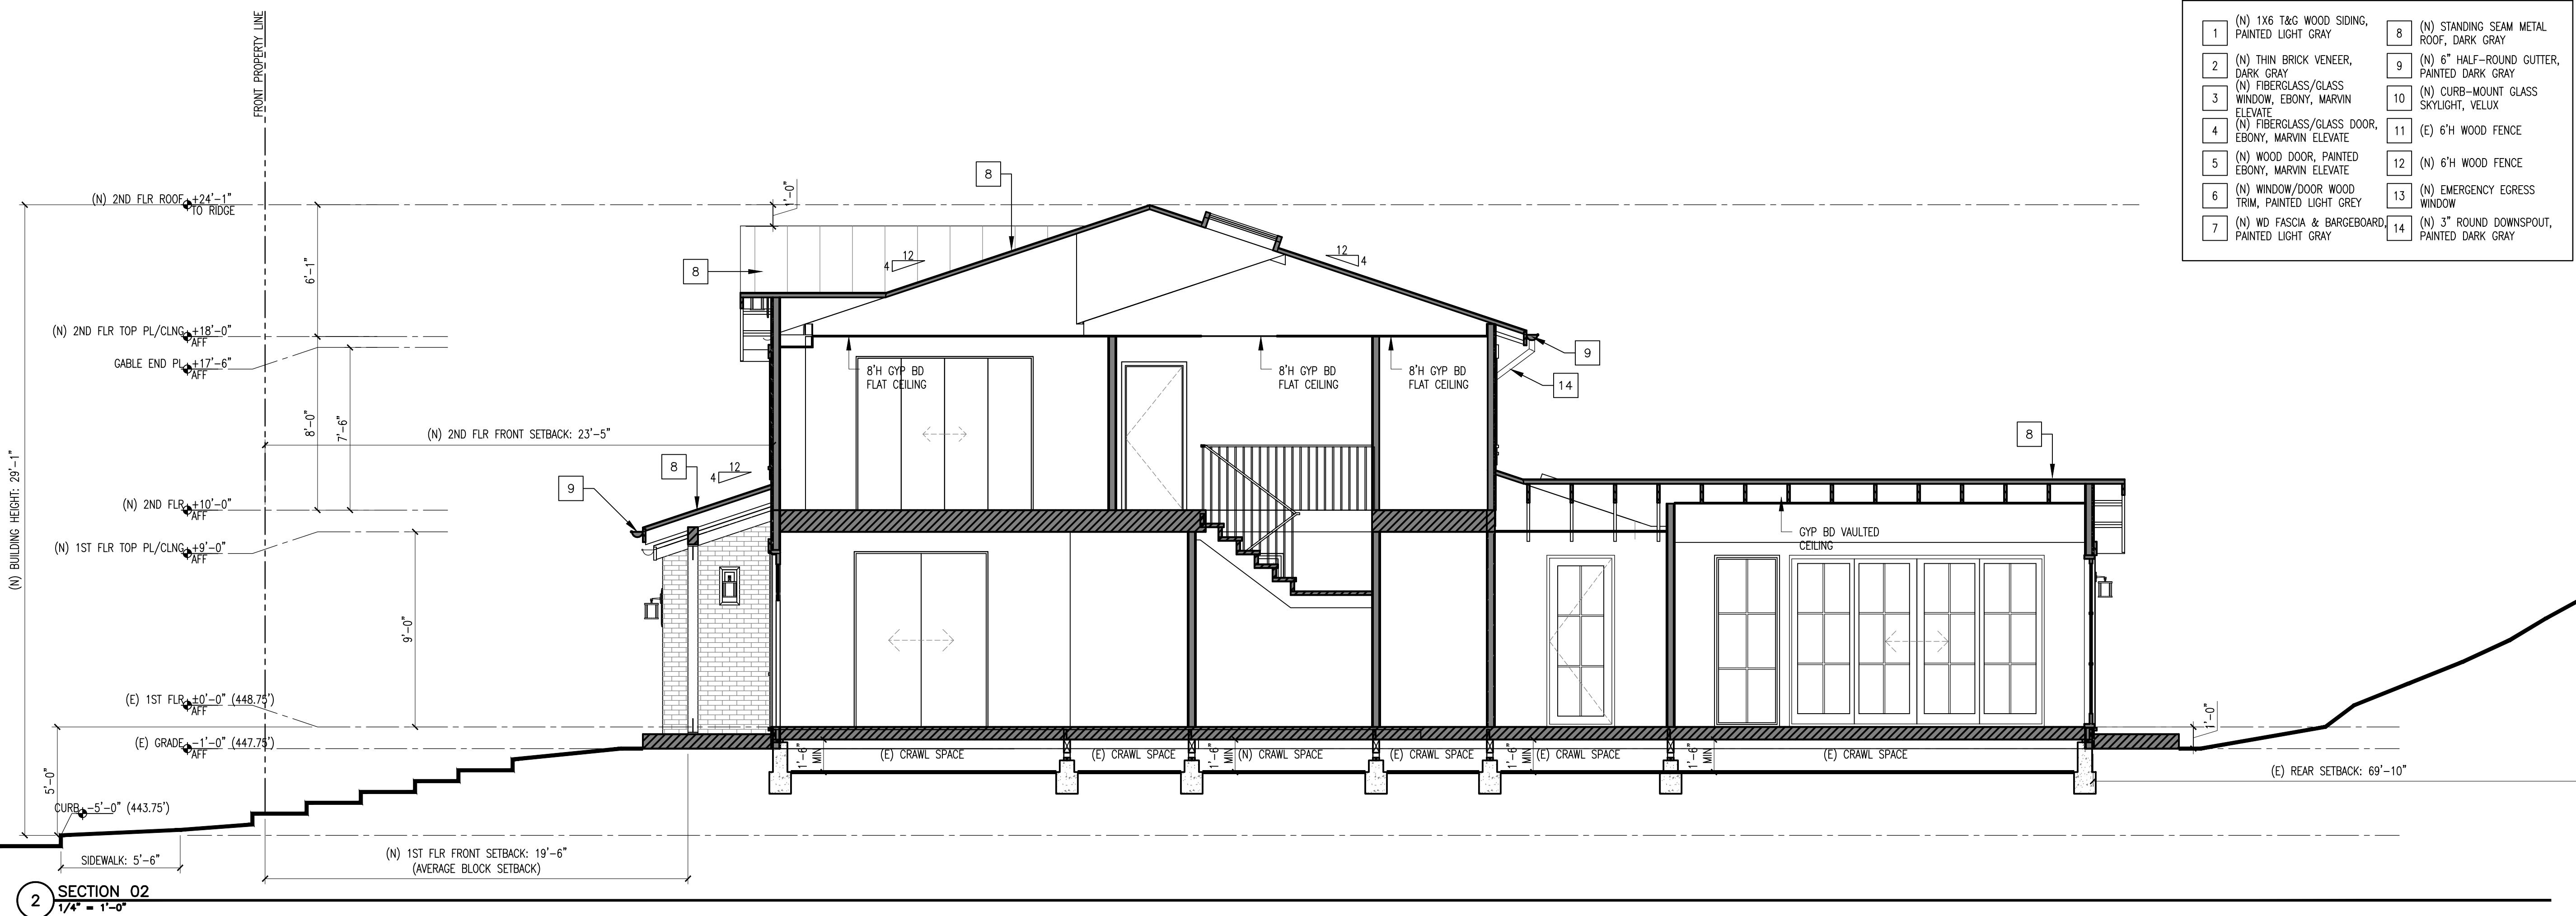PROJECT NO: 1903

CAD DWG FILE: 1903-A-302 BUILDING SECTIONS - PROPOSED.DWG

DRAWN BY: -


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SHEET TITLE

BUILDING SECTIONS - PROPOSED

A-302



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OWNER
JAX LEE AND ANNIE YEOH
3016 Arguello Dr
Burlingame, California 94010


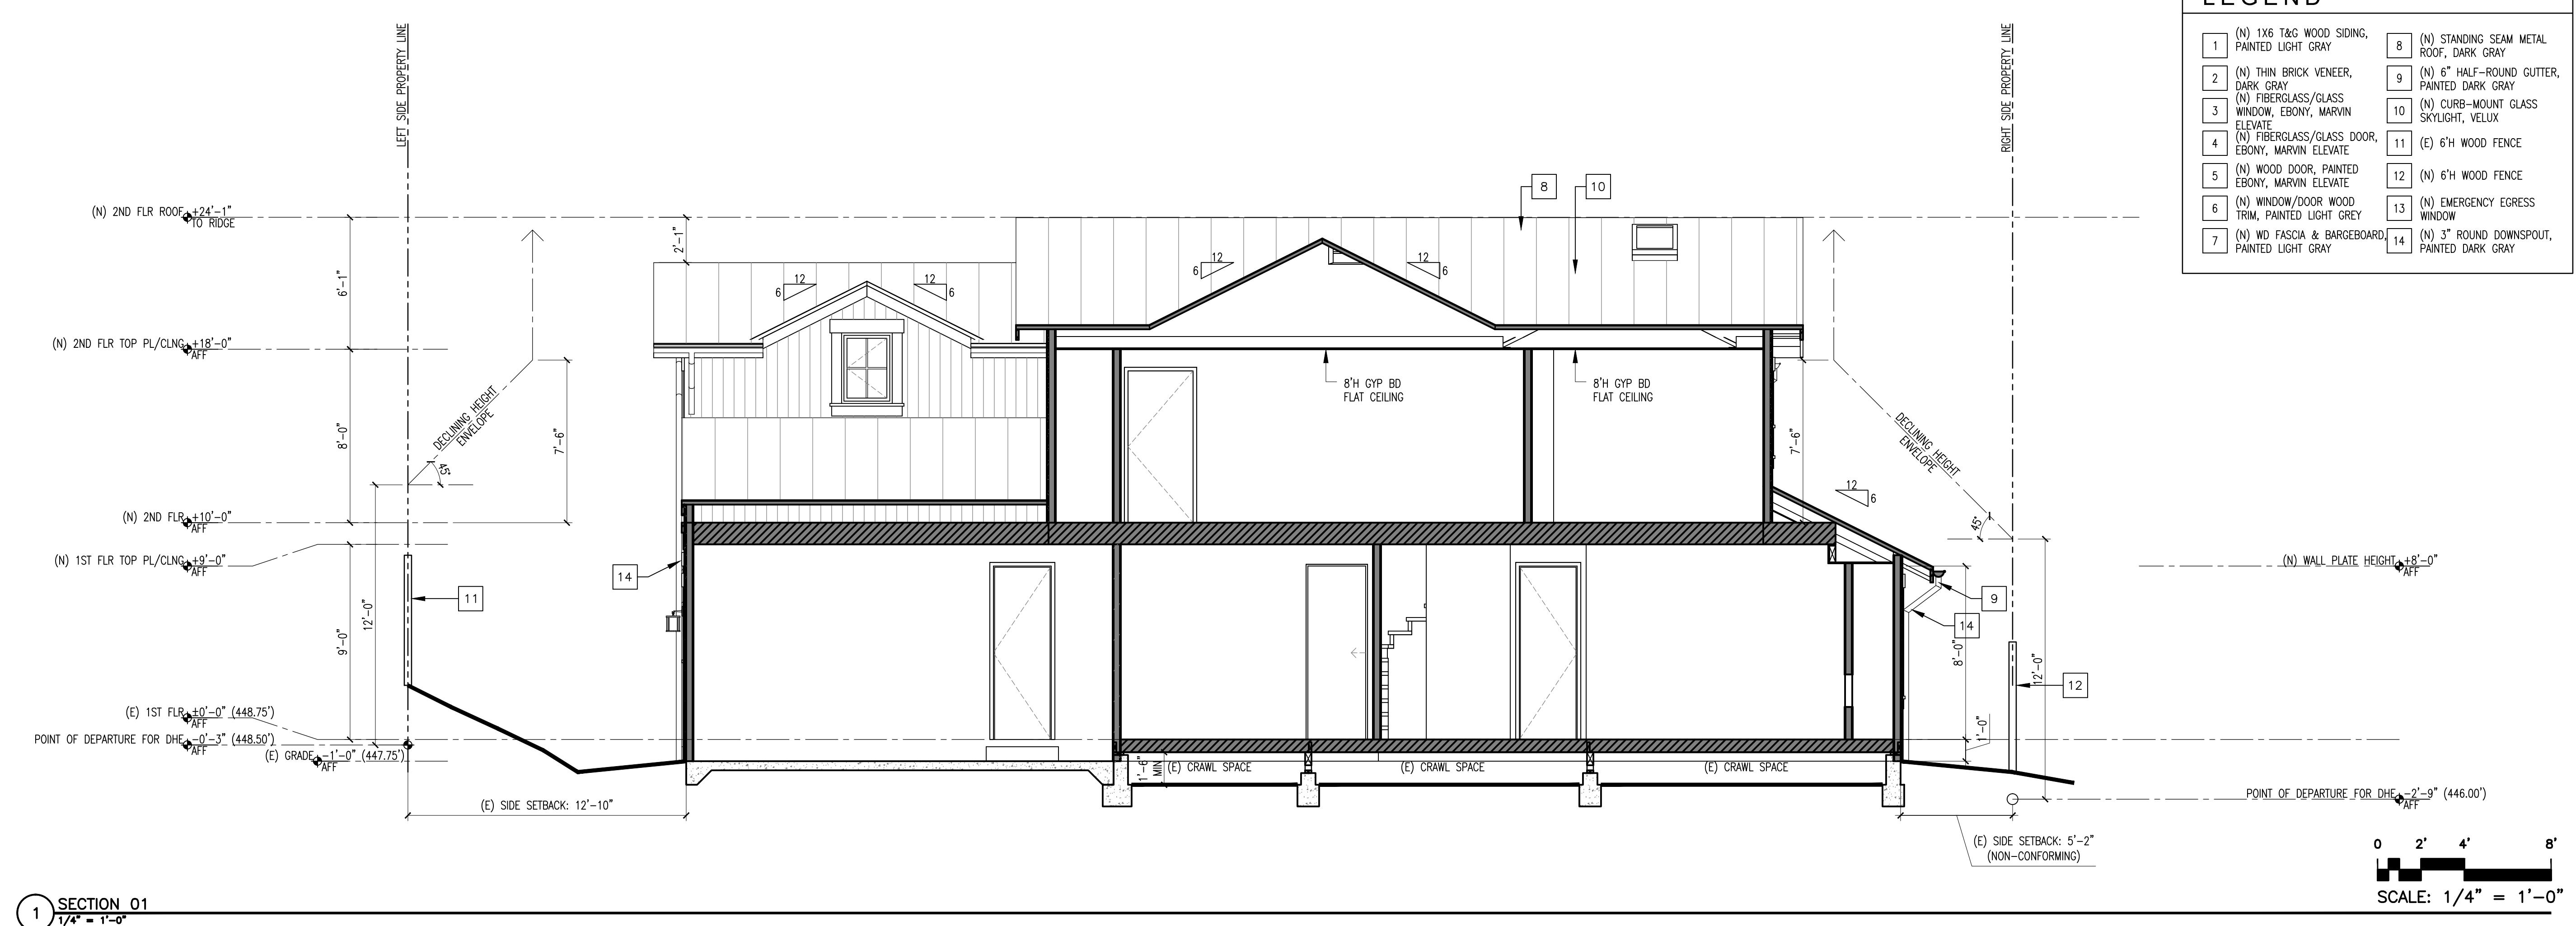
DESIGN STATEMENTS

- ALL WATER WHICH FALLS ON SITE MUST BE TREATED ON SITE.
- WATER USE DESIGN INTENT STATEMENT:
THE PLANTING DESIGN UTILIZES DROUGHT TOLERANT AND LOW WATER USE PLANT MATERIALS IN SUNNY AREAS. SHADE TOLERANT PLANTS ARE UTILIZED UNDER THE TREE. THE PLANTING DESIGN INTENT IS TO COMPLIMENT THE ARCHITECTURE AND PROVIDE A PLEASING OUTDOOR ENVIRONMENT FOR THE OWNERS.
- IRRIGATION USE DESIGN INTENT STATEMENT:
THE IRRIGATION SYSTEM WILL BE A FULLY AUTOMATIC, LOW GALLON USE Drip SYSTEM WITH MATCHED PRECIPITATION RATE HEADS ON EACH CIRCUIT. DIFFERENT HYDROZONES WILL BE ON A SEPARATE VALVE CIRCUIT. THE REMOTE CONTROL VALVES WILL HAVE INTEGRAL PRESSURE REGULATORS TO PREVENT FLUCTUATIONS AND ENSURE CONSTANT APPLICATION RATES TO MINIMIZE OVER OR UNDER WATERING. THE ELECTRONIC IRRIGATION CONTROLLER WILL HAVE MULTIPLE PROGRAMS AND APPLICATION CYCLE/START TIMES. A RAIN SWITCH WILL BE INSTALLED TO PREVENT IRRIGATION DURING RAINY PERIODS. A FLOW SENSOR AND MASTER VALVE WILL BE CONNECTED TO THE CONTROLLER TO ALLOW AUTOMATIC SHUT OFF OF ANY VALVE CIRCUIT OR MAIN LINE IN THE EVENT OF A PIPE BRAKE TO PREVENT WATER WASTE.

PLANTING NOTES

- TREE PLANTING. PRIOR TO IN-GROUND INSTALLATION, URBAN FORESTRY INSPECTION/APPROVAL REQUIRED FOR TREE STOCK, PLANTING CONDITIONS AND IRRIGATION ADEQUACY.
- NO IRRIGATION OR TREE PLANTING PROPOSED IN THE RIGHT-OF-WAY.
- PRIOR TO ANY PLANTING, ALL PLANTABLE AREAS SHALL BE TILLED TO 12" DEPTH, AND ALL CONSTRUCTION RUBBLE AND STONES OVER 1' OR LARGER SHALL BE REMOVED FROM THE SITE.
- PRIOR TO DIGGING, CONTACT UNDERGROUND UTILITY SERVICE ALERT OF NORTHERN CALIFORNIA AT (800) 227-2600.
- REFER TO CITY STANDARD PLANS AND SPECIFICATIONS, WHERE APPLICABLE. IF CITY STANDARDS VARY FROM THESE PLANS CONTACT ARCHITECT FOR RESOLUTION.
- PROVIDE MATCHING FORMS AND SIZES FOR PLANT MATERIAL WITHIN EACH SPECIES AND SIZE DESIGNATED ON PLANS.
- FURNISH PLANT MATERIAL FREE OF PESTS, DISEASE, DAMAGE, OR THOSE FOUND IN POOR CONDITION.
- DO NOT PLANT EDGE OF TREE ROOTBALLS CLOSER THAN 10'-0" TO GAS, WATER OR SEWER LINES OR 2'-0" TO AN ELECTRICAL OR DRAINLINE. IF CONFLICT EXISTS, CONTACT ARCHITECT FOR RESOLUTION.
- DO NOT PLANT EDGE OF TREE ROOTBALLS CLOSER THAN 4'-0" TO HARDSCAPE EDGES SUCH AS SIDEWALKS OR WALLS, UNLESS APPROVED BY ARCHITECT.
- PROVIDE A MINIMUM OF 3" OF MULCH TO SOIL SURFACE AFTER PLANTING. MULCH SHALL NOT BE PLACED WITHIN 12"-0" OF TREE TRUNKS AND SHOULD BE KEPT FREE FROM THE CROWN OF ALL SHRUBS, GRASSES AND PERENNIALS.
- NO EXISTING TREE TO BE REMOVED.
- NEW TREES ARE MINIMUM 24" BOX SIZE.

LEGEND

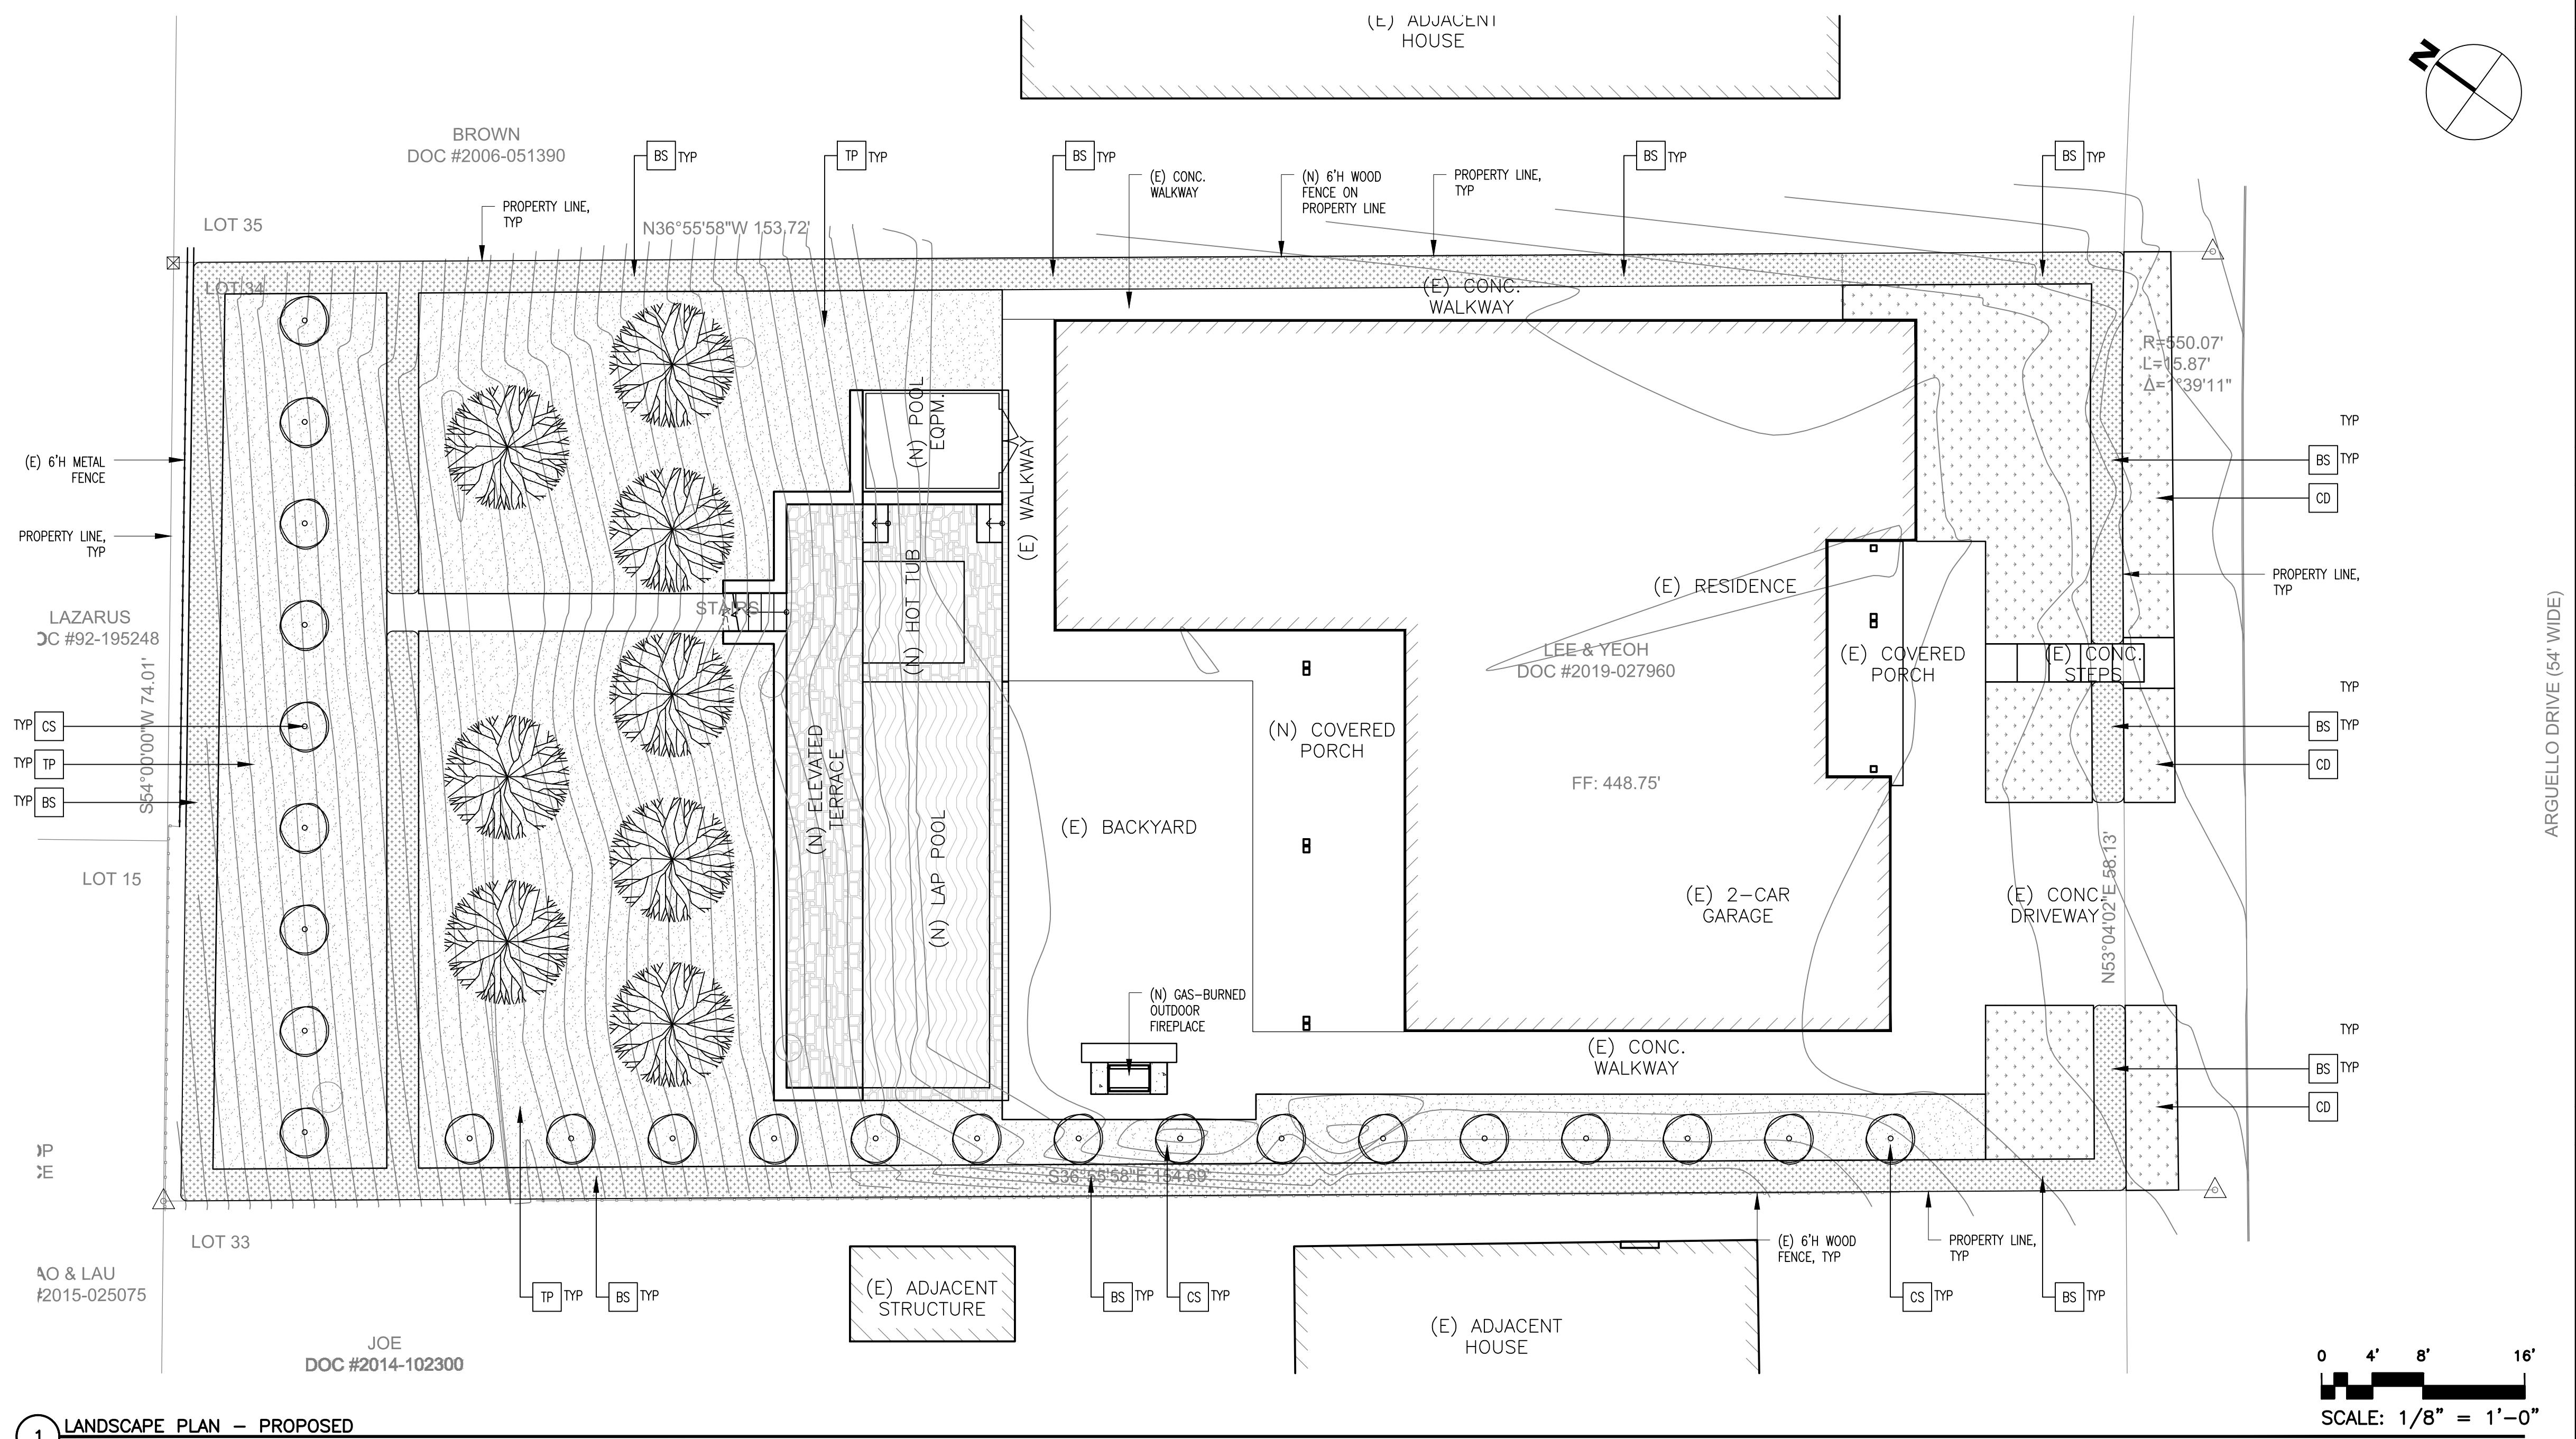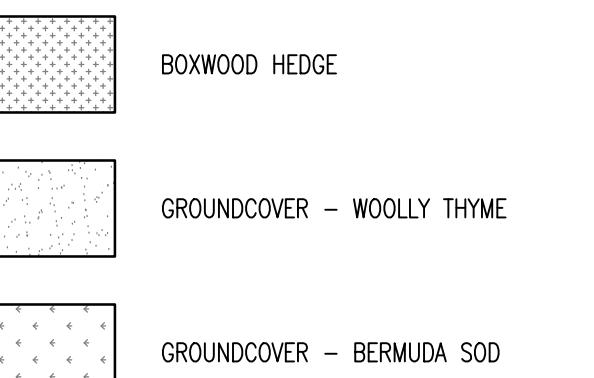

1 LANDSCAPE PLAN - PROPOSED

LANDSCAPE		HARDSCAPE	
ACER RUBRUM RED MAPLE	CUPRESSUS SEMPERVIRENS ITALIAN CYPRESS	LAP POOL	SEALED-GAS-BURNED FIREPLACE
BUXUS SEMPERVIRENS BOXWOOD HEDGE			
CYNODON DACTYLON BERMUDA SOD	THYMUS PSEUDOLANUGINOSUS WOOLLY THYME		

PLANTING SCHEDULE

PLANT ID	BOTANICAL NAME	QTY.	COMMON NAME	FINAL SIZE		ORDER SIZE	COLOR	NOTES
				HEIGHT	WIDTH			
TREES								
AP	ACER RUBRUM	8	RED MAPLE	12'-0"	12'-0"	24" BOX	GREEN/RED	
CS	CUPRESSUS SEMPERVIRENS	24	ITALIAN CYPRESS	12'-0"	3'-0"	24" BOX	GREEN	
PLANTS								
BS	BUXUS SEMPERVIRENS	-	BOXWOOD HEDGE	3'-0"	2'-6"	5 GAL	GREEN/RED	
GROUNDCOVER								
CD	CYNODON DACTYLON	2	BERMUDA SOD	0'-6"	-	1-PALLET	GREEN	
TP	THYMUS PSEUDOLANUGINOSUS	-	WOOLLY THYME	0'-6"	1'-0"	1 GAL	GRAY-GREEN	

08.09.19 DESIGN REVIEW SUBMITAL
09.30.19 DESIGN REVIEW RESUBMITAL
10.25.19 DESIGN REVIEW RESUBMITAL
12.23.19 DESIGN REVIEW RESUBMITAL
02.14.20 DESIGN REVIEW RESUBMITAL

MARK DATE DESCRIPTION

PROJECT NO: 1903
CAD DWG FILE: 1903-L-101 LANDSCAPE PLAN - PROPOSED.DWG

DRAWN BY: -

CHK'D BY: -


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LANDSCAPE PLAN - PROPOSED

L-101
SHEET - OF -


GENERAL NOTES

- ALL WORK IS TO BE DONE IN ACCORDANCE WITH THE STANDARD PLANS AND SPECIFICATIONS OF THE CITY OF BURLINGAME.
- THE ENGINEER OF RECORD SHALL BE CONTACTED FOR ANY DESIGN REVISIONS PRIOR TO CONSTRUCTION.
- ALL PAVED SURFACES SHALL HAVE MINIMUM SLOPE OF 0.5% SLOPE. ALL DRAIN PIPES SHALL HAVE 1.0% SLOPE MINIMUM.




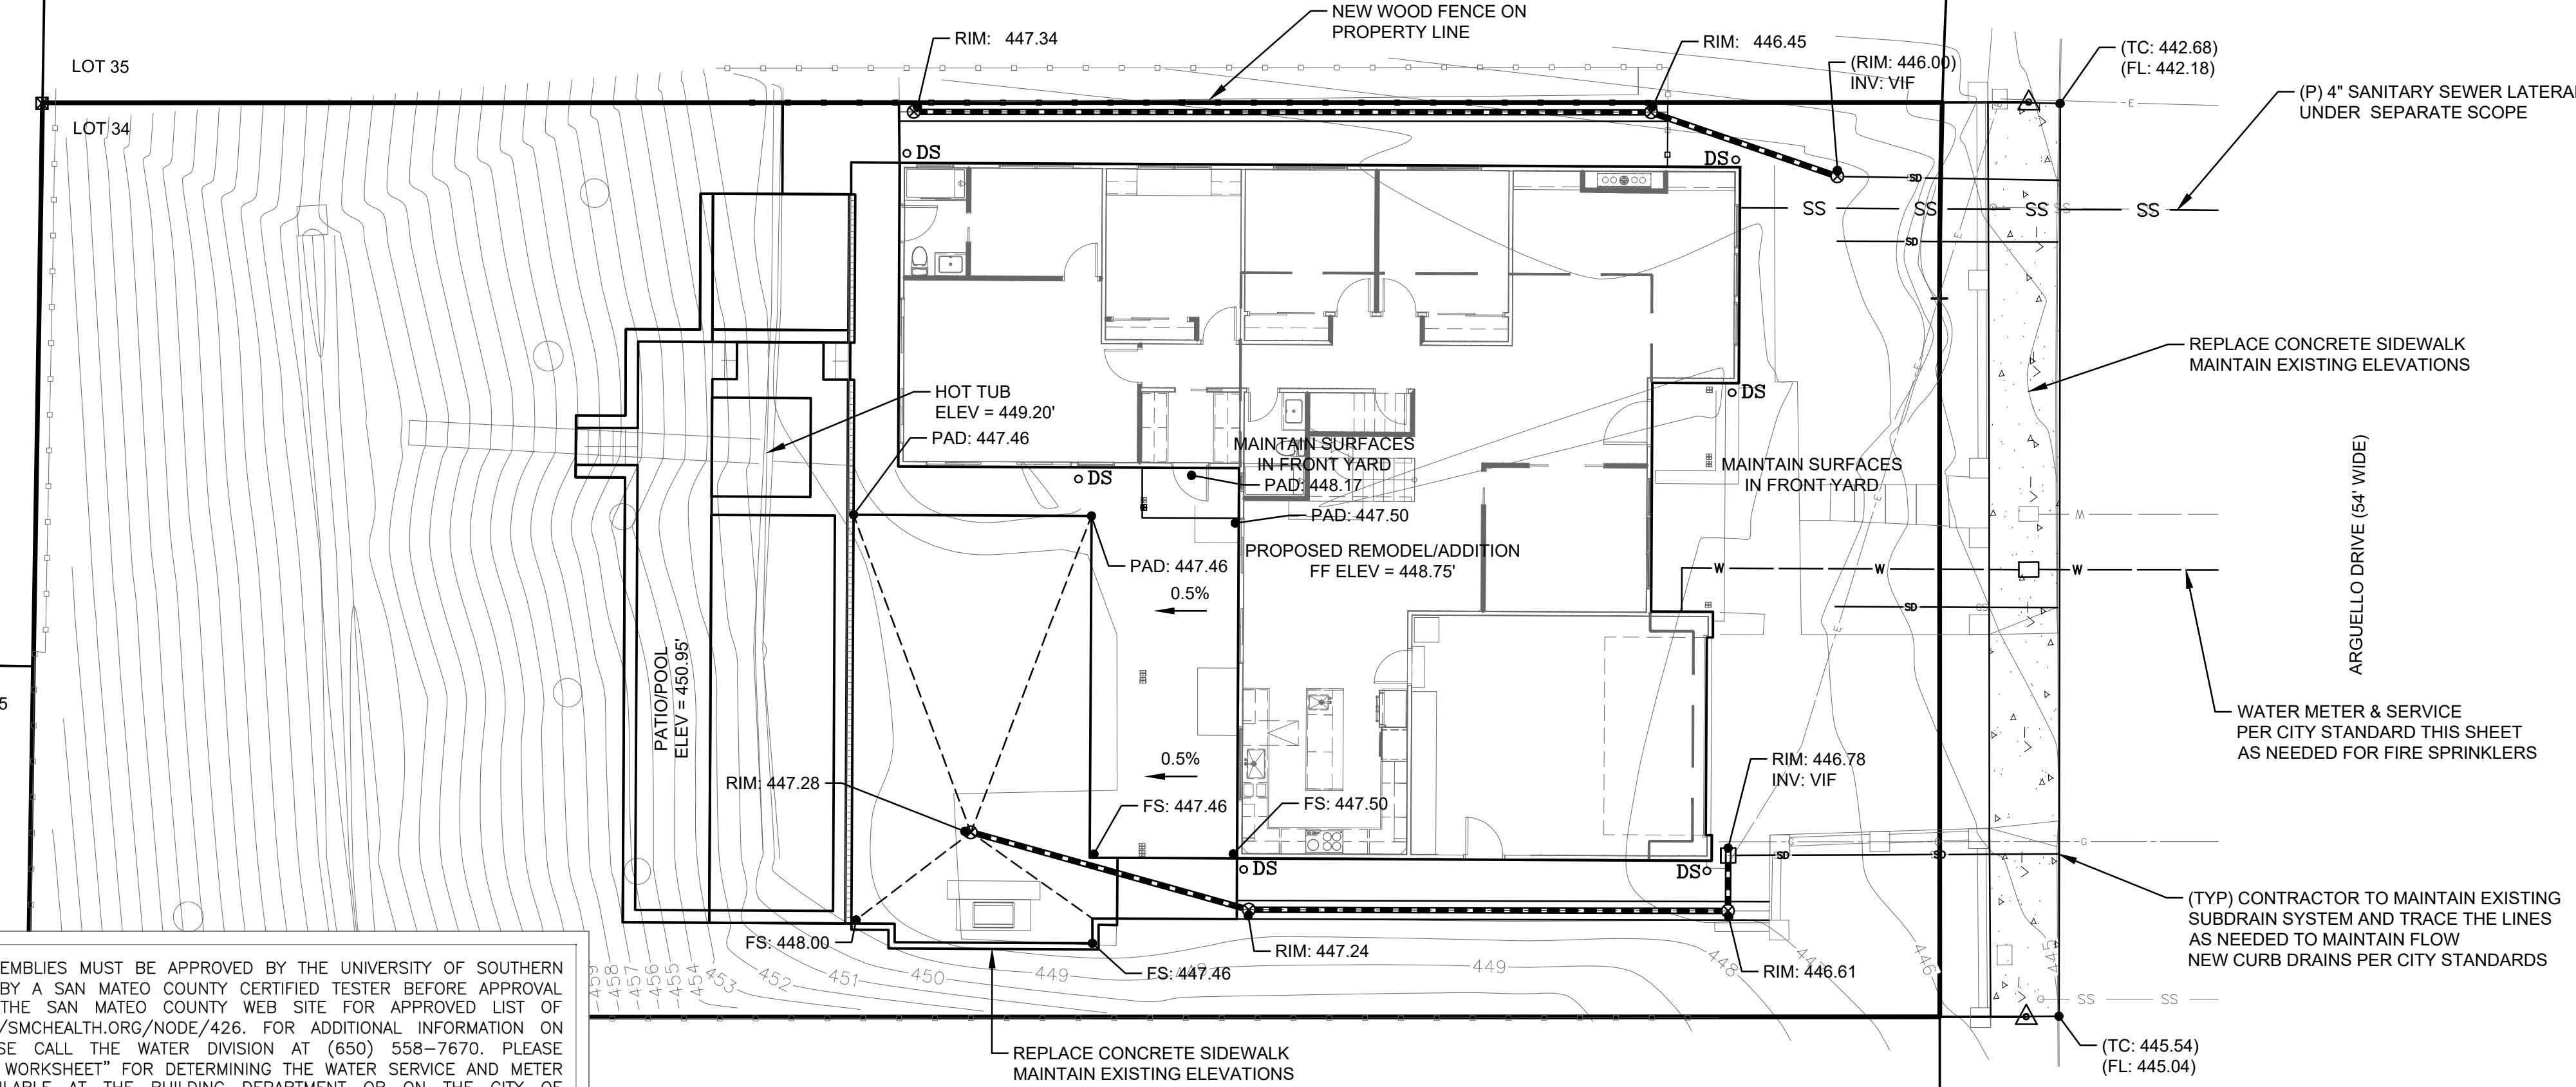


ALL BACKFLOW PREVENTION ASSEMBLIES MUST BE APPROVED BY THE UNIVERSITY OF SOUTHERN CALIFORNIA (USC) AND TESTED BY A SAN MATEO COUNTY CERTIFIED TESTER BEFORE APPROVAL OF THE WATER SYSTEM. SEE THE SAN MATEO COUNTY WEB SITE FOR APPROVED LIST OF CERTIFIED TESTER'S AT [HTTP://SMCHEALTH.ORG/NODE/426](http://SMCHEALTH.ORG/NODE/426). FOR ADDITIONAL INFORMATION ON USC APPROVED DEVICES PLEASE CALL THE WATER DIVISION AT (650) 558-7670. PLEASE COMPLETE THE "WATER DEMAND WORKSHEET" FOR DETERMINING THE WATER SERVICE AND METER SIZE. THE WORKSHEET IS AVAILABLE AT THE BUILDING DEPARTMENT OR ON THE CITY OF BURLINGAME WEB SITE AT [HTTP://WWW.BURLINGAME.ORG/INDEX.ASPX?PAGE=125](http://WWW.BURLINGAME.ORG/INDEX.ASPX?PAGE=125).

ADDRESS: _____

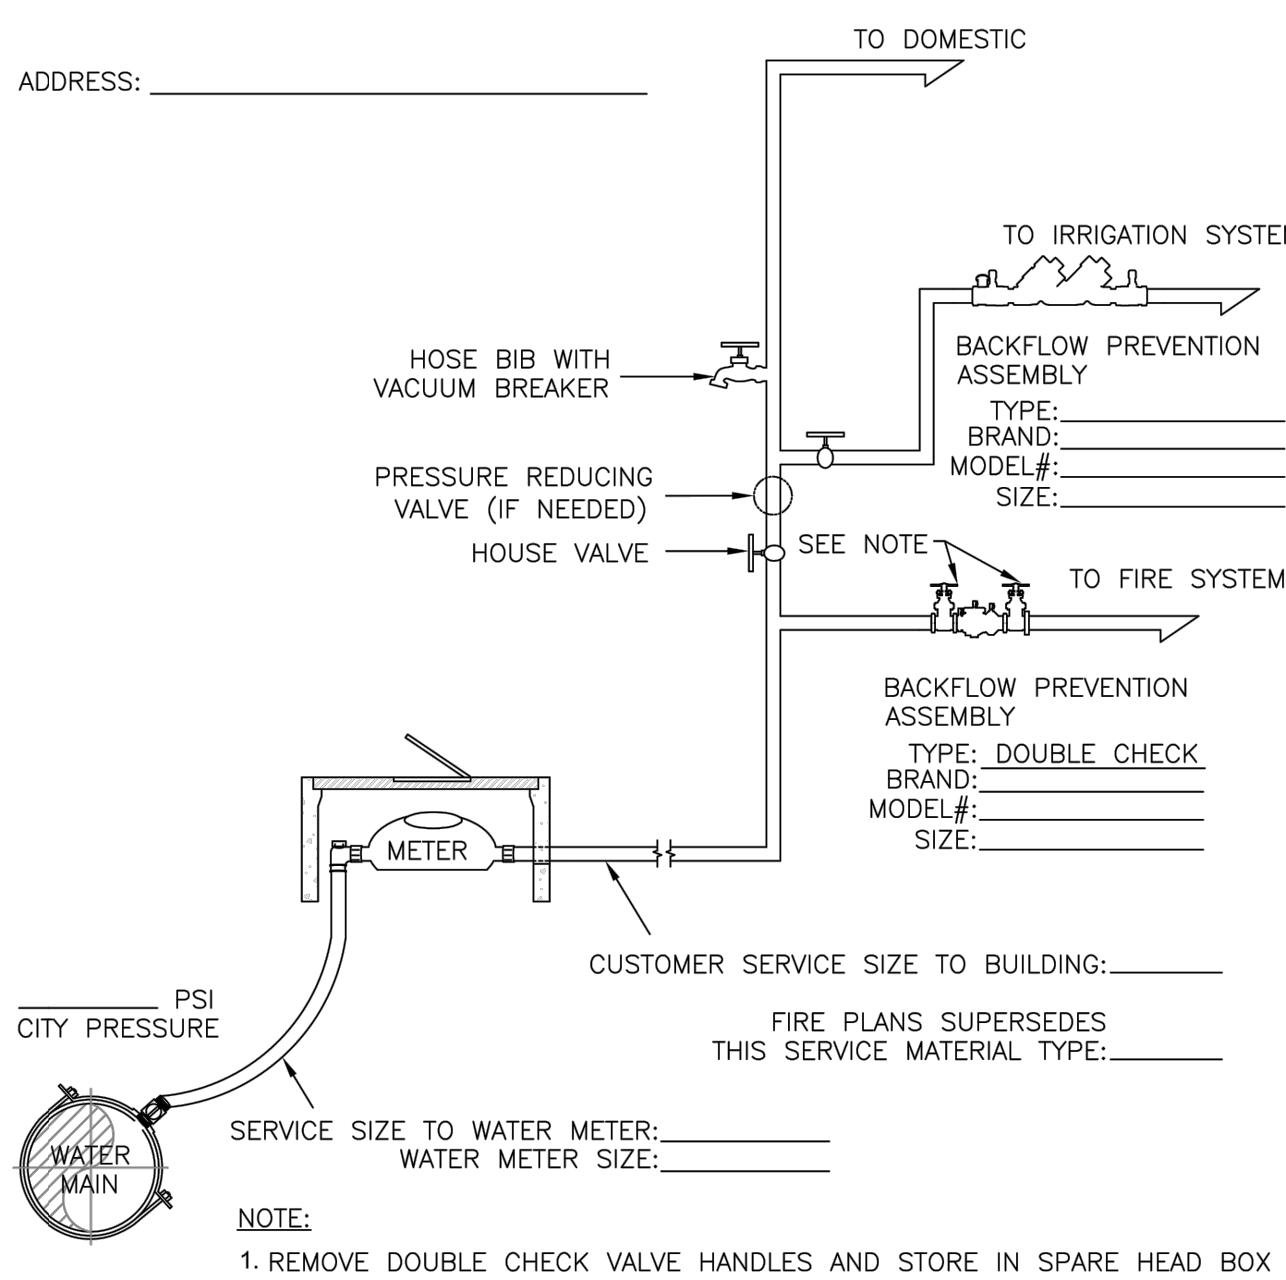

TYPICAL RESIDENTIAL WATER SERVICE DETAIL (WITH FIRE SYSTEM)		DATE	DRAWING NO.
DEPARTMENT OF PUBLIC WORKS		NOV 2012	W-1780
DRAWN BY: L.T.	CHECKED BY: K.O.	SCALE: NONE	SHEET 1 OF 1
REVISION BY: APPR. APPROVED BY:			

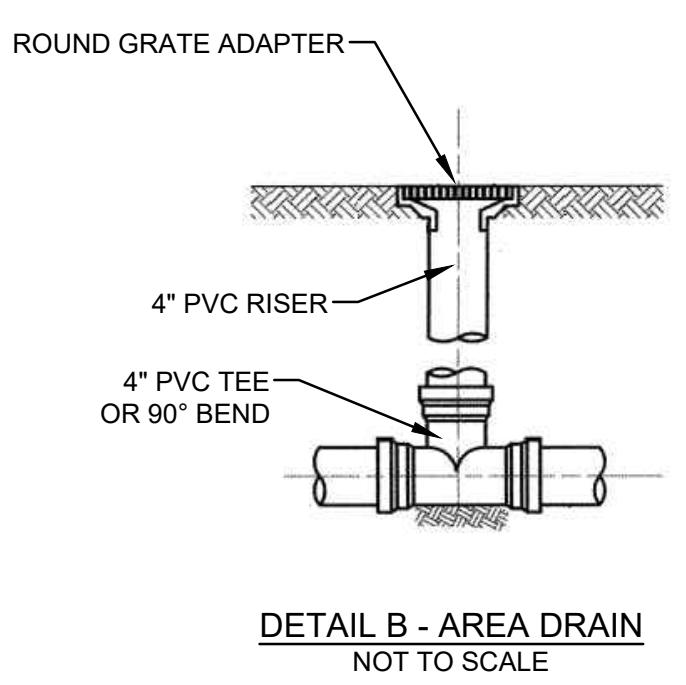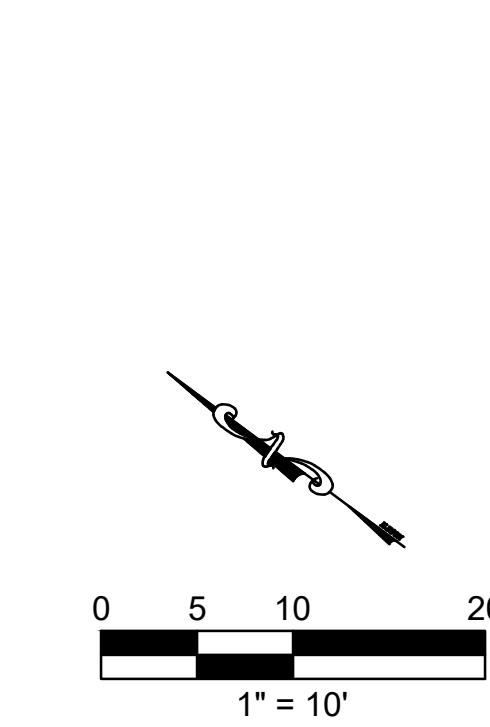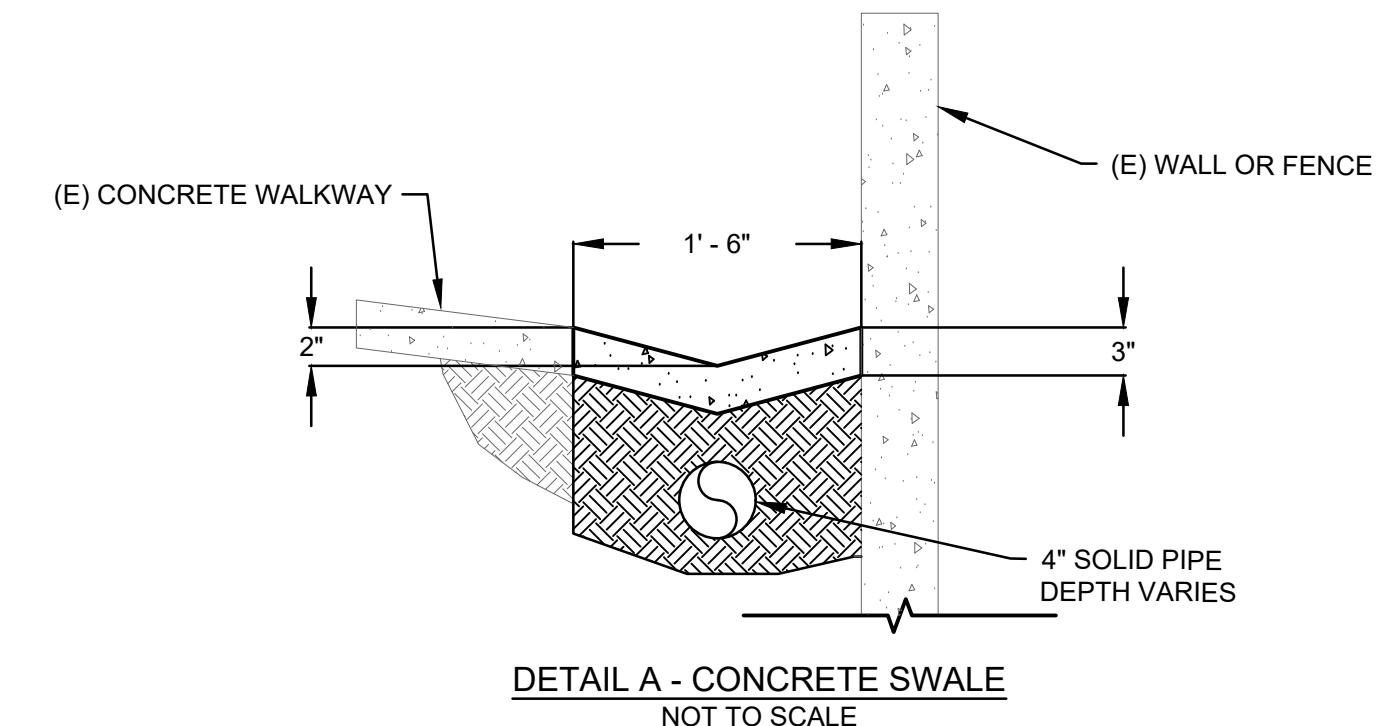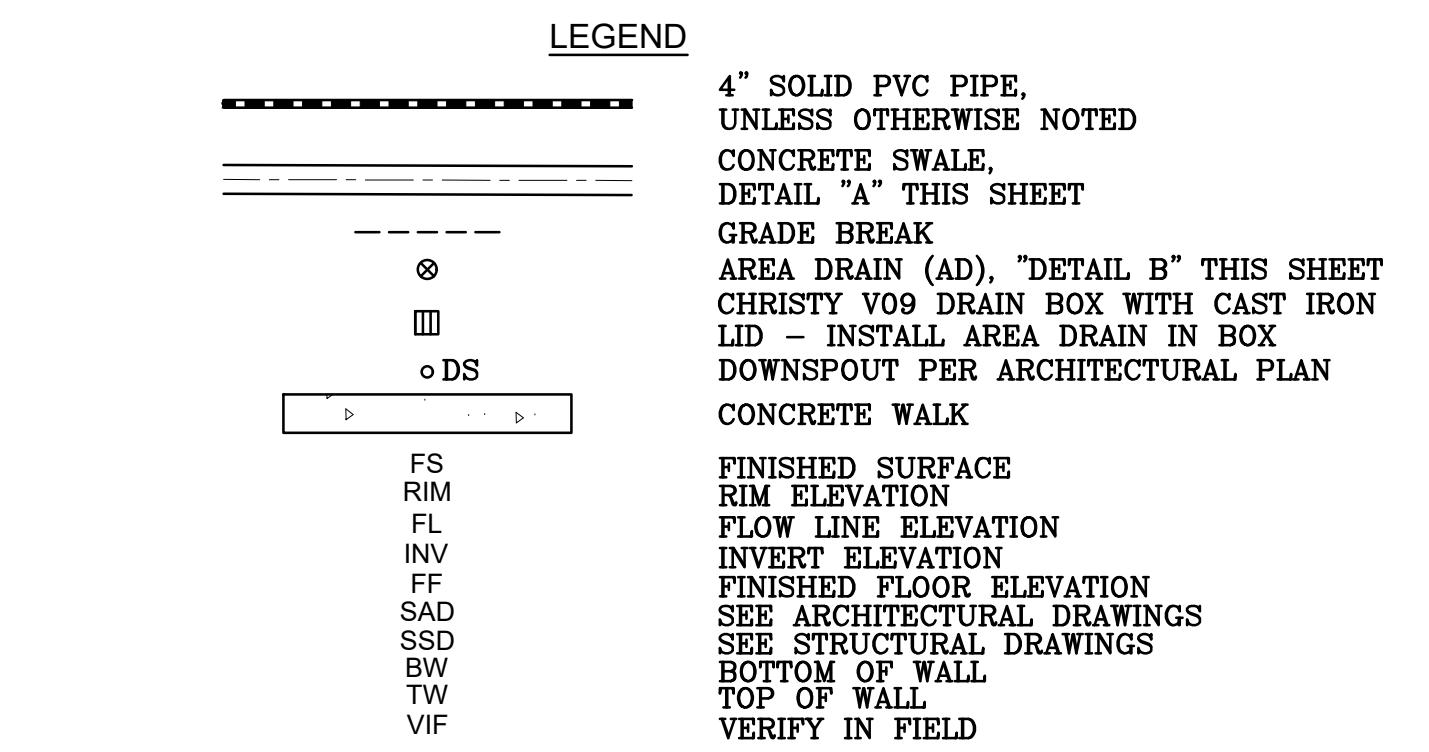

LEE RESIDENCE REMODEL

3016 ARGUELLO DR
BURLINGAME, CALIFORNIA 94010

OWNER

JAX LEE AND ANNIE YEOH
3016 Arguello Dr
Burlingame, California 94010

08.09.19	DESIGN REVIEW SUBMITTAL
09.30.19	DESIGN REVIEW RESUBMITTAL

MARK DATE DESCRIPTION

PROJECT NO: 1903
CAD DWG FILE: 1903-A-105 ROOF PLAN - EXISTING.DWG
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SHEET TITLE

ROOF PLAN - EXISTING

0 2' 4' 8'
SCALE: 1/4" = 1'-0"

A-105


SHEET

- OF -

LEGEND AND NOTES

- 1 (E) STAMPED METAL SHINGLE ROOF TO REMOVE
- 2 (E) FASCIA GUTTER TO REMOVE
- 3 (E) CHIMNEY TO REMOVE

NOTES:
1. FIELD VERIFY ALL DIMENSIONS & SITE CONDITIONS PRIOR TO COMMENCING WORK.

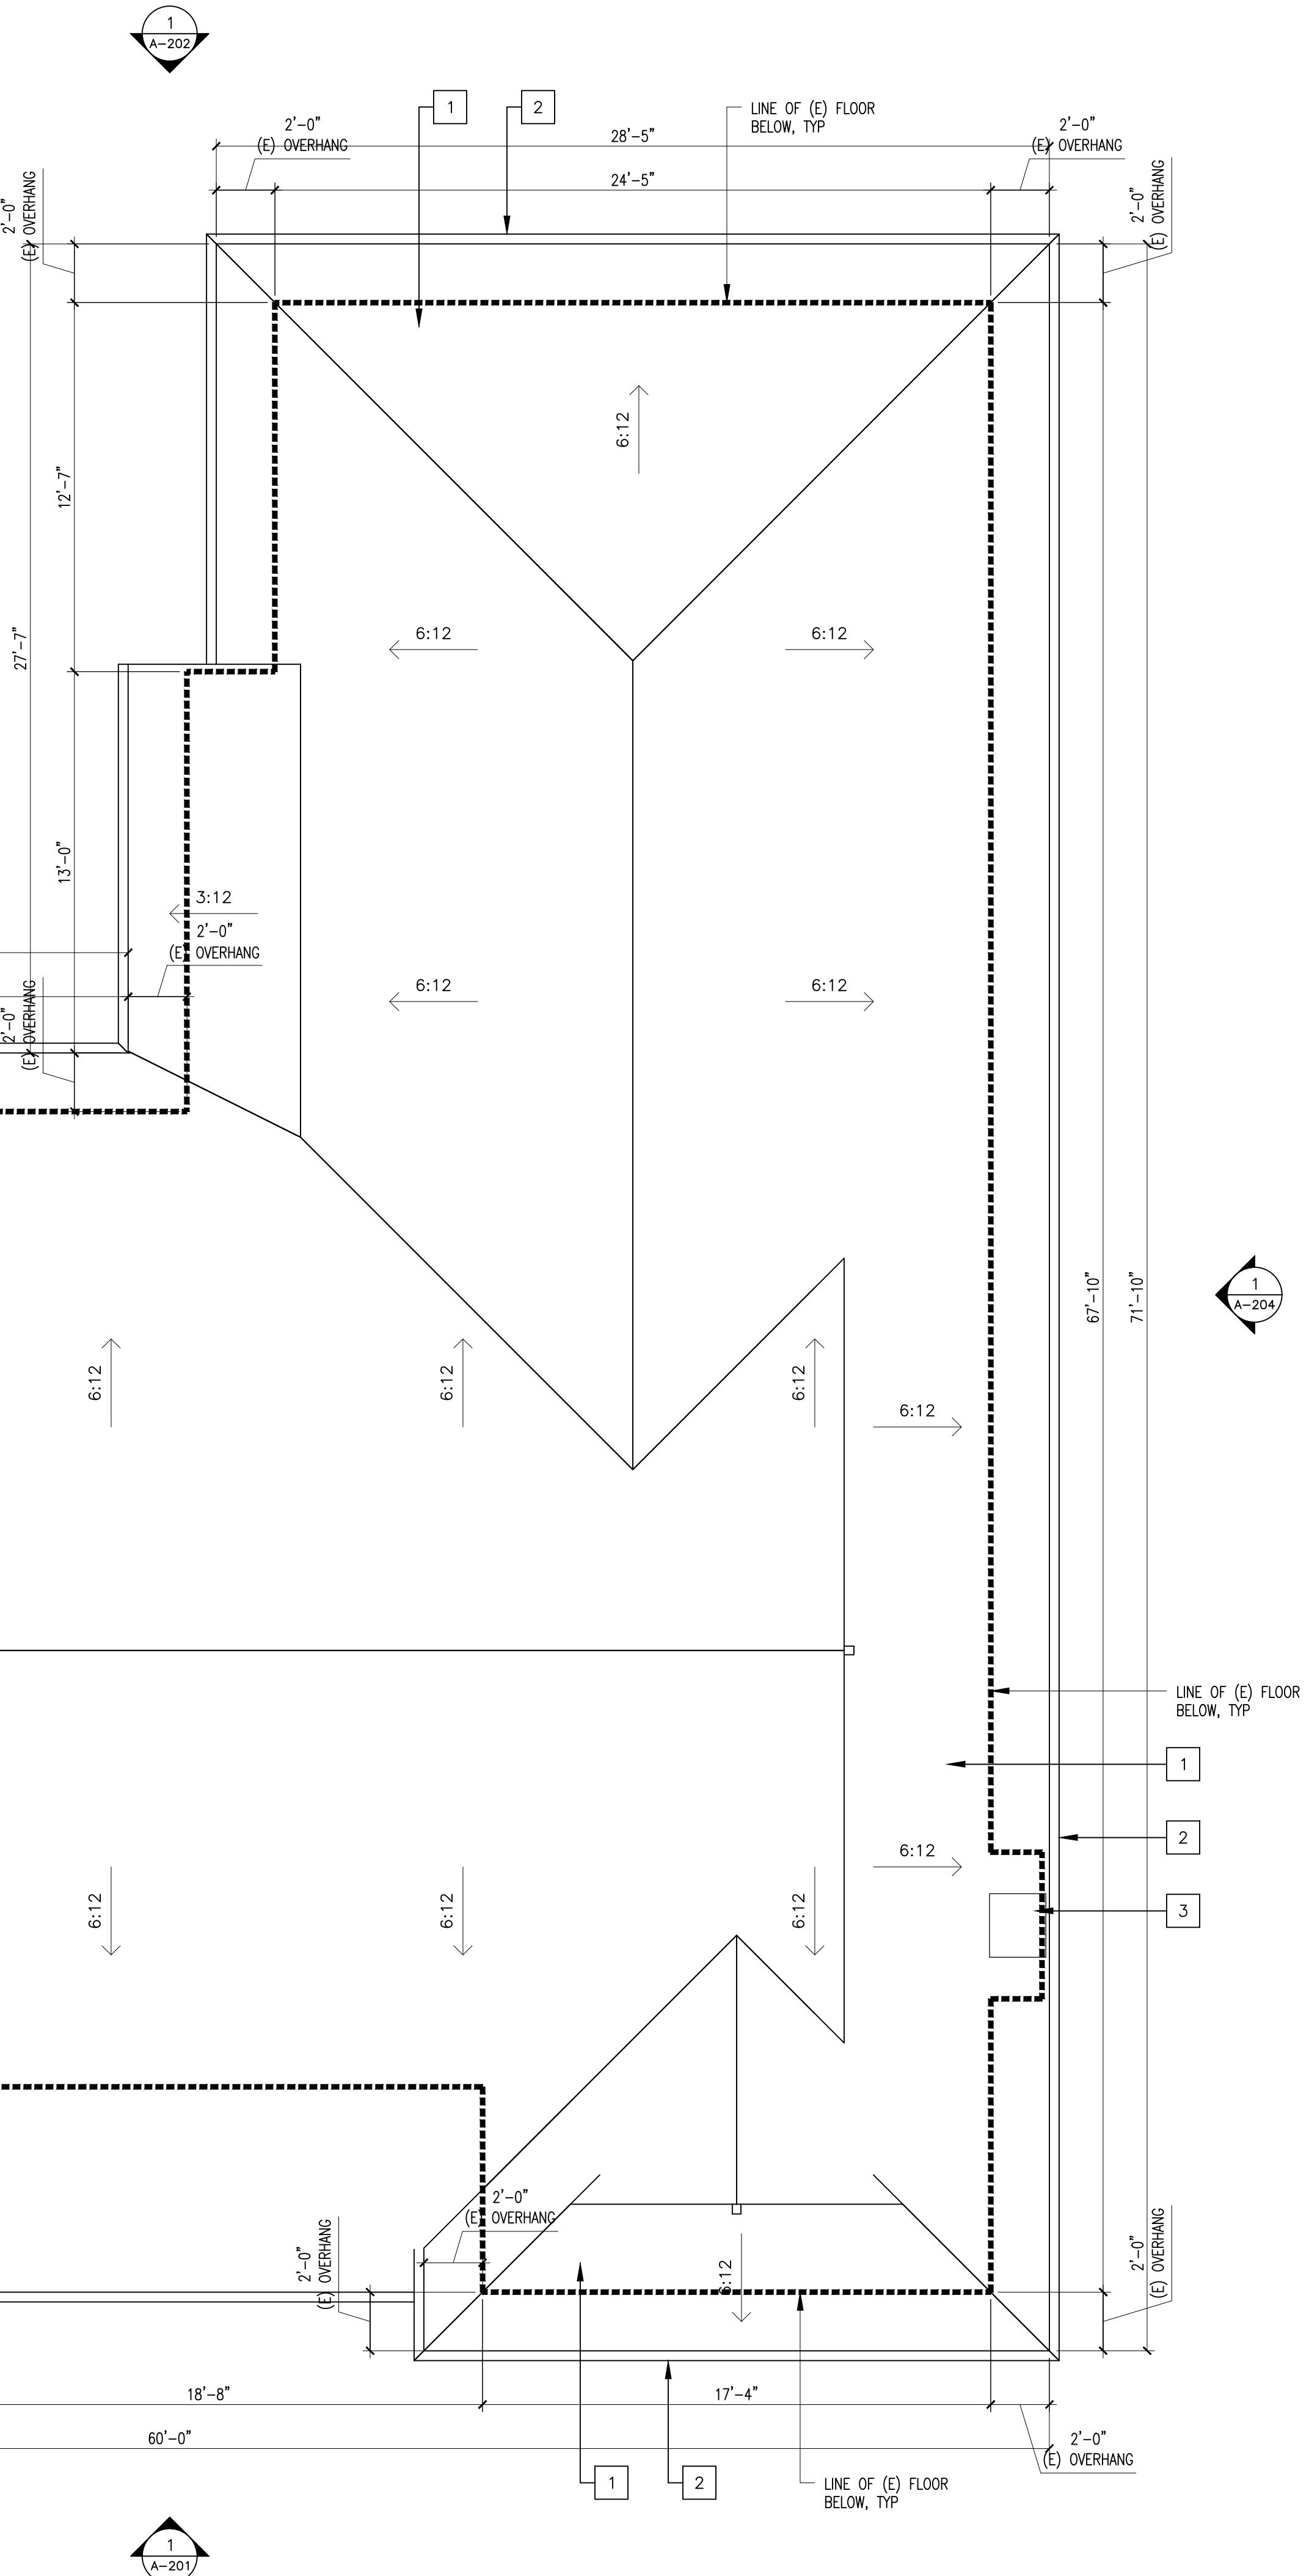

08.09.19	DESIGN REVIEW SUBMITTAL
09.30.19	DESIGN REVIEW RESUBMITTAL
12.23.19	DESIGN REVIEW RESUBMITTAL
02.14.20	DESIGN REVIEW RESUBMITTAL

MARK DATE DESCRIPTION

PROJECT NO: 1903

CAD DWG FILE: 1903-A-106 ROOF PLAN - PROPOSED.DWG


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ROOF PLAN - PROPOSED



SCALE: 1/4" = 1'-0"


A-106

SHEET - OF -

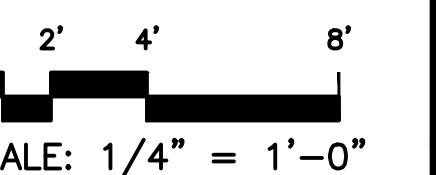LEGEND AND NOTES	
1	(N) STANDING SEAM METAL ROOF, DARK GRAY
2	(N) HALF-ROUND GUTTER, DARK GRAY
3	(N) CURB-MOUNT GLASS SKYLIGHT, VELUX

NOTES:

1. FIELD VERIFY ALL DIMENSIONS & SITE CONDITIONS PRIOR TO COMMENCING WORK.
2. PROVIDE ATTIC VENTING:
 - HIGH VENTING: RIDGE VENT
 - LOW VENTING: EAVE VENT

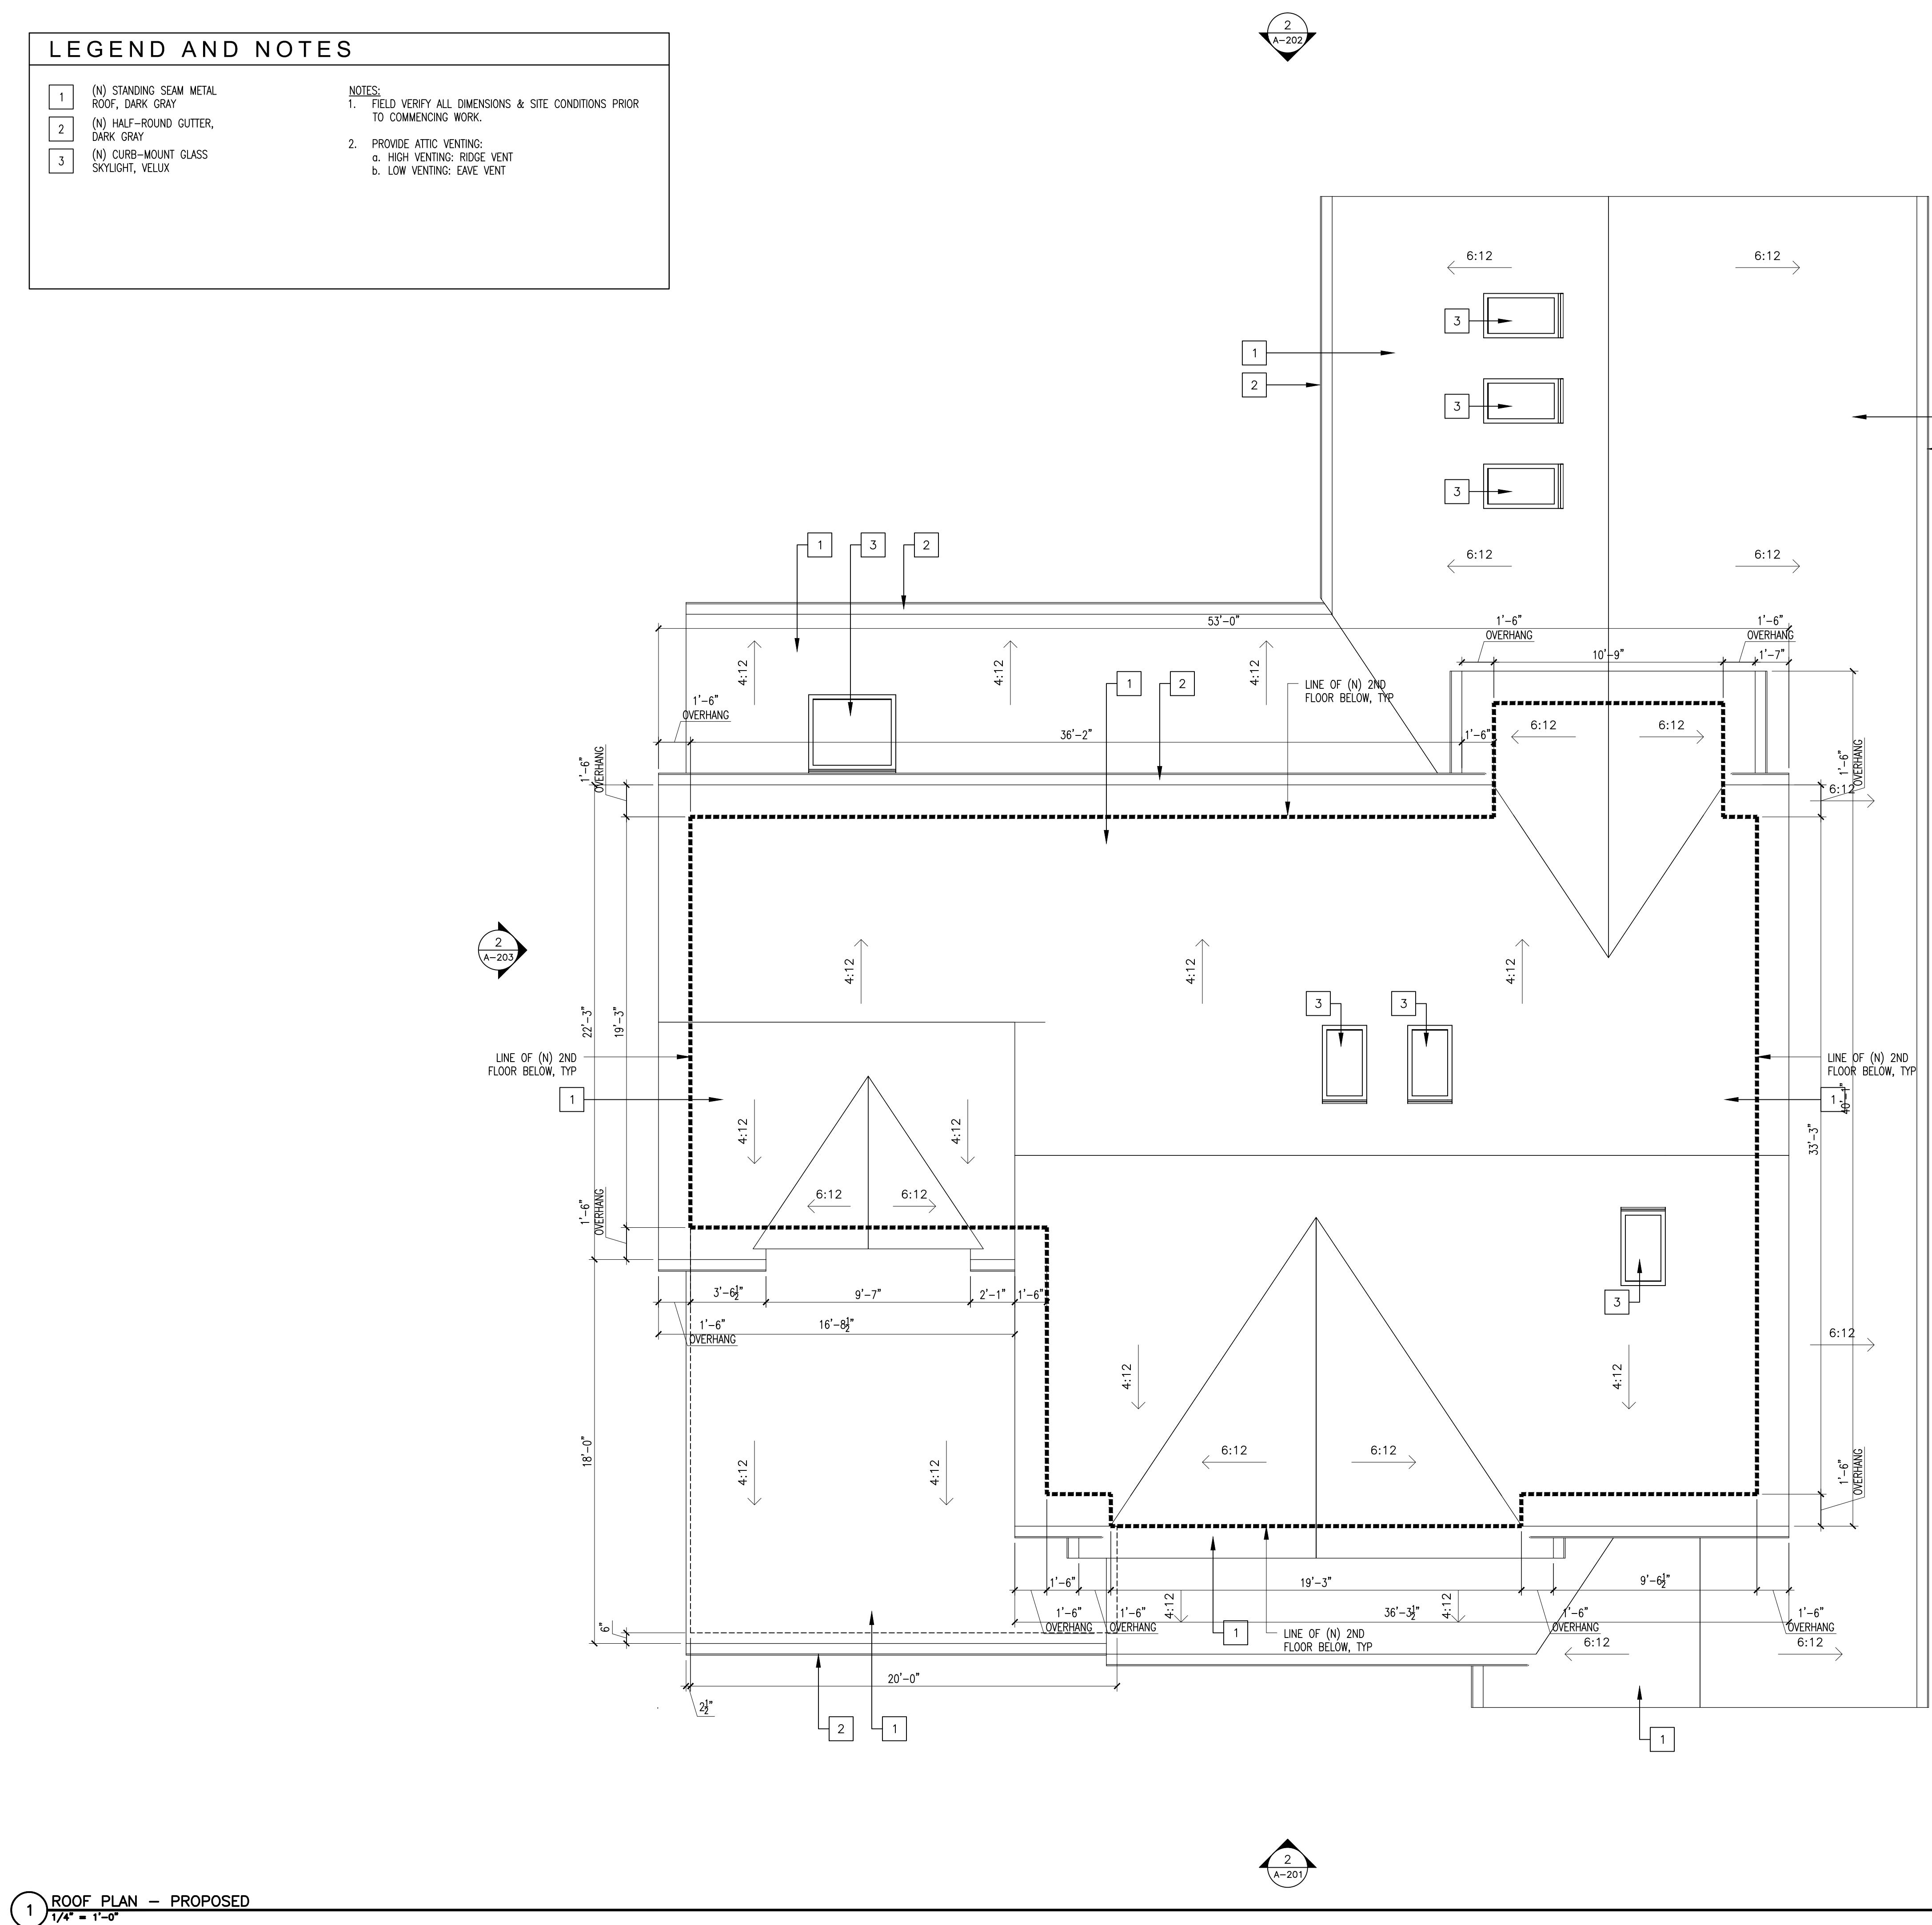

LEGAL DESCRIPTION:

LOTS 34, BLOCK 40 AS SHOWN ON THAT CERTAIN MAP ENTITLED, "MILLS ESTATE NO. 25, BURLINGAME, SAN MATEO COUNTY, CALIFORNIA", FILED IN THE OFFICE OF THE RECORDER OF SAN MATEO COUNTY RECORDER OF SAN MATEO COUNTY, STATE OF CALIFORNIA ON FEBRUARY 3, 1964 IN BOOK 59 OF MAPS, AT PAGE 40 AND 41.

BASIS OF ELEVATIONS:

THE ELEVATIONS ARE BASED FROM THE POINT "CP1" BEING A CUT CROSS, SET IN THE CURB LINE NEAR THE NORTH EAST CORNER OF LOT 34 HAVING A NORTHING OF 2038598.33, AND AN EASTING OF 6012432.24 BEING IN NAD83 CALIFORNIA ZONE 3 STATE PLANE COORDINATE SYSTEM, AND HAVING AN ELEVATION OF 442.95 BEING NAVD 88.

LEGEND

	OWNER'S PROPERTY LINE
	BOUNDARY OF ADJOINING PROPERTIES
	LOTS LINES PER ORIGINAL SUBDIVISION
	STORM DRAIN LINE
	ELECTRICAL UTILITIES
	WATER LINE
	SANITARY SEWER LINE
	GAS LINE
	WOOD FENCE LINE
	BUILDING FOOTPRINT
	ASPHALT
	CONCRETE
	WATER VALVE
	WATER METER
	DRAINAGE INLET
	SANITARY SEWER MANHOLE
	STORM DRAIN MANHOLE
	TREE LOCATION AND LIMITS OF DRIP LINE
	SET 0.75" IRON PIPE WITH PLASTIC PLUG STAMPED "L.S. 5577" PER CORNER RECORD UNDER REVIEW
	SET TACK AND 0.75" BRASS TAG IN CONCRETE SIDEWALK STAMPED "L.S. 9392" UNLESS OTHERWISE NOTED
	PER CORNER RECORD UNDER REVIEW

michael S. mahoney
MICHAEL S. MAHONEY PLS 5577

LICENSE EXPIRES 12/31/19





BASIS OF BEARINGS:

THE BEARING OF N53°04'02"E ALONG THE CENTERLINE OF ARGUELLO DRIVE BETWEEN TWO FOUND MONUMENTS HAVING A DISTANCE BETWEEN THEM OF 230.13' AS SHOWN ON THE SUBDIVISION MAP RECORDED IN BOOK 59 OF MAPS AT PAGES 40 & 41 IN THE OFFICE OF THE COUNTY RECORDER OF SAN MATEO COUNTY ON FEBRUARY 3, 1964.

REFERENCES:

(R2) 45 LLS 69

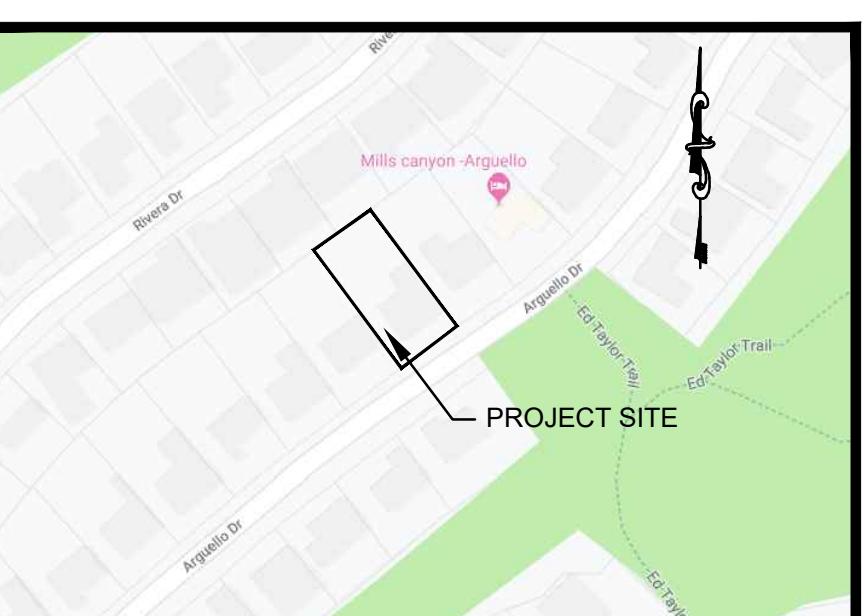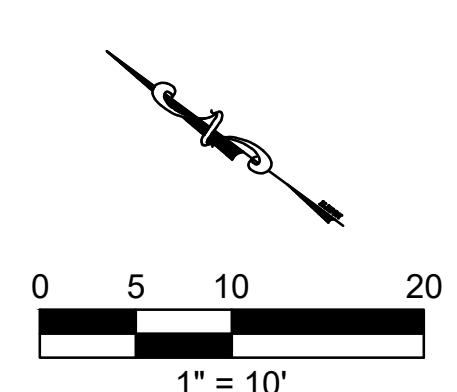

VICINITY MAP
NO SCALE