


PROJECT DATA 1525 Rollins Rd PROJECT ADDRESS

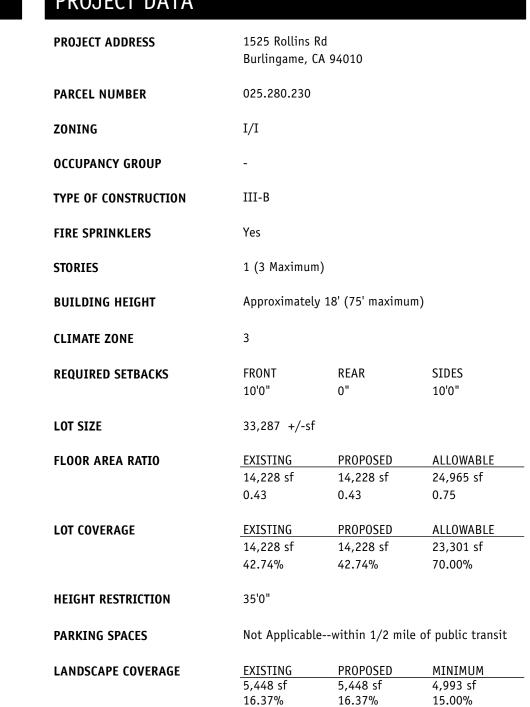



The project involves converting vacant office space in Suite B for church gatherings,

Automatic Fire Sprinkler, Fire Alarm Systems, and Fire Extinguishers

1. Fire sprinkler evaluation is required for TI work due to changes to interior walls.

The entire building is equipped with an automatic fire sprinkler and fire alarm

PROJECT TEAM

GENERAL NOTES

systems. It has fire extinguishers.

Deferred Submittals

instruction, and administrative office purposes.

These permit applications shall be submitted separately.

2. Fire alarm system requires evaluation and upgrading.

Applicant:
Pastor Eglai DeAlmeida House of Prayer, Word and Family Church 300 Crocker Avenue Daly City, CA 94014 650.834.2251 pr.eglai@hotmail.com

Architect:
Gary Diebel, AIA Diebel and Company | Architects PO Box 1044 Burlingame, CA 94011 650.558.8885 info@diebelstudio.com

As-Built Drawings: Precision Property Measurements Inc. Northern California Bay Area Office 510.479.7109 norcal@ppmco.net

APPLICABLE CODES


1. 2022 California Building Code 2. 2022 California Plumbing Code 3. 2022 California Mechanical Code 4. 2022 California Electrical Code 5. 2022 California Fire Code 6. 2022 California Green Building Code 7. 2022 California Energy Code 8. 2022 Building Energy Efficiency Standards 9. City of Burlingame Municipal Codes

DRAWING INDEX

Architectural
A-001 Title Sheet A-101 Site Plan A-102 Demolition Plan

A-103 Proposed Floor Plan A-104 Proposed Egress and Occupancy Load Plan

As-Built Drawings Site Plan Floor Plan

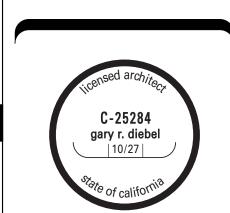

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tenant improvement:

family church

1525 rollins road

apn: 025.280.230

burlingame, ca 94010

house of prayer, word, and

burlingame, california

job name house of prayer church job number ²⁵⁰⁷³⁰

A-001

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102 Room Number Detail Number A-501 Sheet Number Section Number Sheet Number **Elevation Number** Sheet Number Property Line Setback or Easement ______ Line Fence Line \times \times \times \times Hidden Line -----Center Line __________ ____45_____ Existing Contour Proposed Contour Elevation Datum + 10'-0" Existing Point Elevation Proposed Point Elevation Column/ Grid line Window Identification Door Identification

Living Room

SYMBOLS

Room Name

MATERIALS Existing Construction Earth Granular Fill Concrete Metal Flashing Steel/ Metal Stud Wall Wood Framing (Continuous) Wood Framing (Interrupted) Finish Wood Plywood Batt Insulation Rigid Insulation Gypsum Board/ Plaster

1. Calculations not to be used for leasing, rental or sale purposes. Verify on the 2. Per CBC Table 504.3 the building meets the most restrictive requirements for occupancy groups A-3, M, and B.

not expand the building's footprint. The project does not require landscaping to

1. Building Height = 18' approximately, maximum height = 75' 2. Number of Stories = 1, maximum number of stories = 3 3. Building Area = 14,228 SF, maximum = 28,500 SF 3. The scope of work for Suite B only affects the interior of the building and does

comply with the current zoning code.

EXISTING USE SUMMARY						
SUITE	TENANT	RETAIL	OFFICE	WAREHOUSE	RELIGIOUS GATHERING	
Α	Sherwin-Williams	1,222 SF		4,279 SF		
В	Vacant		6,165 SF	666 SF		
С	National Pharmatek Corporation		1,118 SF	770 SF		
	TOTAL SI	1,222 SF	7,283 SF	5,715 SF		

PROPOSED USE SUMMARY								
SUITE	TENANT RETAIL OFFICE WAREHOUSE RELIGIOUS GATHERING							
Α	Sherwin-Williams	1,222 SF		4,279 SF				
В	House of Prayer, Word, and Family Church		5,120 SF		1,711 SF			
С	National Pharmatek Corporation		1,118 SF	770 SF				
	TOTAL SF	1,222 SF	6,238 SF	5,049 SF	1,711 SF			

0	<u>tes</u>
	Calculations not to be used for leasing, rental or sale purposes. Verify on the site.
	This property is located within half a mile of major transit options and is
	therefore exempt from off-street parking requirements under AB 2097.

SUITE	USE	NUMBER OF OFF-STREET PARKING SPACES PER SF	TOTAL SF	TOTAL PARKING SPACES
A	Retail	1 space per 400 SF	1,222 SF	3.06
	Warehouse	1 space per 1,000 SF	4,279 SF	4.28
В	Office	1 space per 300 SF	6,165 SF	20.55
	Warehouse	1 space per 1,000 SF	666 SF	0.67
C	Office	1 space per 300 SF	1,118 SF	3.73
	Warehouse	1 space per 1,000 SF	770 SF	0.77
				22 Spaces

40 Spaces Existing

PROPOSED PARKING RATIO SUMMARY						
SUITE	USE	TOTAL PARKING SPACES				
Α	Retail	1 space per 400 SF	1,222 SF	3.06		
	Warehouse	1 space per 1,000 SF	4,279 SF	4.28		
В	Office	1 space per 300 SF	5,120 SF	17.07		
	Religious Gathering	1 space per 60 SF	1,711 SF	12.03		
С	Office	1 space per 300 SF	1,118 SF	3.73		
	Warehouse	1 space per 1,000 SF	770 SF	0.77		
				41 Spaces		
				40 Spaces Existing		

PR	PROPOSED PARKING RATIO SUMMARY						
SUITE	USE	NUMBER OF OFF-STREET PARKING SPACES PER SF	TOTAL SF	TOTAL PARKING SPACES			
Α	Retail	1 space per 400 SF	1,222 SF	3.06			
	Warehouse	1 space per 1,000 SF	4,279 SF	4.28			
В	Office	1 space per 300 SF	5,120 SF	17.07			
	Religious Gathering	1 space per 60 SF	1,711 SF	12.03			
С	Office	1 space per 300 SF	1,118 SF	3.73			
	144 1	1 1 000 05	770 CF	0.77			

therefore exempt from off-street parking requirements under AB 2097.

Site Plan Keynotes

A. (E) Accessible loading space, typ.

B. (E) Accessible parking space, typ. (E) Accessible path (E) Asphalt (E) Concrete (E) Decorative concrete G. (E) Electric box (E) Fire hydrant (E) Gas service meter (E) Irrigation controls (E) Planting area, typ L. (E) Sidewalk, typ. M. (E) Transformer

Site Plan General Notes

N. (E) Turf, typ.
O. (E) Utility box, typ.
P. (E) Water meter, typ.

1. All site construction work shall conform to the City of Burlingame requirements and/or standard details and specifications, and shall be subjected to city inspection and approval.

2. Maintain 3' x 3' minimum landing at both sides of doors. 3. The contractor is responsible for repairing or replacing damages or damaged

- such damages were due to the contractor's construction activity or lack of adequate protective measures. 4. The current accessibility for disabled individuals at the project site, including
- the accessible route from public parking to common areas, shall not be diminished or otherwise altered by this project's work.

areas to an as-was or better condition, if it can be reasonably construed that

- 5. The design intention of these drawings reflects the overall design goals to be implemented on the site. The Contractor is responsible for contacting the Architect for additional clarification or details required to accommodate site
- 6. The indicated utilities are in approximate locations based on as-built drawings and visual observations. The general contractor must verify their locations, sizes, types, and other details with the municipality and utility providers.
- Topography: The site is relatively flat as is the general vicinity. 8. Trees with a circumference exceeding 48 inches, measured 54 inches above
- natural grade, cannot be removed without a protected tree removal permit from the Parks Division. All protected trees onsite must remain healthy during and after the project. Additionally, storage, staging, site access, debris disposal, or temporary structures are prohibited under trees.
- 9. Upon completion, the Contractor shall certify that all work has been installed per the Contract Documents. All variations from the documents must be presented to the Architect accurately and/or graphically on record drawings before final acceptance. Refer to specifications for additional close-out information and procedures.
- 10. Verify all existing conditions and dimensions in the field prior to starting work. Report any discrepancies to the Owner and Architect.

11. Verify location of underground utilities.

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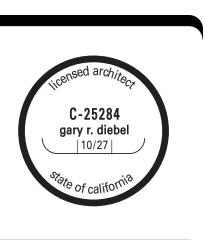
burlingame, california



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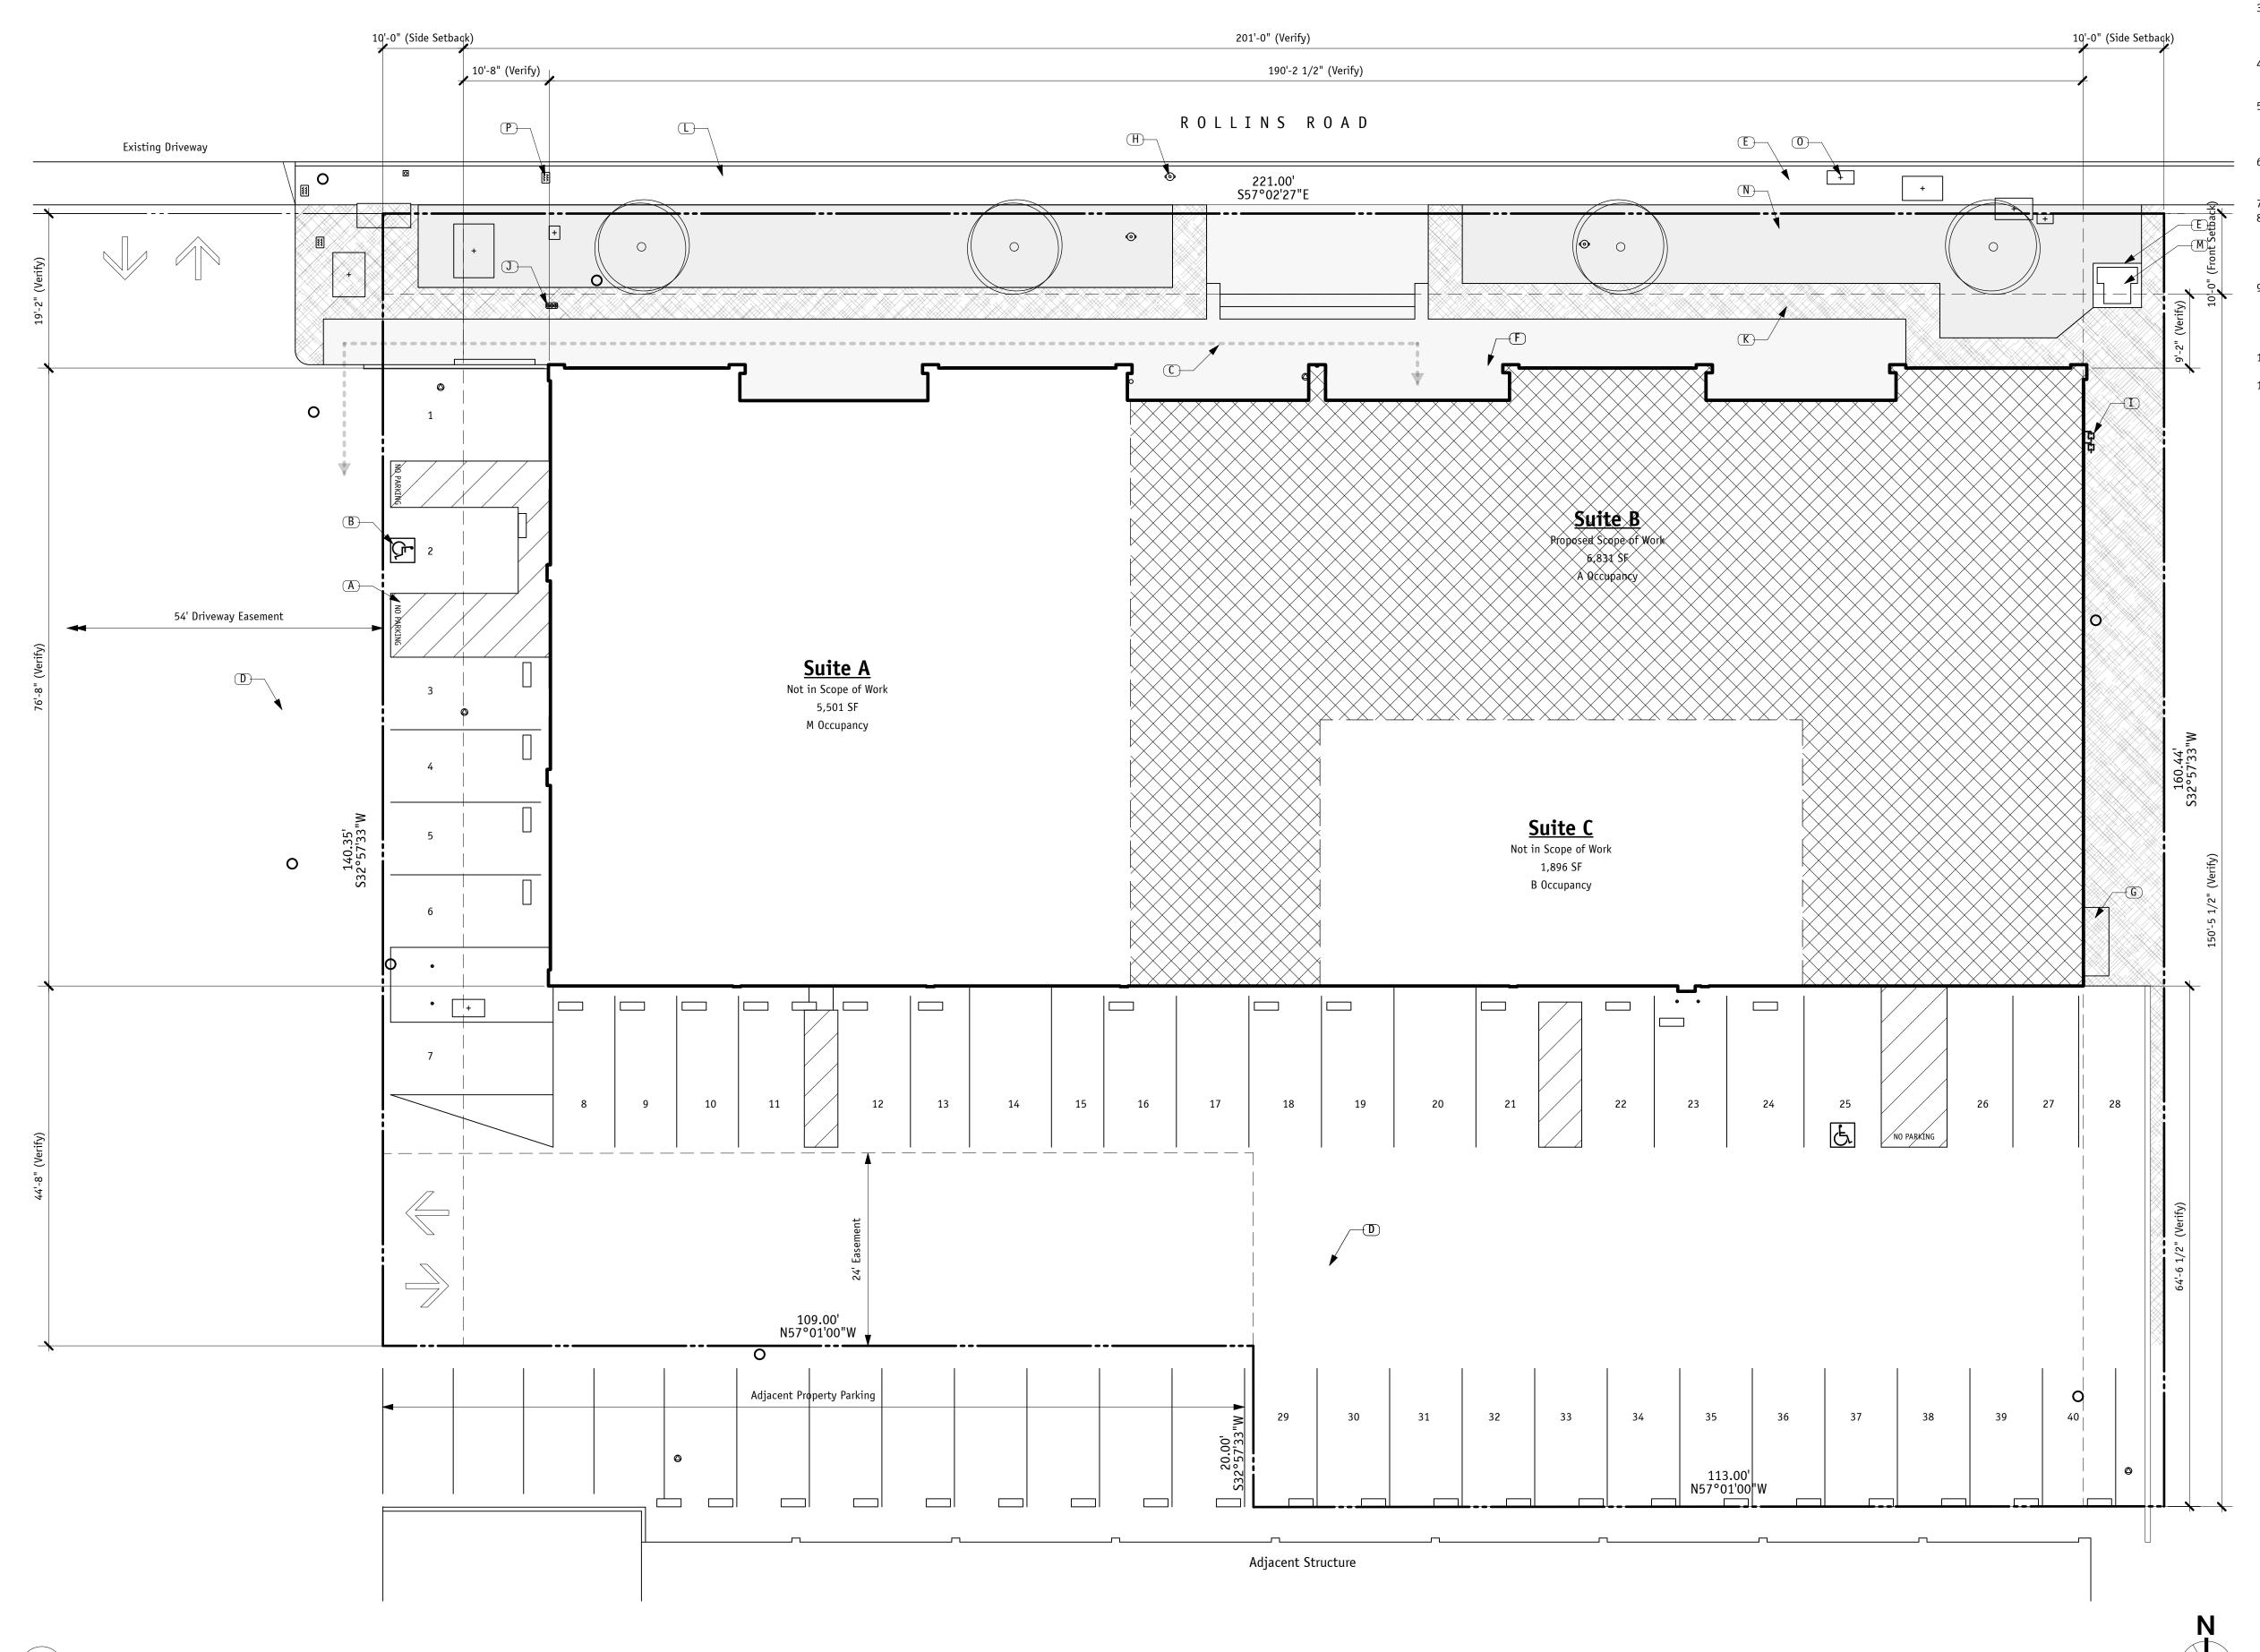
house of prayer, word, and family church

1525 rollins road burlingame, ca 94010 apn: 025.280.230



	Job name	house of prayer church
	job number	250730
	date	10.30.25
	revision	

A-101





1 DEMOLITION PLAN
A-102 1/8" = 1'-0"

Demolition Plan Keynotes

(E) Electrical panel (E) Gas meter to remain, typ.

Remove (E) appliances as indicated.
Remove (E) door, casing, jambs, and wall, typ.
Remove (E) millwork and countertops as indicated.
Remove (E) office cubicles, typ.

G. Remove (E) partition wall, typ.
H. Remove (E) plumbing fixtures as indicated.
I. Remove (E) sink and cap plumbing.
J. Remove (E) window, casing, jambs, and wall, typ.

General Demolition Plan Notes

1. All dimensions are approximate and based on PPM as-built drawings, 6/2/2025. Verify all dimensions and conditions on site.

2. Install a dust barrier to shield areas outside the work scope from construction dirt or dust.

3. Remove abandoned equipment, pipes, and wiring, including combustibles in

plenums.
4. Verify all locations of Mechanical, Plumbing, and Electrical requirements, chases,



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house of prayer, word, and family church

1525 rollins road burlingame, ca 94010 apn: 025.280.230



job name	house of prayer church
	-
job number	250730

08.18.25

A-102

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DOOR SCHEDULE

- A Existing 3' x 7' aluminum, tempered glass storefront entry door with push-pull hardware, closer, and stop. Provide new panic hardware.
- Existing 3' \times 7' solid core door with lever latch set in existing aluminum and tempered glass interior system to remain.
- Existing 3' \times 7' hollow metal door and frame with lever hardware. Provide new panic hardware.
- D Existing 3' x 7' hollow metal door and frame with lever hardware to remain.

Door Schedule Notes

- 1. All exit hardware, even when the door is in a locked position, shall be openable from the egress side with one action. No keys, special knowledge, or effort shall
- Determine door swing and operation requirements from floor plans.
 Provide panic hardware for all exit and exit access doors within the tenant space.
- CBC 1010.2.9 4. Verify existing site conditions, door dimensions and Manufacturer requirements.

- **Proposed Floor Plan Keynotes** Concrete exterior wall, typ. Concrete wall, typ. Electric box
- E) Fire alarm control (E) Gas meter to remain, typ. (E) Roof access

Verify on the site.

- General Floor Plan Notes
 1. All dimensions are approximate and based on PPM as-built drawings, 6/2/2025.
 Verify all dimensions and conditions on site. Baseboard, casing, moulding, and millwork to match existing.
 Verify all locations of Mechanical, Plumbing, and Electrical requirements, chases,
- 4. Approximate floor areas not to be used for leasing, rental, or sale purposes.



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□□□□□□ Remove existing wall


New Interior Wall. 2 1/2", 25-gauge metal studs at 24" o.c. with 5/8" gypsum board on both sides. Wall framing extends from the floor slab to 6" above the suspended ceiling partition, approximately 10'-6" in height. Match existing adjacent walls.



job name house of prayer church job number ²⁵⁰⁷³⁰

A-103

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1 PROPOSED FLOOR PLAN
A-103 1/8" = 1'-0"

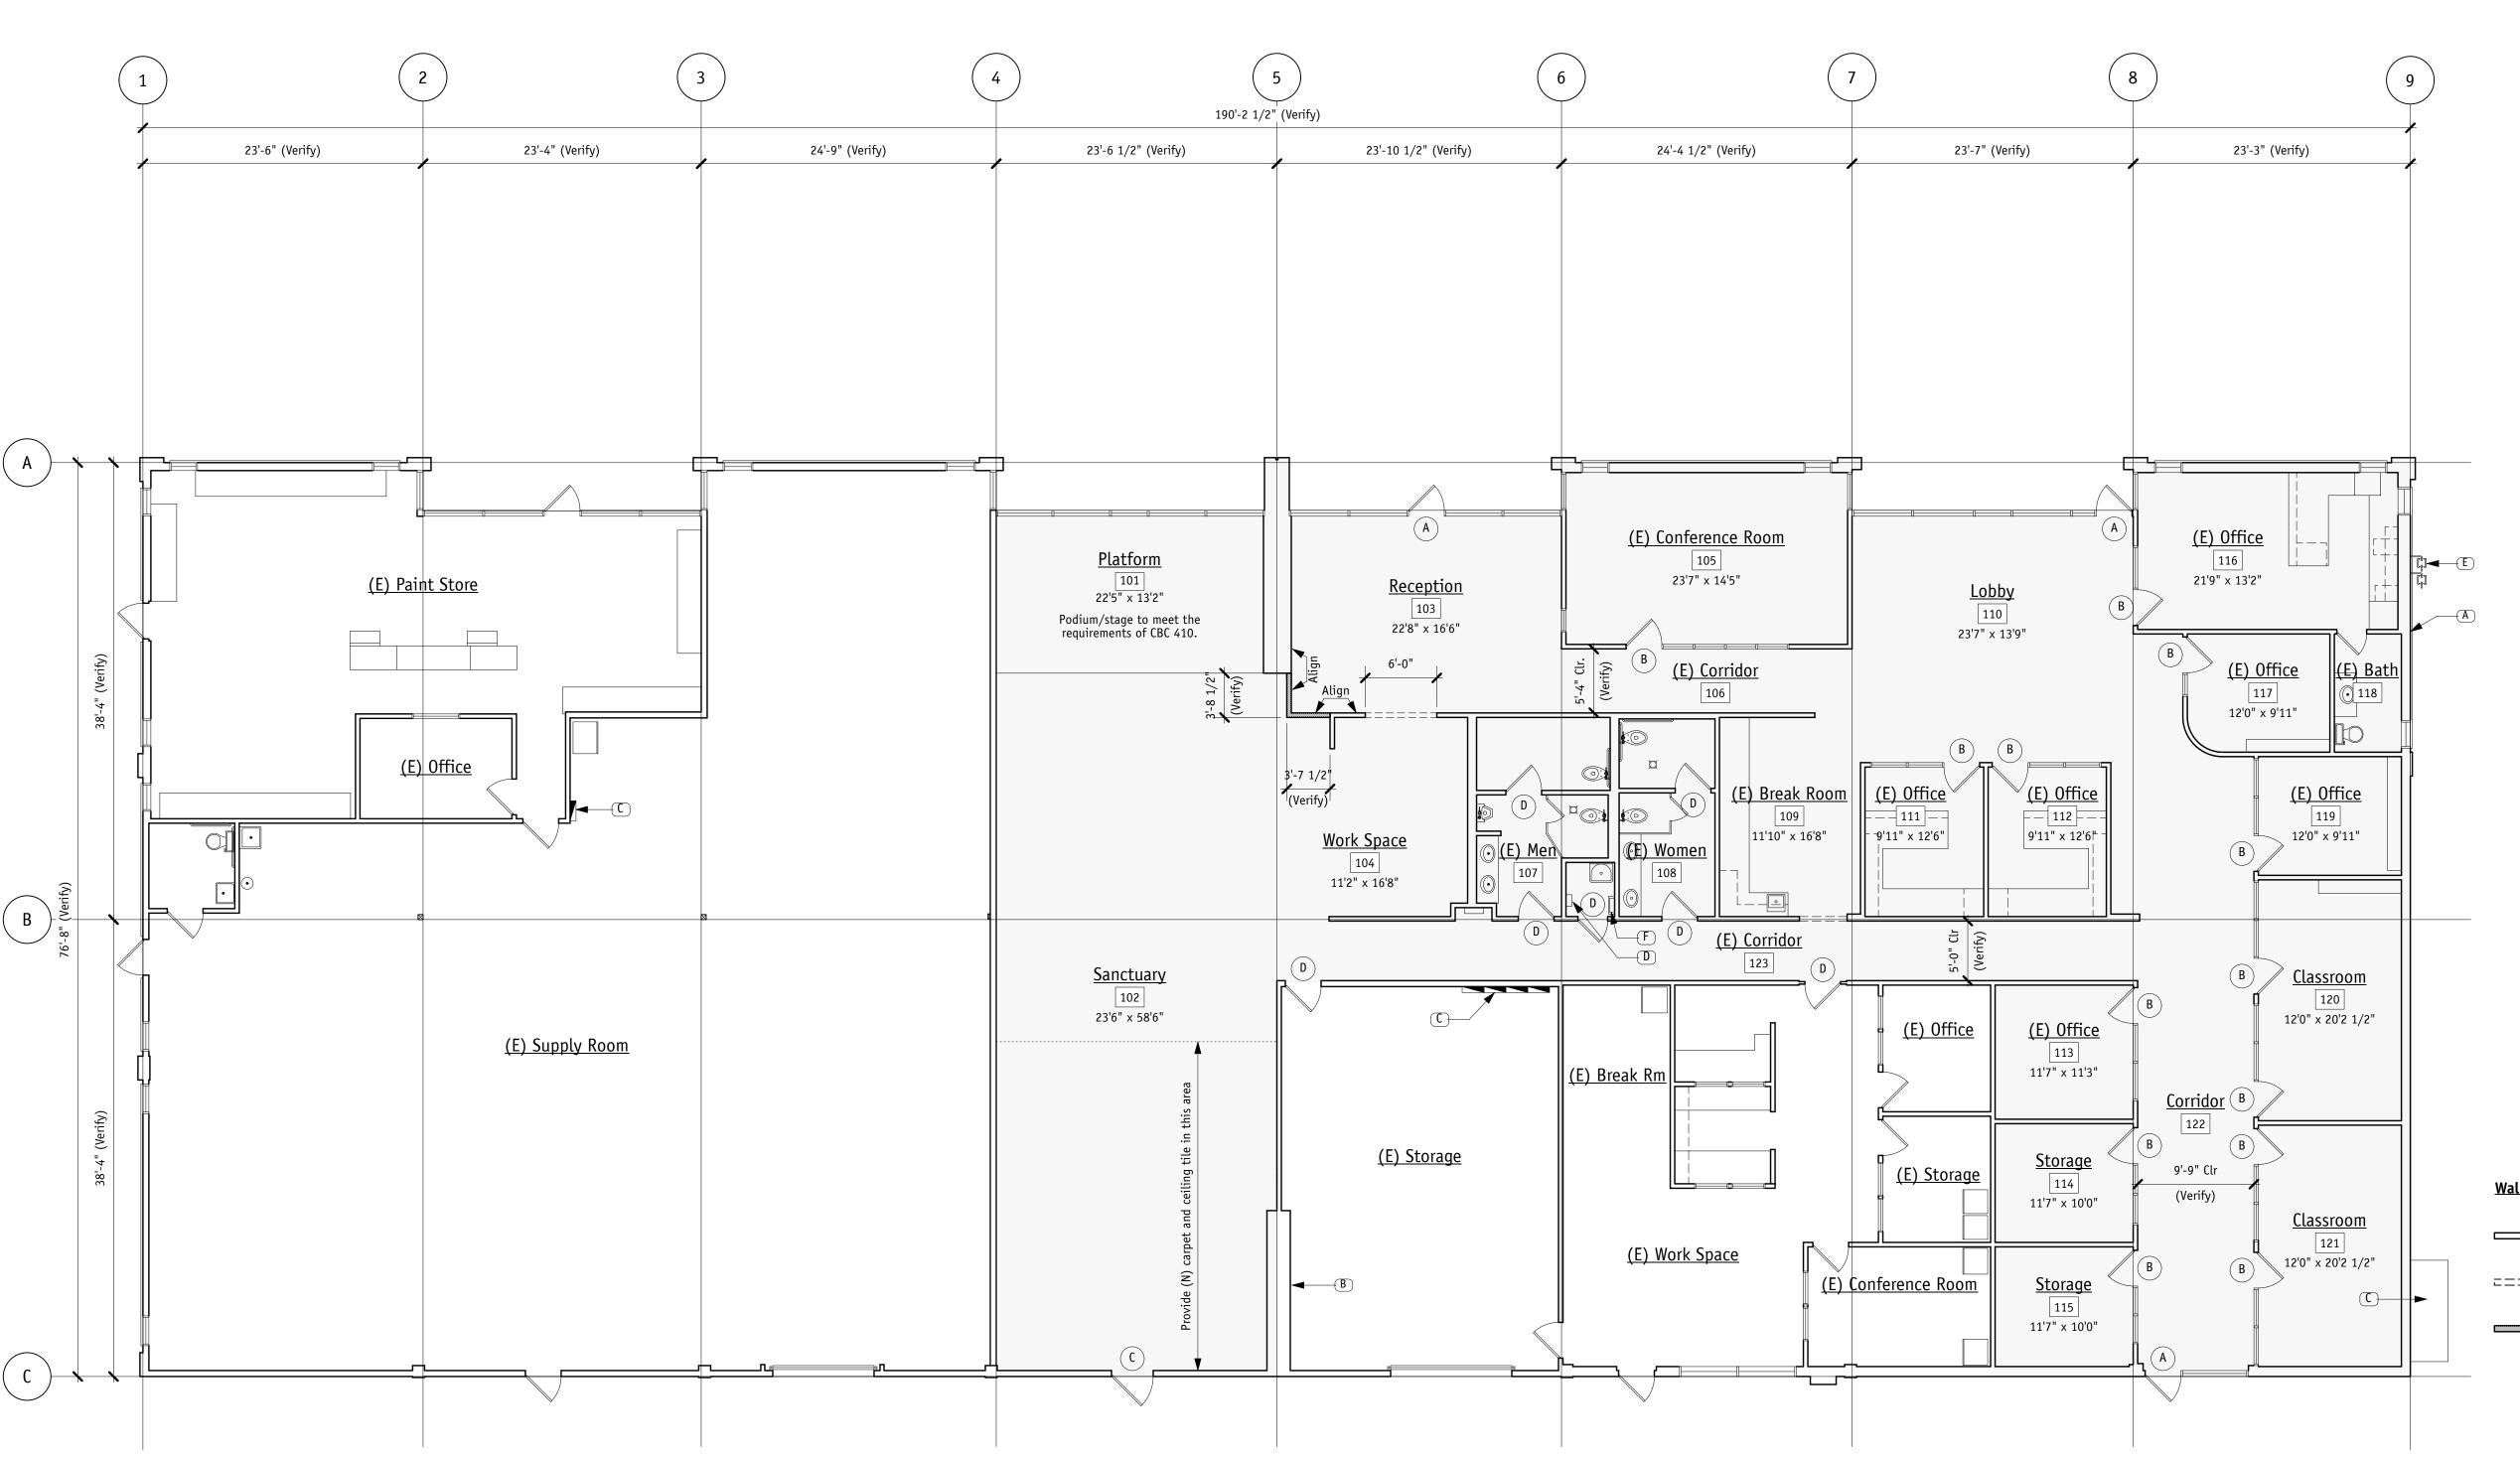OCCUPANT LOAD TABLE								
SYMBOL	ROOM NAME	FUNCTION OF SPACE	AREA	OCCUPANT LOAD FACTOR	NUMBER OF OCCUPANTS	NOTES		
Α	Podium	Assembly Unconcentrated	295 SF	1/15	20			
В	Sanctuary	Assembly Concentrated	1375 SF	1/7	197			
С	Reception	Business Area	374 SF	1/150	3			
D	Work Space	Business Area	186 SF	1/150	2			
E	(E) Conference Room	Assembly Unconcentrated	400 SF	1/15	27			
F	(E) Break Room	Assembly Unconcentrated	197 SF	1/15	14			
G	Lobby	Business Area	324 SF	1/150	3			
Н	(E) Office	Business Area	124 SF	1/150	1			
I	(E) Office	Business Area	124 SF	1/150	1			
J	(E) Office	Business Area	130 SF	1/150	1			
K	Storage	Storage	116 SF	1/300	1			
L	Storage	Storage	116 SF	1/300	1			
М	(E) Office	Business Area	286 SF	1/150	2			
N	(E) Office	Business Area	119 SF	1/150	1			
0	(E) Office	Business Area	119 SF	1/150	1			
Р	Classroom	Classroom Area	243 SF	1/20	13			
Q	Classroom	Classroom Area	243 SF	1/20	13			
				TOTAL OCCUPANTS	301			

Occupancy Load Notes Calculations not to be used for leasing, rental or sale purposes. Verify on the

2. Corridors, stairways, toilet rooms, mechanical rooms, and closets not required to be included in the Occupant Load Calculation.

3. Every assembly occupancy room or space shall have the occupant load posted in a conspicuous place, near the main exit or exit access doorway from the room or space. Posted signs shall be of an approved legible permanent design and shall

be maintained by the owner or authorized agent. CBC 1004.3
4. Minimum number of exits required = 2 Number of existing exits = 4 For tenant spaces with a total occupant load of 600 people or fewer, at least two separate exits are required. Exit travel distance 250' for fire sprinklered building.

 Nonseparated Occupancies Notes
 This building meets requirements for Nonseparated Occupancies. Fire-rated separation is not required between occupancy groups. CBC 508.3 For Occupancy Groups A-3, B, and M, no separation is needed between non-separated occupancies that meet the most restrictive requirements of these groups. CBC

2. The building meets the most restrictive requirements under CBC 508.3.2 for occupancy groups A-3, B, and M. 1. Building Height = 18' approximately, maximum height = 75'

2. Number of Stories = 1, maximum number of stories = 3
3. Building Area = 14,228 SF, maximum = 28,500 SF

3. The building complies with the most restrictive fire protection requirements for Occupancy Groups A-3, B, and M. Fire sprinklers and fire extinguishers are

required per CBC Chapter 9. 4. The building is not a high-rise under CBC 508.3.1.1, and does not need to meet the requirements of CBC 403, except those required under other sections.

Proposed Occupant Load and Egress Plan Keynotes

) Fire alarm control) Fire extinguisher

(E) Internally illuminated exit sign (N) Internally illuminated exit sign

Church chair, not fixed, typ. Common path of travel, typ.

Path of Egress Notes

 Exit door locations must comply with CBC Section 1007 regarding exit and exit access door configurations. These exits should be within 250 feet of travel distance from any point within the structure for a fire sprinklered building. Doors must be equipped with panic or fire hardware, not be latched or locked, and swing in the direction of egress. Means of egress should be accessible, visible, and clearly marked, with illuminated exit signs and emergency lighting.

2. Exit width per occupant load: 1. Corridors: CBC Table 1020.3 requires 44" clear width

CBC 1005.3.2 calculated minimum with is 299 occupants x .02" per occupant = 59.8" minimum width per corridor 59.8" > 44"

Minimum clear corridor width = 59.8"

2. Doors: CBC 1010.1.1 requires 32" clear width

CBC 1005.3.2 calculated minimum with is 299 occupants x .02" per occupant = 59.8" total door width. 59.8" / four doors = 14.95" 32" > 14.95"

Minimum door clear width = 32" 3. Internally Illuminated Exit Signs: Electrically powered, self-luminous and photo luminescent exit signs shall be listed and labeled in accordance with UL 924 and shall be installed in accordance with the manufacturer's instructions and Chapter

27. "EXIT" signs shall be illuminated at all times. 4. Maximum overall diagonal dimension of area served = 139'-7" The building is equipped with an automatic sprinkler system. The exit separation distance must be at least 1/3 of the maximum diagonal dimension.

139'-7" x 1/3 = 46'-6" The exit separation distances exceed 46'-6". CBC 1017.1.1 Ex. 2

5. Provide direction signage indicating the location of the accessible means of

6. Signs over exit doors with minimum 1" high letters to read "THIS DOOR TO REMAIN UNLOCKED DURING BUSINESS HOURS." The only exception to exit door

labeling is the main entry door only.

7. Where a building is equipped throughout with an automatic sprinkler system in accordance with section 903.3.1.1 or 903.3.1.2, the separation distance shall not be less than one-third of the length of the maximum overall diagonal dimension of the area served. CBC 1007.1.1 exemption 2

Fire Extinguisher Notes

1. Each extinguisher is required to be mounted with the top of the extinguisher no more than 5 feet off the floor and the bottom at least 4 inches off the floor. Extinguishers must be mounted on a wall or other structure with an approved

2. Review final locations with the Fire Department.

3. The minimum rating for fire extinguishers is a 2A10BC.

4. The travel distance for occupants to an extinguisher is not to exceed 75 feet. Extinguishers should be located along normal paths of travel.

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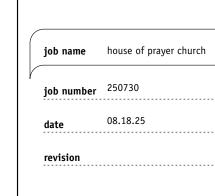
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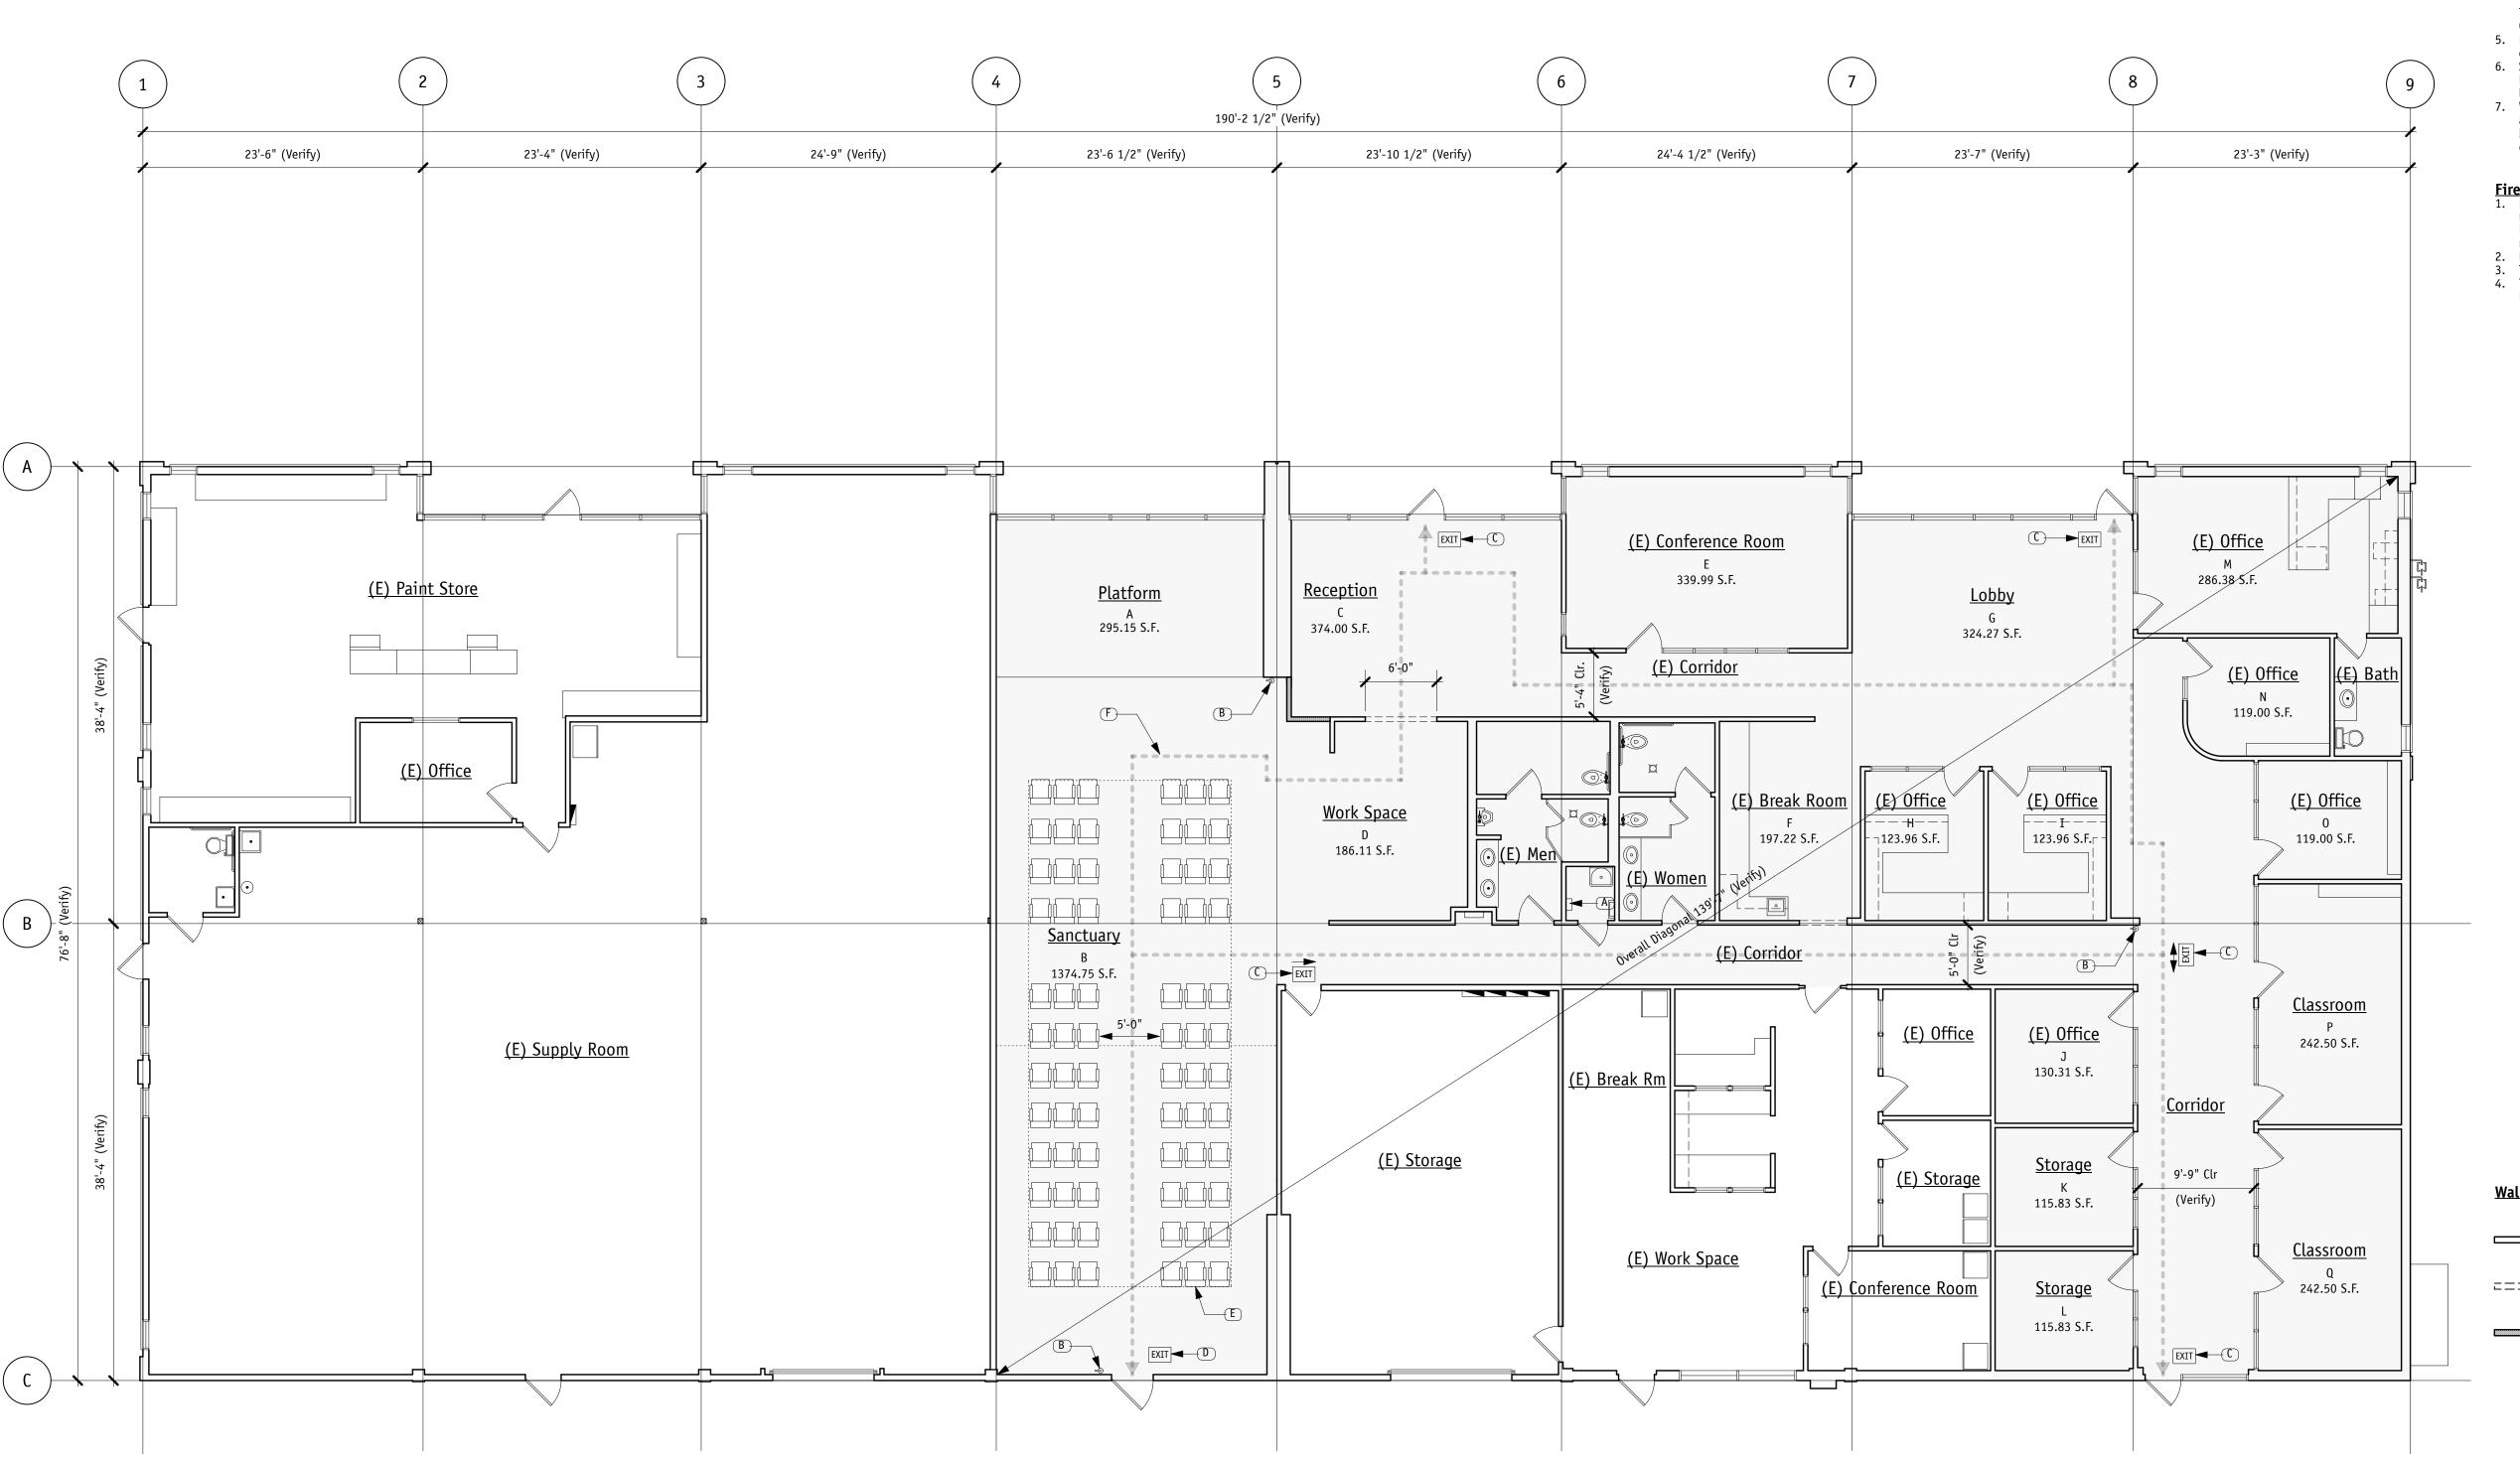
> 1525 rollins road burlingame, ca 94010 apn: 025.280.230





A-104

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_____ Existing wall

□□□□□□ Remove existing wall

New Interior Wall. 2 1/2", 25-gauge metal studs at 24" o.c. with 5/8" gypsum board on both sides. Wall framing extends from the floor slab to 6" above the suspended ceiling partition, approximately 10'-6" in height. Match existing adjacent walls.