
### ARCHITECTURAL ABBREVIATIONS

KUI	IIIECIUKAL	ADD	REVIATIONS		
AB	ANCHOR BOLT	GA	GAUGE	R	RADIUS
ABV	ABOVE	GALV	GALVANIZED	RA	RETURN AIR
A/C	AIR CONDITIONING	GB	GYPSUM BOARD	RB	RUBBER BASE
ACT	ACOUSTICAL CEILING TILE	GC	GENERAL CONTRACTOR	RD	ROOF DRAIN
ADDL	ADDITIONAL	GL	GLASS, GLAZING	RECY	RECYCLE(D)
ADJ	ADJUSTABLE	GWB	GYPSUM WALL BOARD	REF	REFERENCE
AFF	ABOVE FINISH FLOOR	GYP	GYPSUM	REFRIG	REFRIGERATION OR
ALT	ALTERNATE	110	HANDIOAD	DEINE	REFRIGERATION
ALUM	ALUMINUM	HC	HANDICAP	REINF	REINFORCE
ARCH	ARCHITECT(URAL)	HDR	HEADER	REQD	REQUIRED
AWN	AWNING	HDW	HARDWARE	RM	ROOM
D/	DOTTOMOF	HM	HOLLOW METAL	RO	ROUGH OPENING
B/	BOTTOM OF	HORIZ	HORIZONTAL	ROW	RIGHT OF WAY
BD	BOARD	HR	HOUR	0	COLITII
BLDG	BUILDING	HT HTD	HEIGHT	S SC	SOUTH
BLKG	BLOCKING BEAM OR BENCHMARK	HVAC	HEATED	SCH	SOLID CORE
BM BRG	BEAM OR BENCHMARK	HVAC	HEATING/VENTILATION & AIR CONDITIONING	SCHED	SCHEDULE
BTWN	BEARING BETWEEN		CONDITIONING	SECT	SCHEDULED SECTION
BUR	BUILT-UP ROOF	ID	INSIDE DIAMETER	SECT	SQUARE FEET
DUK	BUILT-UP ROOF	INFO	INFORMATION	SFRM	SPRAY APPLIED FIRE
CAB	CABINET	ISO	ISOCYANURATE	SEKIVI	MATERIAL
CAB	CONTROL JOINT	INSUL	INSULATE / INSULATED / INSULATION	SGL	SINGLE
CL	CENTERLINE	INT	INTERIOR	SHT	SHEET
CLG	CEILING	INV	INVERT	SHTG	SHEATHING
CMU	CONCRETE MASONRY UNIT	IIVV	INVLIXI	SIM	SIMILAR
CO	CLEAN OUT	JT	JOINT	SPECS	SPECIFICATIONS
COL	COLUMN	J-BOX	JUNCTION BOX	SOD	SLAB ON DECK
CONC	CONCRETE	0-DOX	JONO HON BOX	SOG	SLAB ON GRADE
CONT	CONTINUOUS	KIT	KITCHEN	SOH	SAME OPPOSITE HAN
CONST	CONSTRUCTION	IMI	INTO TEN	SS	STAINLESS STEEL
CG	CORNER GUARD	L	LONG / LENGTH	ST	STONE TILE
CPT	CARPET	LAM	LAMINATE(D)	STD	STANDARD
CSMT	CASEMENT	LAV	LAVATORY	STND	STANDARD
CT	CERAMIC TILE	LF	LINEAR FEET	STL	STEEL
01	OLIV WING TIEL	LT	LIGHT		STRUCTURAL
D	DEEP				
DF	DRINKING FOUNTAIN	MAS	MASONRY	TEMP	TEMPERED
DH	DOUBLE HUNG	MATL	MATERIAL	THK	THICK
DIM(S)	DIMENSIONS	MAX	MAXIMUM	THRESH	THRESHOLD
DISP	DISPENSER	MECH	MECHANIC(AL)	T.O.	TOP OF

### E RESISTIVE TOBM TOP OF BEAM DOOR MFR MANUFACTURER T.O.BM. TOP OF BEAM DOWNSPOUT MANHOLE T.O.P. TOP OF PLATE DETAIL MIN MINIMUM T.O.S. TOP OF STEEL TOP OF MISC MISCELLANEOUS MO MASONRY OPENING T&G TONGUE AND GROOVE TELEPHONE EACH THK THICK EXISTING COLUMN N NORTH TRANS TRANSOM EXPANSION JOIN NIC NOT IN CONTRACT TV TELEVISION ELEC ELECTRICAL NOM NOMINAL TYP TYPICAL ELEVATION NTS NOT TO SCALE ELEV ELEVATOR UL UNDERWRITERS LABORATORY UNO UNLESS NOTED OTHERWISE EQUAL OD OUTSIDE DIAMETER OR OVERFLOW EQUIP EQUIPMENT EWC ELECTRIC WATER COOLER DRAIN VINYL BASE EXH EXHAUST OPNG OPENING VINYL COMPOSITION TILE EXIST EXISTING OPP OPPOSITE VERT VERTICAL EXP EXPANSION OR EXPOSED OSB ORIENTED STRAND BOARD VEST VESTIBULE EXT EXTERIOR VENEER PLASTER FACP FIRE ALARM CONTROL PANEL PL PLATE VAPOR RETARDER PLAM PLASTIC LAMINATE FLOOR DRAIN VINYL TILE FIRE EXTINGUISHER PLUMB PLUMBING VWC VINYL WALL COVERING FIRE EXTINGUISHER CABINET PLYWD PLYWOOD FINISH FLOOR PNT PAINT FINISH WITH FIXT FIXTURE POLY POLYESTER OR POLYOLEFIN WC WATER CLOSET FLR FLOOR PSF POUNDS PER SQUARE FOOT WD WOOD FOUNDATION PSI POUNDS PER SQUARE INCH WDW WINDOW FIRE PROTECTION PRESSURE TREATED OR POINT WG WALL GUARD WATER HEATER FRAME FEET/FOOT OR FIRE TREATED QUARTER WATERPROOF FOOTING WATER RESISTANT WEIGHT FIBERGLASS REINFORCED WWF WELDED WIRE FABRIC FRT FIRE RETARDANT TREATED

# The same of the sa TO THE RESIDENCE OF THE PARTY O

### **EXPLANATION OF SYMBOLS**

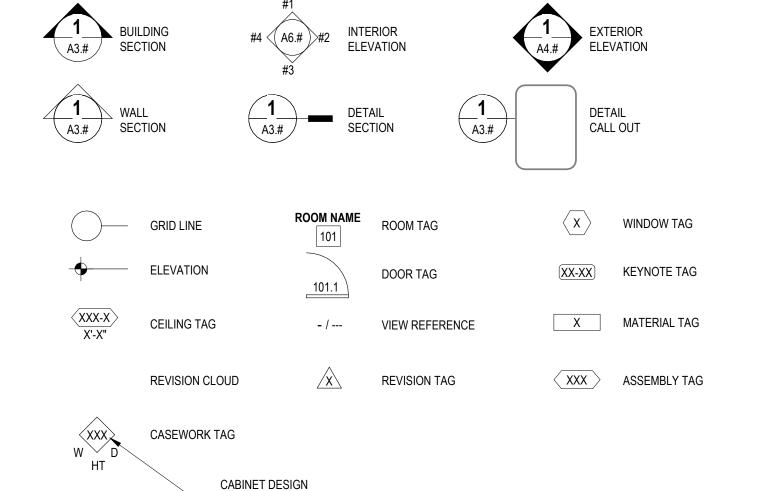

TYPICAL S	HEET VIEW	/ NUMBERI	NG LAYOU	<u>TS</u>
1	2	3	4	
5	6	7	8	
9	10	11	12	
13	14	15	16	

SERIES NO.

- POSITION OF VIEW ON

6 7 8 9 10 11 12 13 14 15	6     7     8     9     10       11     12     13     14     15	1	2	3	4	5
11 12 13 14 15	11 12 13 14 15	6	7	8	9	10
		11	12	13	14	15

### PROJECT SCOPE

DEMOLISH EXISTING TWO STORY PLUS BASEMENT HOUSE, DETACHED GARAGE, POOL HOUSE DRIVEWAYS AND ALL ASSOCIATED HARDSCAPES CONSTRUCT NEW SINGLE STORY 6 BEDROOM HOUSE WITH PARTIAL BASEMENT, ATTACHED TWO CAR CONSTRUCT NEW DRIVEWAY WITH TWO ENTRANCES FROM PEPPER AVENUE, NEW HARDSCAPE PER

### **GENERAL REQUIREMENTS**

ANY HIDDEN CONDITIONS THAT REQUIRE WORK TO BE PERFORMED BEYOND THE SCOPE OF THE

AT THE TIME OF APPLICATION FOR BUILDING PERMIT, A COMPLETED SUPPLEMENTAL DEMOLITION

MECHANICAL EQUIPMENT INSTALLED ON THE EXTERIOR OF THE BUILDING SHALL NOT EXCEED MAXIMUM OUTDOOR NOISE LEVEL (dBA) OF SIXTY (60) dBA DAYTIME (7:00 A.M. - 10:00 P.M.) OR FIFTY

## **FIRE PROTECTION**

APPLICATION WILL BE PROVIDED

A FIRE SPRINKLER SYSTEM IS REQUIRED THROUGHOUT THE HOUSE, ADU AND ATTACHED GARAGE

FROM THE PUBLIC WAY, REFER TO CENTRAL COUNTY FIRE DEPARTMENT APPROVED ALTERNATE

AND HIGH HEAT. PROPOSED WINDOWS ARE ALUMINUM CLAD ON THE EXTERIOR. IMPROVE BUILDING CONSTRUCTION: ALL EAVE VENTS WILL BE ELIMINATED. UNVENTED ROOF

SLOPED ROOFS WILL BE STEEL STANDING SEAM, 0.016 INCH MIN. THICKNESS WITH FIRE RATED

FLAT ROOFS WILL BE EPDM WITH TWO LAYERS OF GAF VERSASHIELD OR EQUAL, ACHIEVING A CLASS A ROOF ASSEMBLY.

### **CODE INFORMATION**

GOVERN	IING CODES:	2022 CALIFORNIA BUILDING CODE 2022 CALIFORNIA RESIDENTIAL CODE 2022 CALIFORNIA MECHANICAL CODE 2022 CALIFORNIA ELECTRICAL CODE 2022 CALIFORNIAL PLUMBING CODE, INCLUDING ALL AMENDMENTS AS ADOPTED IN ORDINANCE 1889 BURLINGAME MUNICIPAL CODE
CONSTR	EUCTION TYPE:	VB
FIRE SP	RINKLERS:	YES

PRIVATE GARAGE

SINGLE FAMILY RESIDENCE AND ADU

### ARCHITECTURAL DRAWINGS

SHEET NO.	SHEET NAME
A001 A002	COVER SHEET SITE CONTEXT PLANS
SHEET NO.	SHEET NAME
C1	TOPOGRAPHIC SURVEY
SHEET NO.	SHEET NAME
A100 A101 A102 A200 A201 A202 A210 A230 A300 A310 A311 A312 A313 A314 A320 A320 A321 A400 A401	SITE PLAN EXISTING SITE PLAN AREA DIAGRAMS AND CALCULATIONS MAIN LEVEL PLAN ENLARGED FLOOR PLANS ENLARGED FLOOR PLANS BASEMENT PLAN ROOF PLAN PERSPECTIVES OVERALL EXTERIOR ELEVATIONS EXISTING BUILDING EXTERIOR ELEVATIONS BUILDING SECTIONS BUILDING SECTIONS
SHEET NO.	SHEET NAME
L100	SITE LANDSCAPE PLAN

PROPERTY INFORMATION

32,580 SF

BURLINGAME, CA 94010

**PROJECT ADDRESS**: 121 PEPPER AVENUE,

**ASSESSOR'S PARCEL #**: 028-274-210

# MISTELE-RAFANELLI RESIDENCE

# RECEIVED

5.13.25

CITY OF BURLINGAME CDD-PLANNING DIVISION

121 PEPPER AVE BURLINGAME, CA 94010

ISSUE DATE: 02/11/2025

SATURDAYS: 9:00 A.M. - 6:00 P.M. SUNDAYS AND HOLIDAYS: NO WORK ALLOWED **CONSTRUCTION HOURS** 

**CONSTRUCTION HOURS** 

IN CITY PUBLIC R.O.W.: WEEKDAYS AND NON-CITY HOLIDAYS 8:00 A.M. - 5:00 P.M. THE THIRD MONDAY IN JANUARY

THE THIRD MONDAY IN FEBRUARY THE LAST MONDAY IN MAY THE SECOND MONDAY IN OCTOBER THE FOURTH THURSDAY IN NOVEMBER

DECEMBER 25 REFER TO CITY OF BURLINGAME MUNICIPAL CODE, SECTION 18.07.110 AND 13.04.100 FOR ADDITIONAL DETAILS

### A&E PROJECT NUMBER: 24045

# **PROJECT TEAM**

**CIVIL ENGINEER** 

OWNER **COLIN MISTELE AND KATHERINE RAFANELLI** 

**ARCHITECT A&E DESIGN COLLECTIVE** 124 N 29TH ST. SUITE 100 BILLINGS, MT 59101-2079 JOHN PHILLIPS, PROJECT MANAGER (406) 721-5643 BURLINGAME BUSINESS LIC. #: 20508462

**MECHANICAL ENGINEER** STRUCTURAL ENGINEER

CONTRACTOR

**SURVEYOR** QUIET RIVER LAND SERVICES, INC. 11501 DUBLIN BLVD. SUITE 200 DUBLIN, CA 94568 (925) 734-6788

**ELECTRICAL ENGINEER** 



RESIDENCE E, CA 94010 APN: 0

05/12/2025

SCHEMATIC DESIGN

FOR CONSTRUCTION



105 PEPPER AVENUE ORIGINAL DATE OF CONSTRUCTION: 1927

133 PEPPER AVENUE

ORIGINAL DATE OF CONSTRUCTION: 1924



109 PEPPER AVENUE

ORIGINAL DATE OF CONSTRUCTION: 1928 EXAMPLE HOUSE

141 PEPPER AVENUE ORIGINAL DATE OF CONSTRUCTION: 1887



111 PEPPER AVENUE

ORIGINAL DATE OF CONSTRUCTION: 1911 EXAMPLE HOUSE

ORIGINAL DATE OF CONSTRUCTION: 1936

125 PEPPER AVENUE ORIGINAL DATE OF CONSTRUCTION: 1920



124

104



121 PEPPER AVENUE EXISTING (SUBJECT PROPERTY)



124 PEPPER AVENUE

PROPERTY LINE SET BACK FROM ROAD AREA OF INFLUENCE PROJECT PROPERTY EXISTING FOOTPRINT EXISTING SURROUNDING HOUSES

SITE CONTEXT LEGEND

MEANING

SYMBOL

RESIDENCE

phase
SCHEMATIC DESIGN
PRICING SET - NOT
FOR CONSTRUCTION



issue date 02/11/2025

EXISTING NEIGHBORHOOD CONTEXT PHOTOS

SITE PLAN AREA OF INLUENCE

1" = 50'-0"

112 PEPPER AVENUE

ORIGINAL DATE OF CONSTRUCTION; 1924

141

133

125

121

111

ORIGINAL DATE OF CONSTRUCTION: 1932

### FOUND NAIL & SHINER — TOPOGRAPHIC SURVEY LS 20858 LANDS OF RAFANELLII LOT 8 & PORTION OF LOT 13, BLOCK 1 ×71.7 MAP OF SUBDIVISION NO. 3 BURLINGAME PARK (GRANT DEED #2023-0061521-ROSSELLI TRUST) 121 PEPPER AVENUE ×72.7 **CALIFORNIA** CITY OF BURLINGAME SAN MATEO COUNTY SCALE: 1" = 15'CLEANOUT MARCH 2024 24.0 9"ø PEPPER TREE -(37 LLS 58) 6"ø BIRCH TREE 8"ø BIRCH TREE 11501 Dublin Boulevard, Suite 200 SCALE: 1" = 15'Dublin, CA 94568 LANDS OF SANTERO (925) 734-6788 Phone LOT 7 APN: 028-274-030 125 PEPPER AVENUE HOUSE TOP EL: 90.3± PINE TREE BOARDER BASIS OF BEARINGS $\times$ 74.2 WATER FEATURE W/ STONE -RECORD OF SURVEY 3357 FILED IN BOOK 47 OF LICENSED LAND SURVEYOR'S WALKWAY 2.5'ø MAPS AT PAGE 60, RECORDS OF SAN MATEO COUNTY, AND TWO FOUND MONUMENTS AS SHOWN. $\times$ 74.1 BASIS OF ELEVATION 1'ø TREE CONCRETE DRIVEWAY THE ELEVATIONS SHOWN HEREON WERE DERIVED FROM L-1/L-2 DATA COLLECTED USING NAVSTAR GLOBAL POSITIONING SYSTEM (GPS) AND A IGAI73 4.0'ø RECEIVER AND POST-PROCESS USING THE CORS NETWORK. ALL ELEVATION PINE TREE FLEX DRAIN PIPE EXPRESSED IN NAVD 1988 DATUM. BRICK, HT. 0.8'± RETAINING -PROPERTY BOUNDARY NOTE & WALL ELECTRICAL -ROCK BORDER FRONT DOOR THIS IS NOT A PROPERTY BOUNDARY SURVEY THIS MAP REFLECTS A FF EL: 77.48 TOPOGRAPHIC SURVEY OF THE SUBJECT PARCEL. PROPERTY MONUMENTS WERE NOT REQUESTED AND NONE WERE SET. THE PROPERTY BOUNDARY LINE AND PARCEL AREA DATA AS SHOWN HEREON IS FOR INITIAL PLANNING FF EL: 77.50 PURPOSES ONLY AND ARE NOT FINAL, AS PER AGREEMENT. THE LINES AS LANDS OF RAFANELLII SHOWN REFLECT RECORD INFORMATION AND AVAILABLE DATA FOR THE LOT 8 & PTN. LOT 13, BLOCK 1 SUBJECT PARCEL AND RIGHT-OF-WAY LINES. MAP OF SUBDIVISION NO. 3 BURLINGAME PARK - RETAINING (3 M 84) BACK FLOW APN: 028-274-210 MAP OF SUBDIVISION \ NO. 3 PREVENTION DEVICE 121 PEPPER AVENUE BURLINGAME PARK, 32,580± SQUARE FEET BLOCK 1 (3 M 84) 1.) THIS MAP IS NOT A PROPERTY BOUNDARY SURVEY, THIS IS TOPOGRAPHY HOSE BIB -PLANTER, MAP. NO PROPERTY CORNER MONUMENTS WERE SET FOR THIS PROJECT. TRÉES 2.) NO TITLE REPORTS WERE SUPPLIED FOR THIS PROJECT AND ONLY LIMITED CHAIN LINK PROPERTY/DEED RESEARCH WAS DONE, CONSEQUENTLY EASEMENTS OF 6"ø TREE, FOUND 1.5**'**ø RECORD, IF ANY, AND ANY RECENT CHANGES IN LAND PARCEL NAIL & SHINER -(TYPICAL 3) BOUNDARIES WILL NOT BE REFLECTED HEREON. UNDERGROUND UTILITY LINES PLANTER -LS 20858 TYPICAL WERE NOT LOCATED FOR THIS SURVEY. LIGHT & ICV -LANDS OF PROCK 3.) DATE OF FIELD SURVEY: MARCH 4 & 7, 2024 PTN. LOT 14 APN: 028-274-170 4.) PROJECT BENCHMARK: SET NAIL AND SHINER IN ASPHALT LOCATED 120 ELM AVENUE 6"ø ORANGE SOUTHWEST OF POOL HOUSE SHOWN AS TBM HAVING AN ELEVATION OF MAP OF SUBDIVISION NO. 3 78.94 AMSL(NAVD88). B U R L I N G A M E P A R K BLOCK 1 (3 M 84) 6"ø TREE, \_6"ø ORANGE ×74. (TYPICAL 3) SURVEYOR'S STATEMENT TOP EL: 99.0± I, KEVIN M. MCGUIRE, A REGISTERED PROFESSIONAL LAND SURVEYOR DULY LICENSED BY THE LAWS OF THE STATE OF CALIFORNIA DO HEREBY STATE THAT THE TOPOGRAPHY, SPOT ELEVATIONS, LOCATIONS OF IMPROVEMENTS AS LANDS OF MITTLER CONCRETE WALL PTN. LOT 9 APN: 028-274-050 SHOWN, ARE BASED UPON A FIELD SURVEY PERFORMED MARCH 4 & 7, 2024 111 PEPPER AVENUE BY OUR COMPANY FIELD CREW; AND I FURTHERMORE DO STATE THAT THE PROPERTY BOUNDARY LINES, RIGHTS-OF-WAY AND EASEMENTS, IF ANY, ARE PAVER DRIVEWAY BASED UPON ITEMS OF PUBLIC RECORD AND FIT TO FOUND MONUMENTS AS $\times$ 78.7 W/ LIGHT SHOWN AND REFERENCED HEREON. THIS MAP AND THE ITEMS AND CHAIN LINK INFORMATION AS SHOWN, WERE DONE UNDER MY SUPERVISION AND DIRECTION AND ARE TRUE AND ACCURATE TO THE BEST OF MY KNOWLEDGE AND BELIEF. - CLEANOUT WOOD POST, -GARAGE KEVIN M. McGUIRE FF EL: 78.0 OUTLET, -HB & ICV × 78.6 PAVER ARCHWAY CONCRETE - WOOD POST, WALKWAY POOL HOUSE **APPROXIMATE** DATE TYPICAL PARCEL LINE SEE W/ WOOD FENCE "PROPERTY BOUNDARY NOTE" AREA APPEARS TO POST & ROOF BE CONCRETE PATH\_ STRUCTURE FOR USE BY CHAIN LINK 110 ELM AVENUE (LEANING) LEGEND LANDS OF ADUSUMILLI LANDS OF ROTH PTN. LOT 13 PTN. LOT 11 APN: 028-274-150 AREA DRAIN SUBJECT PROPERTY LINE APN: 028-274-110 110 ELM AVENUE CONCRETE ASSESSOR'S PARCEL NUMBER ——— — — ADJOINER PROPERTY LINE 1812 BARROILHET AVENUE CP CONTROL POINT X — X — X — EXISTING FENCE LINE BLOCK WALL LIGHT & CLEANOUT W/ FENCE AREA DRAIN OUTLET CONC. CONCRETE HOSE BIB ELEVATION CHAIN LINK FENCE FND. FOUND VALVE AS NOTED LANDS OF MENDELSON W/ WOOD SLATS HEIGHT PTN. LOT 11 MANHOLE APN: 028-274-120 IRRIGATION CONTROL VALVE 1816 BARROILHET AVENUE CATCH BASIN HOSE BIB N 54°51'30" E 2.62' (37 LLS 58) WATER METER SPOT ELEVATION ලා GAS METER SURVEY CONTROL POINT LANDS OF HOWIE LIGHT PROJECT BENCHMARK PTN. LOT 12 APN: 028-274-130 1824 BARROILHET AVENUE


# **EXTISTING PLAN NOTES**

EXISTING HOUSE TO BE REMOVED IN ITS ENTIRETY

EXISTING GARAGE TO BE REMOVED IN ITS ENTIRETY

EXISTING POOL HOUSE TO BE REMOVED IN ITS ENTIRETY

EXISTING SWIMMING POOL AND SURROUNDING HARDSCAPE TO BE REMOVED IN ITS ENTIRETY

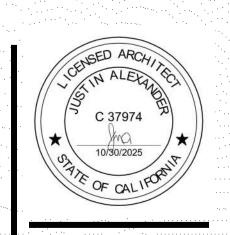

sheet SITE PLAN EXISTING


project MISTELE-RAFANELLI RESIDENCE
121 PEPPER AVE. BURLINGAME, CA 94010 APN:

project # 2404

revision date


phase
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FOR CONSTRUCTION




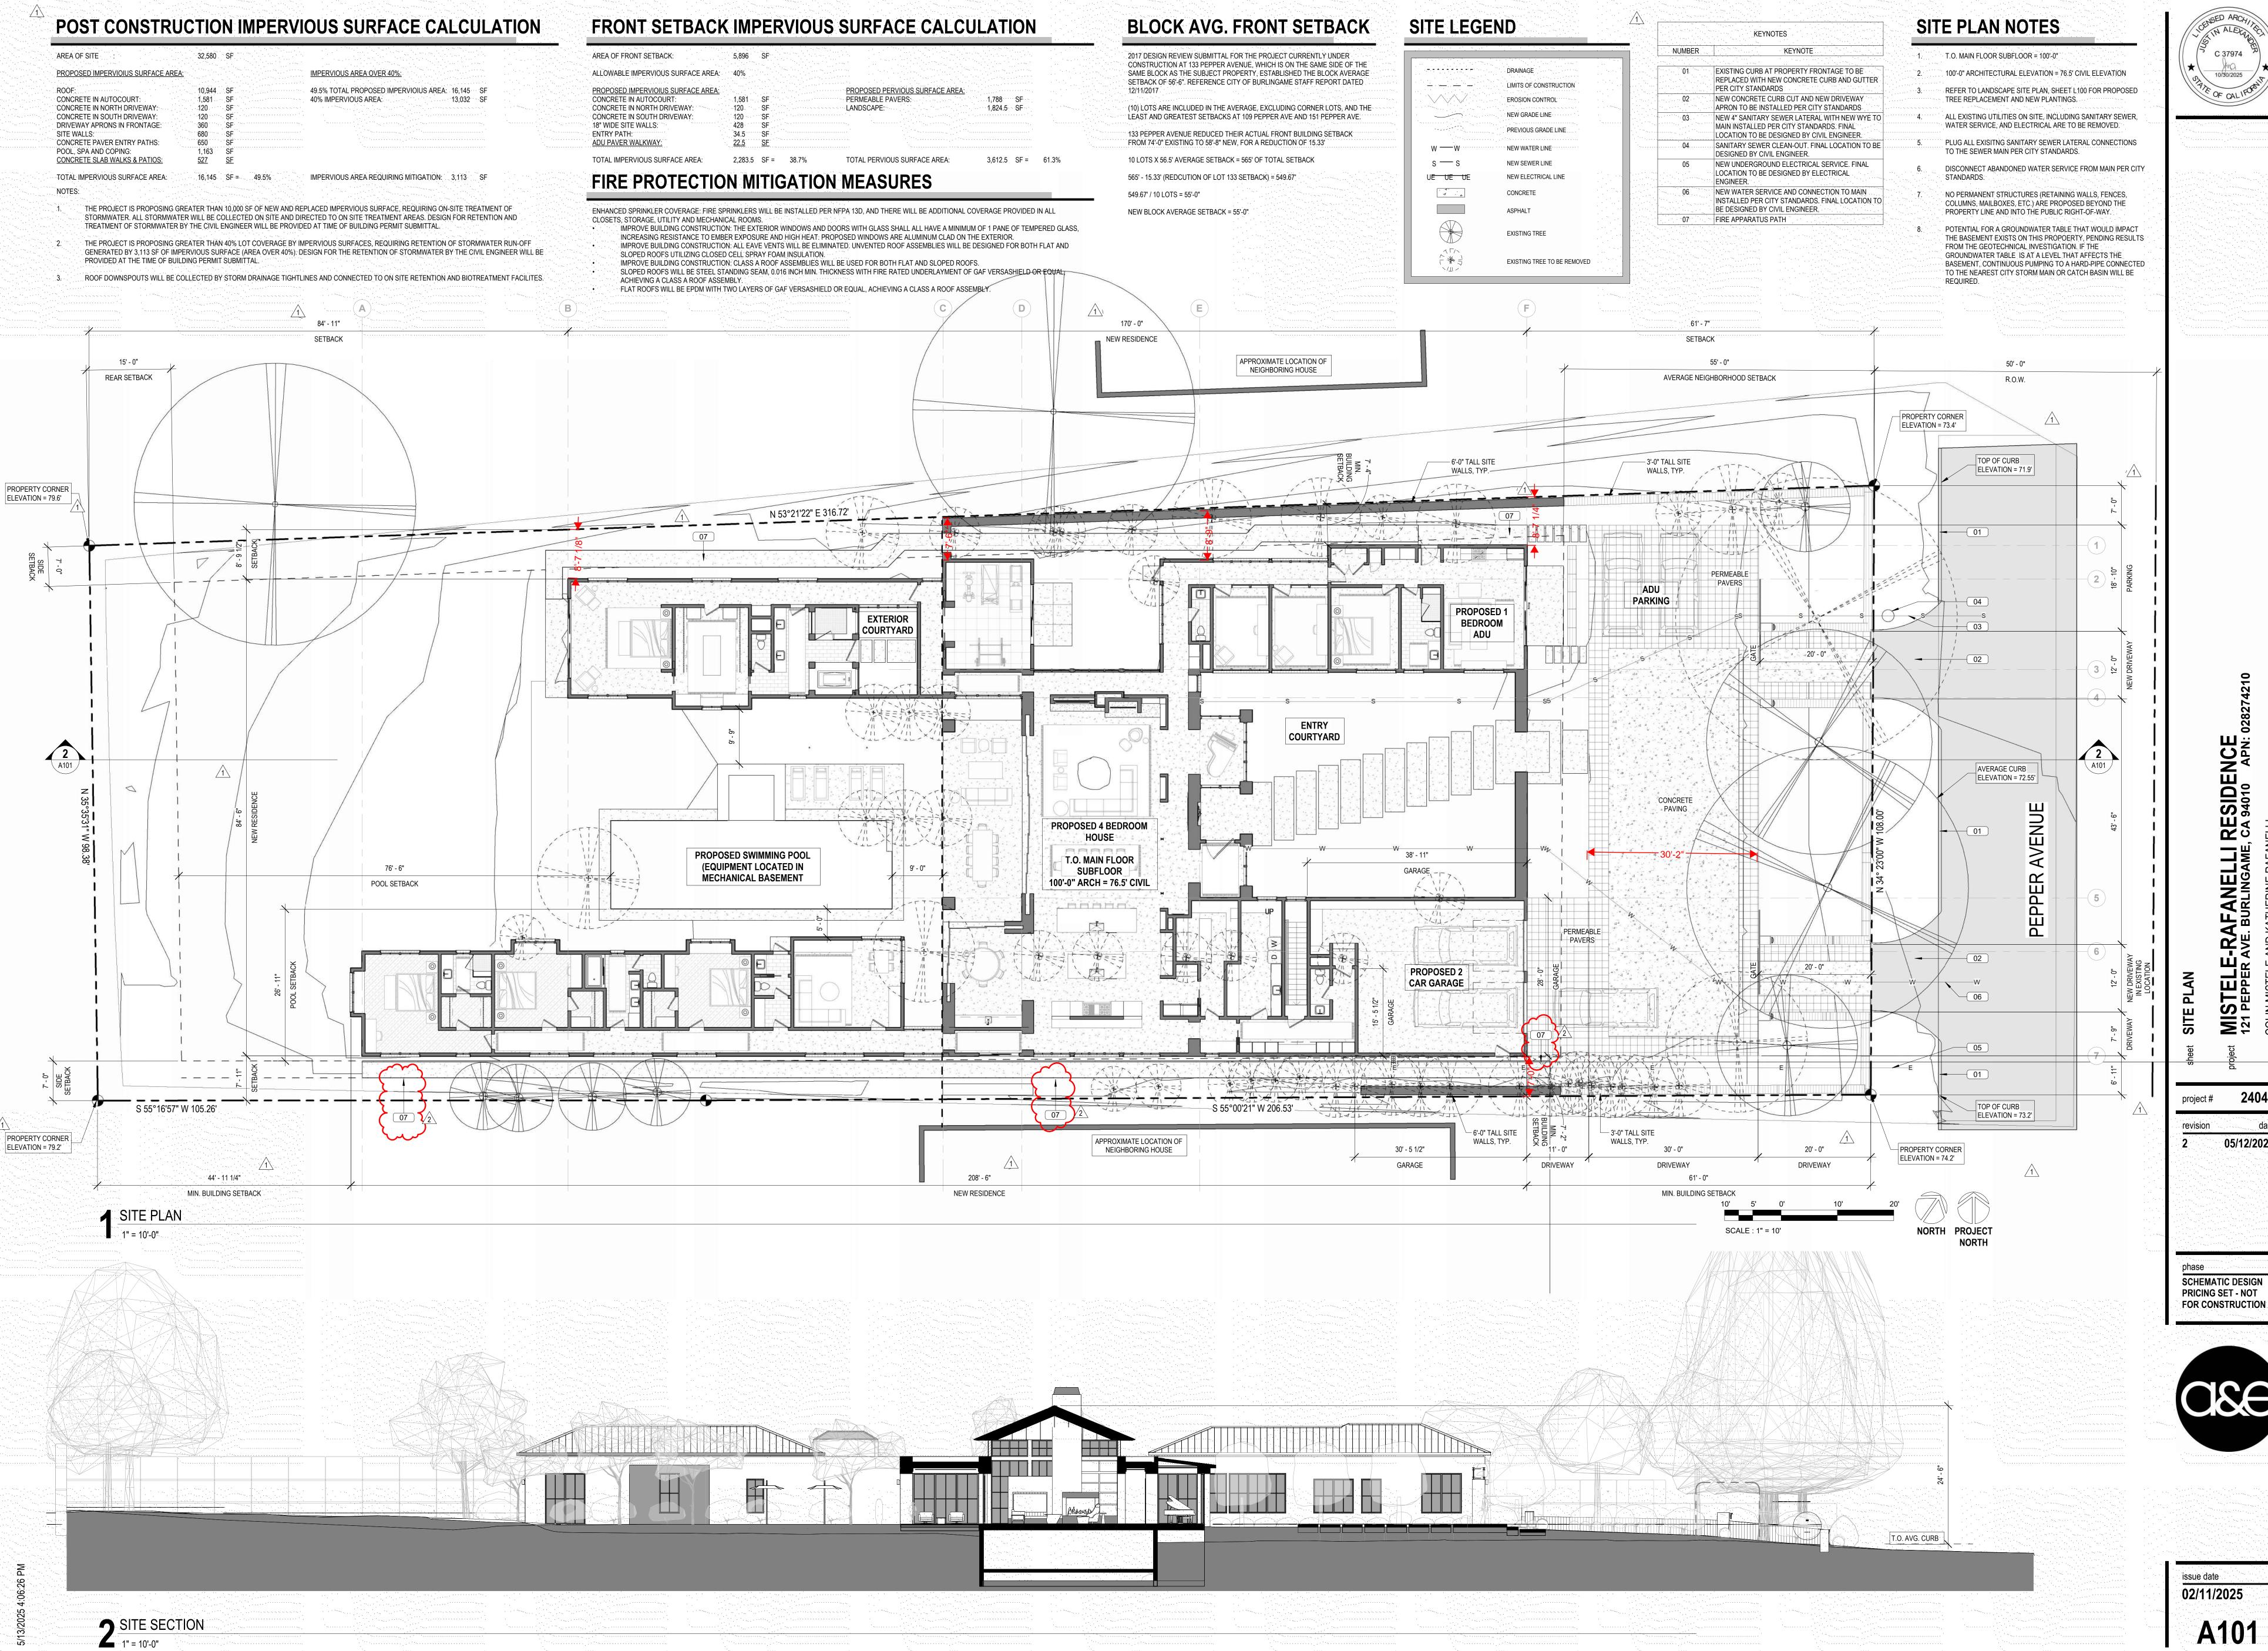

05/12/2025



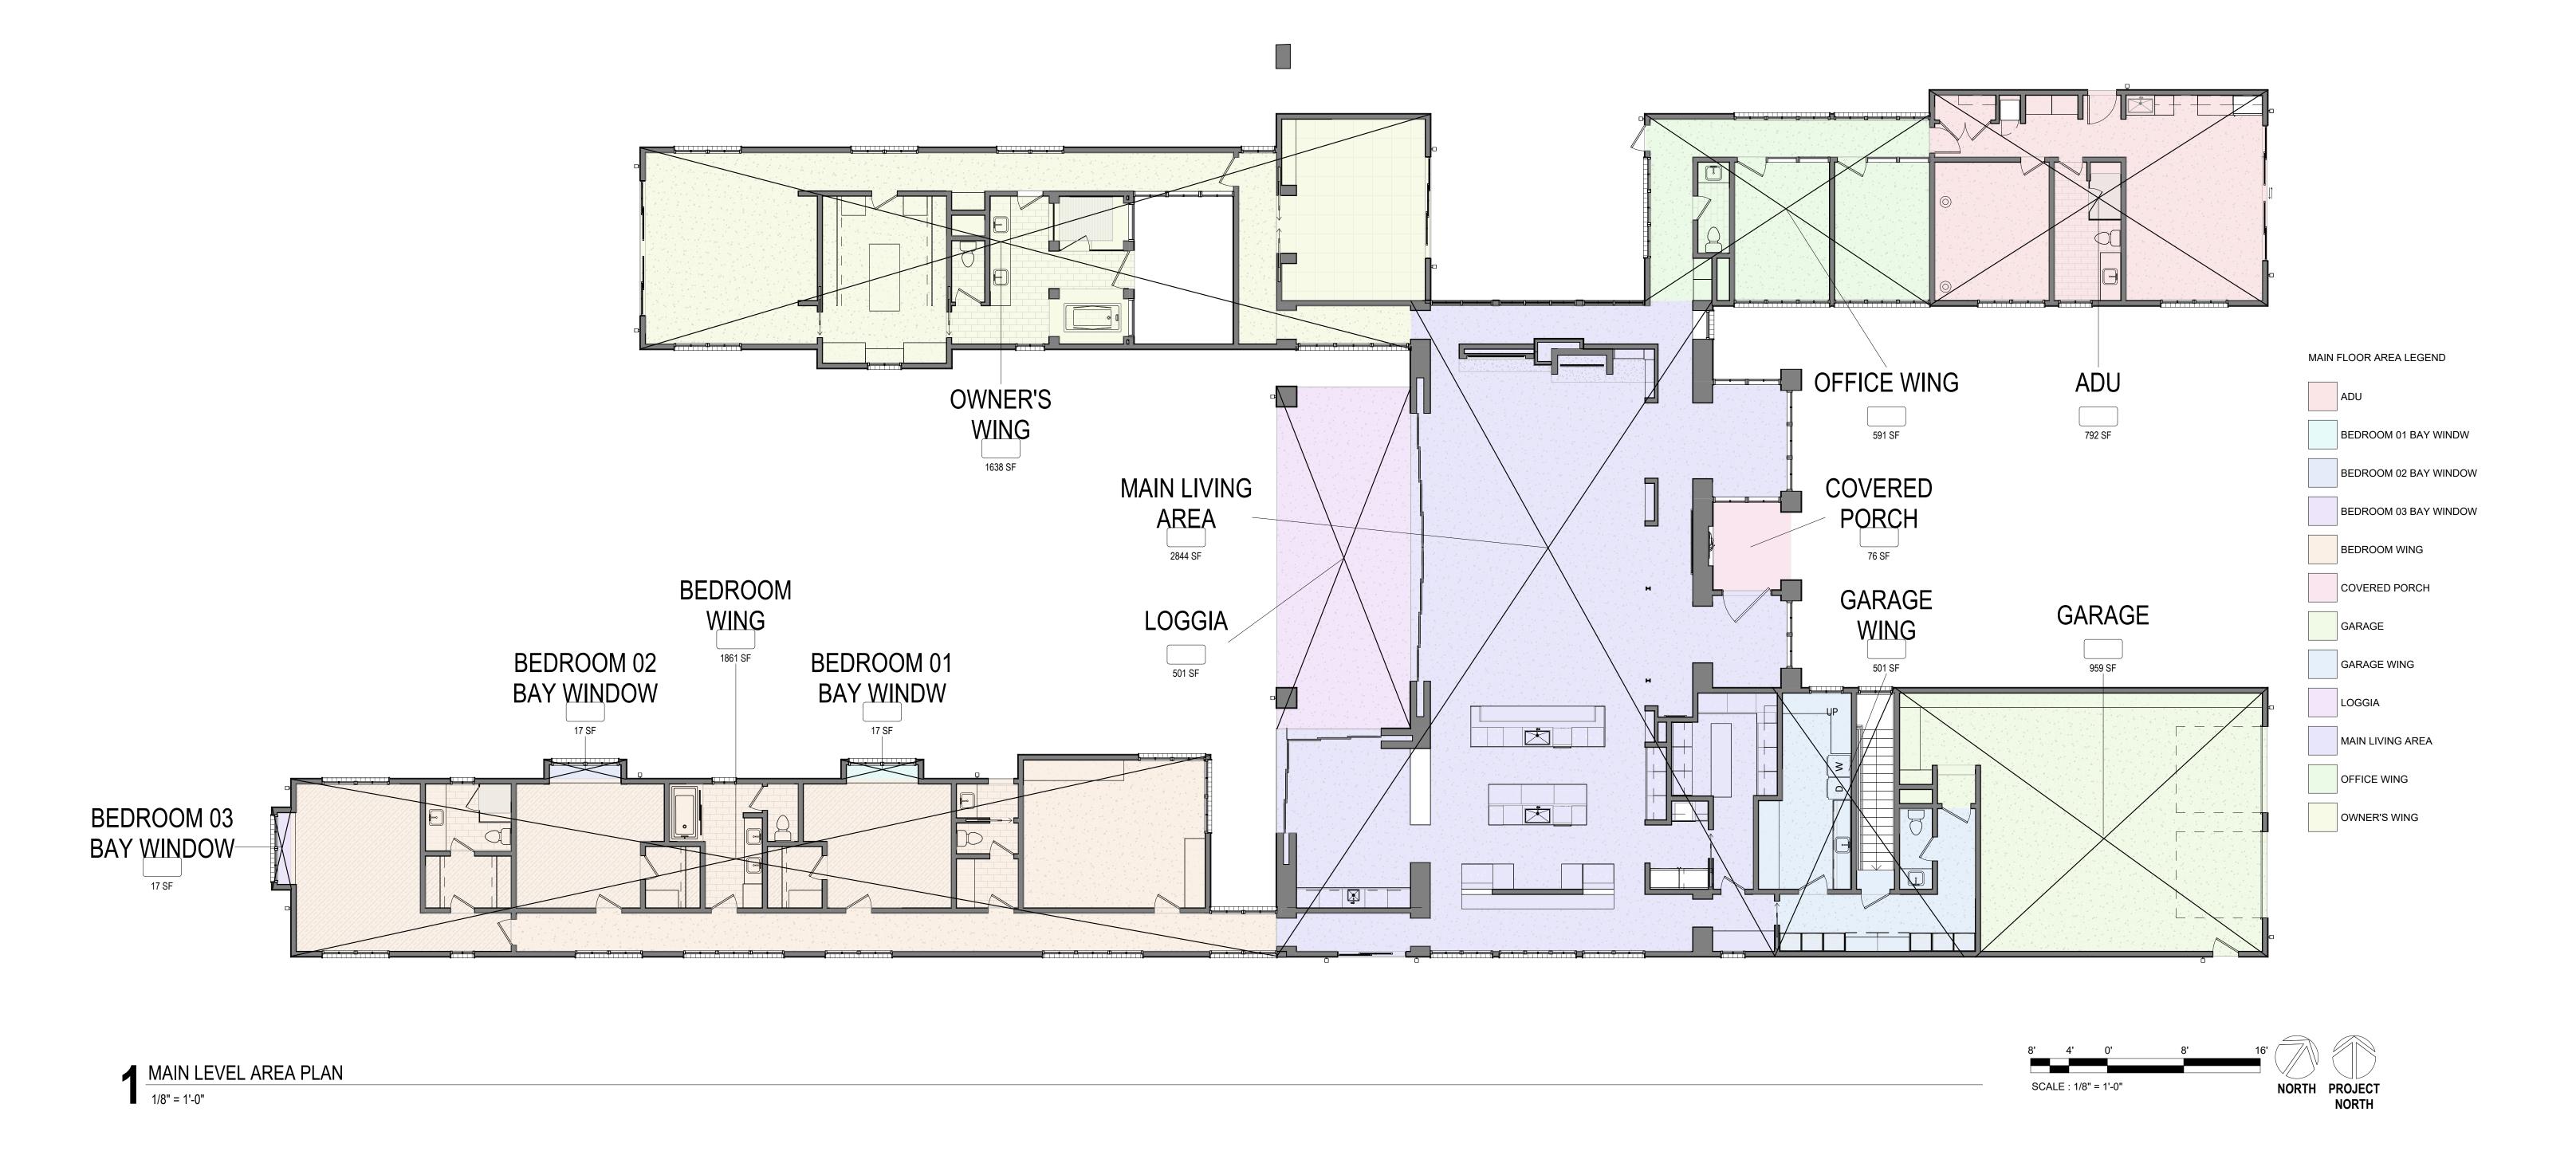

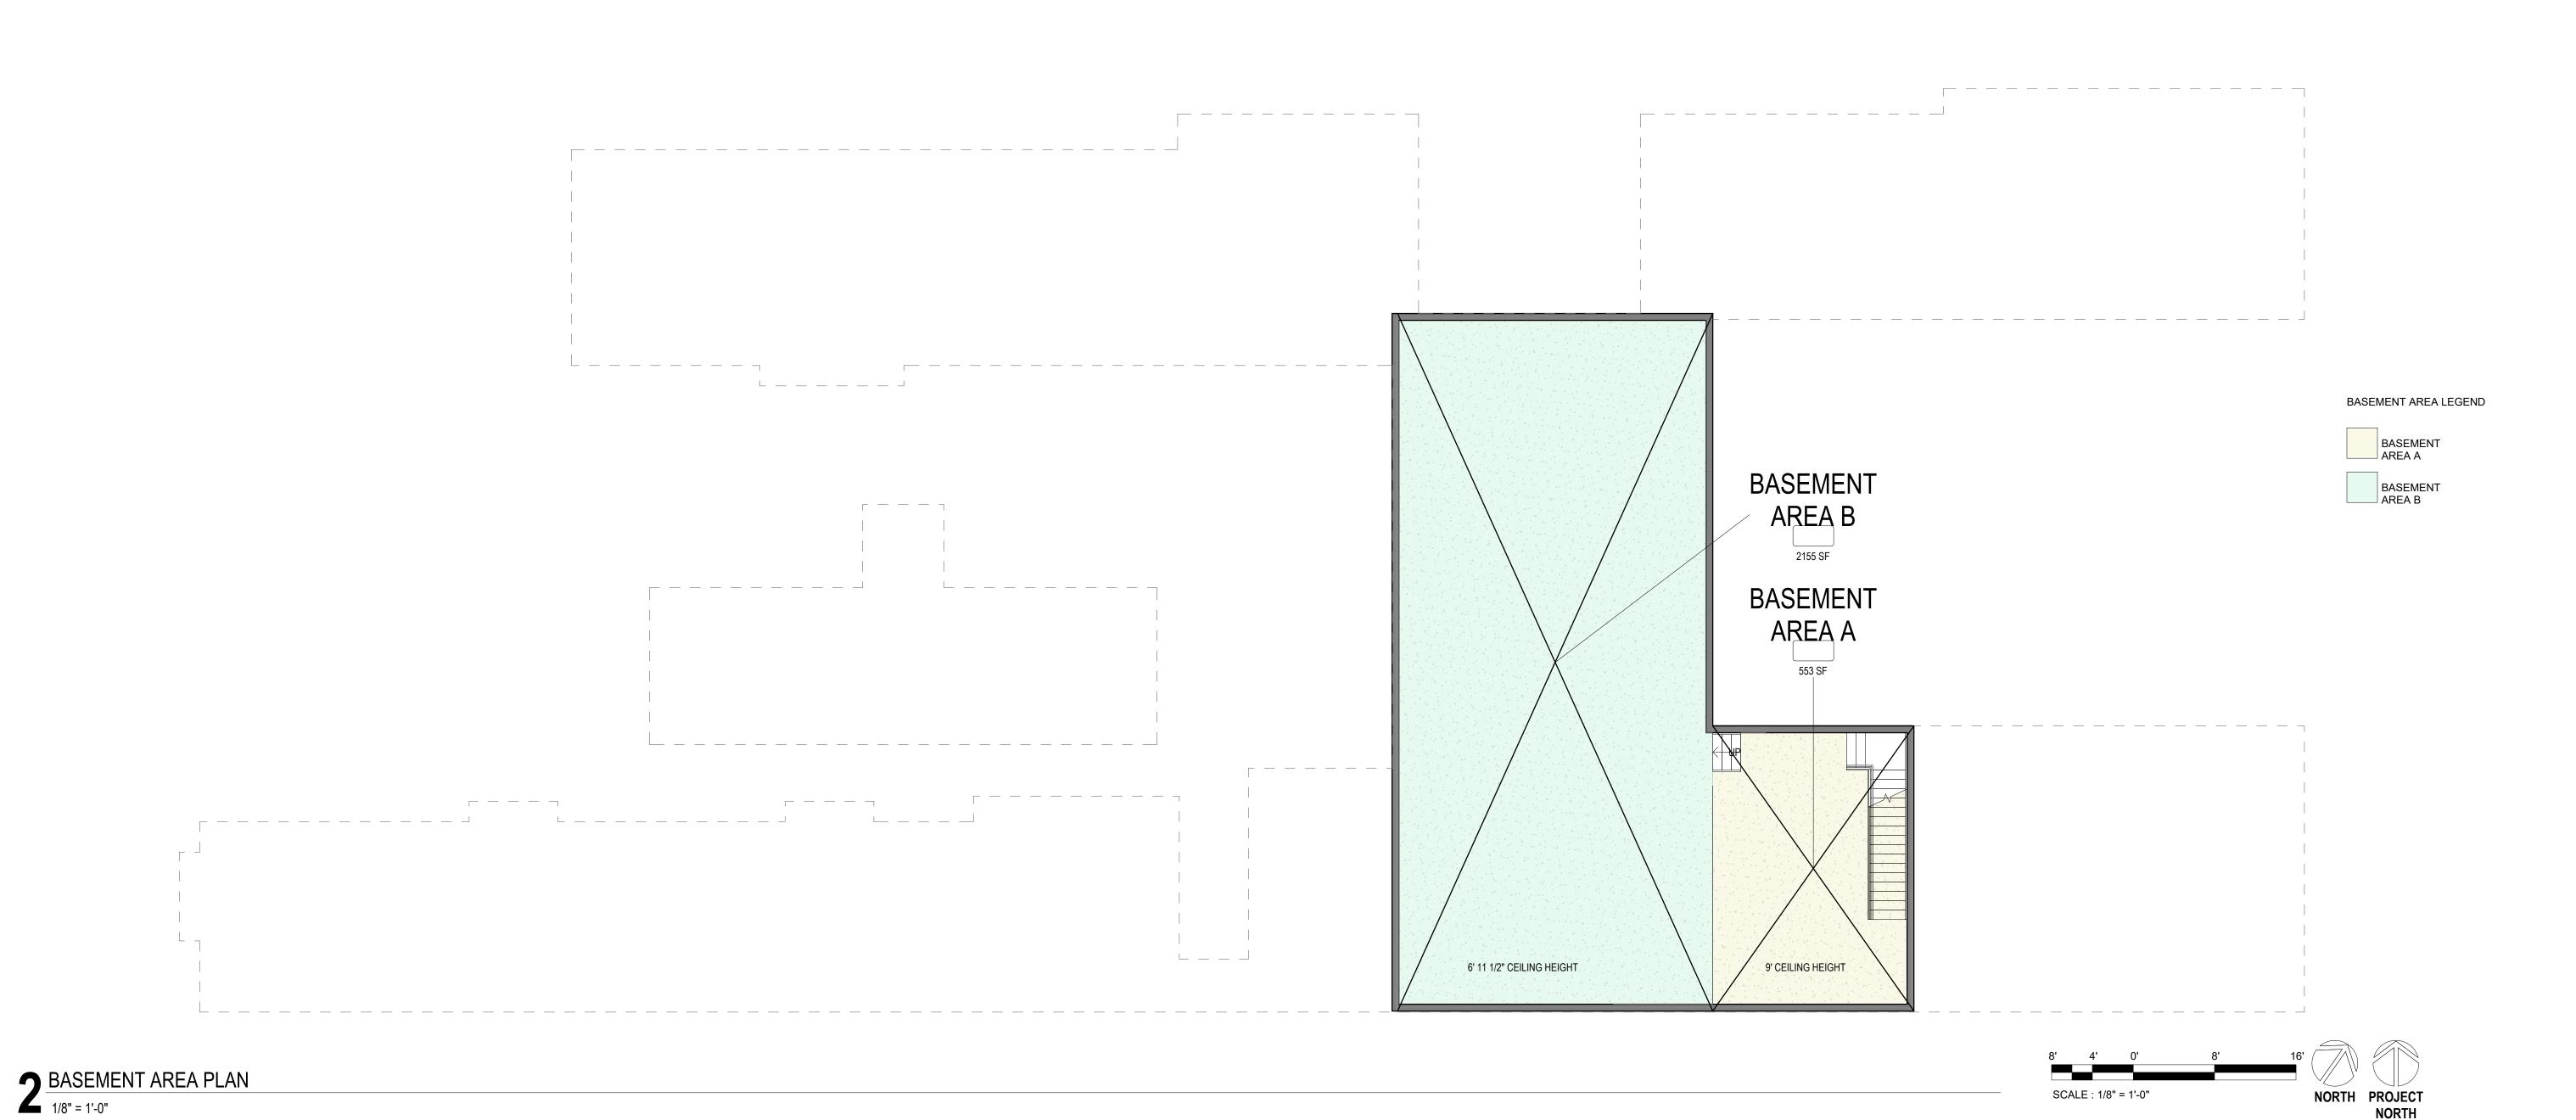

	LOT COVERAGE	
AREA (SF)	AREA DESIGNATION	CODE INCLUS
		1
792 SF	ADU	EXCLUDED
553 SF	BASEMENT AREA A	EXCLUDED
2155 SF	BASEMENT AREA B	EXCLUDED
17 SF	BEDROOM 01 BAY WINDW	EXCLUDED
17 SF	BEDROOM 02 BAY WINDOW	EXCLUDED
17 SF	BEDROOM 03 BAY WINDOW	EXCLUDED
3551 SF		ı
1861 SF	BEDROOM WING	INCLUDED
76 SF	COVERED PORCH	INCLUDED
959 SF	GARAGE	INCLUDED
501 SF	GARAGE WING	INCLUDED
501 SF	LOGGIA	INCLUDED
2844 SF	MAIN LIVING AREA	INCLUDED
591 SF	OFFICE WING	INCLUDED
1638 SF	OWNER'S WING	INCLUDED

FLOOR AREA					
AREA (SF)	AREA DESIGNATION	CODE INCLUSION OR EXCLUSION			
792 SF	ADU	EXCLUDED			
553 SF	BASEMENT AREA A	EXCLUDED			
2155 SF	BASEMENT AREA B	EXCLUDED			
17 SF	BEDROOM 01 BAY WINDW	EXCLUDED			
17 SF	BEDROOM 02 BAY WINDOW	EXCLUDED			
17 SF	BEDROOM 03 BAY WINDOW	EXCLUDED			
76 SF	COVERED PORCH	EXCLUDED			
3627 SF	<u>'</u>				
1861 SF	BEDROOM WING	INCLUDED			
959 SF	GARAGE	INCLUDED			
501 SF	GARAGE WING	INCLUDED			
501 SF	LOGGIA	INCLUDED			
2844 SF	MAIN LIVING AREA	INCLUDED			
591 SF	OFFICE WING	INCLUDED			
1638 SF	OWNER'S WING	INCLUDED			

	AREA	CODE INCLUS
AREA (SF)	DESIGNATION	OR EXCLUSION
792 SF	ADU	EXCLUDED
553 SF	BASEMENT AREA A	
2155 SF	BASEMENT AREA B	EXCLUDED
17 SF	BEDROOM 01 BAY WINDW	EXCLUDED
17 SF	BEDROOM 02 BAY WINDOW	EXCLUDED
17 SF	BEDROOM 03 BAY WINDOW	EXCLUDED
76 SF	COVERED PORCH	EXCLUDED
959 SF	GARAGE	EXCLUDED
4585 SF		
1861 SF	BEDROOM WING	INCLUDED
501 SF	GARAGE WING	INCLUDED
501 SF	LOGGIA	INCLUDED
2844 SF	MAIN LIVING AREA	INCLUDED
591 SF	OFFICE WING	INCLUDED
1638 SF	OWNER'S WING	INCLUDED
7936 SF		

AREA CALO	CULATIONS
LOT CO	VERAGE
ALLOWABLE LOT COVE	RAGE PERCENTAGE 40%
TOTAL SITE AREA	32,580 SF
LOT COVERAGE	8,971 SF
LOT COVERAGE %	27.5%
FLOOR AF	 REA RATIO
ALLOWABLE FAR = 32% F	PLUS 1,100 SF = 11,426 SF
TOTAL SITE AREA	32,580
TOTAL FLOOR AREA	8,895 SF
FLOOR AREA RATIO	27.3%
UNIT	SIZE
ALLOWABLE UN	NIT SIZE 8000 SF
TOTAL UNIT SIZE	7,936 SF

CLUSION LUSION 8971 SF

AREA (SF)	AREA DESIGNATION	OR EXCLUSION
792 SF	ADU	EXCLUDED
553 SF	BASEMENT AREA A	EXCLUDED
2155 SF	BASEMENT AREA B	EXCLUDED
17 SF	BEDROOM 01 BAY WINDW	EXCLUDED
17 SF	BEDROOM 02 BAY WINDOW	EXCLUDED
17 SF	BEDROOM 03 BAY WINDOW	EXCLUDED
76 SF	COVERED PORCH	EXCLUDED
959 SF	GARAGE	EXCLUDED
4585 SF		
1861 SF	BEDROOM WING	INCLUDED
501 SF	GARAGE WING	INCLUDED
501 SF	LOGGIA	INCLUDED
2844 SF	MAIN LIVING AREA	INCLUDED
591 SF	OFFICE WING	INCLUDED
1638 SF	OWNER'S WING	INCLUDED
7936 SF		

LO1 00	VLIVAOL	5
LOT COVER	RAGE PERCENTAGE 40%	
ΕA	32,580 SF	$\stackrel{>}{\sim}$
	8,971 SF	5
: %	27.5%	Ĭ
		$\overline{\Box}$
FLOOR AF	REA RATIO	AREA DIAGRAM
FAR = 32% F	PLUS 1,100 SF = 11,426 SF	Ш
ΕA	32,580	کے
REA	8,895 SF	⋖
ATIO	27.3%	يد
		sheet
UNIT	SIZE	S
OWABLE UN	IIT SIZE 8000 SF	
E	7,936 SF	
		projec



1. FIELD VERIFY ALL DIMENSIONS: DO NOT SCALE DRAWINGS. 2. DIMENSIONS ARE FROM FACE OF FOUNDATION, CENTER OF COLUMN,

CENTER OF ROUGH OPENING, OR FACE OF WALL FRAMING/STRUCTURE,

3. GENERAL CONTRACTOR SHALL COORDINATE ALL ASPECTS OF THE BUILDING CONSTRUCTION



NEW WALL


1 HOUR FIRE RATED WALL ASSEMBLY: UL U305: 5/8" GYPSUM PANEL O/ 2X6 WOOD STUDS W/ 6 1/4" FIBERGLASS INSULATION O/ 5/8" GYPSUM PANEL FLOORING TYPE 'A' PER SPEC -POLISHED CONCRETE INTERIOR TOP-CAST CONCRETE EXTERIOR EPOXY COATED CONCRETE BASEMENT FLOORING TYPE 'C' - TILE FLOORING TYPE 'E' - RUBBER FLOORING

MISTELE-RAFANELLI RESIDENCE 121 PEPPER AVE. BURLINGAME, CA 94010 APN:


05/12/2025





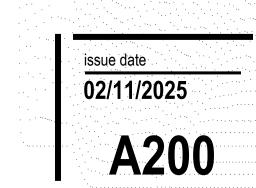


NORTH PROJECT

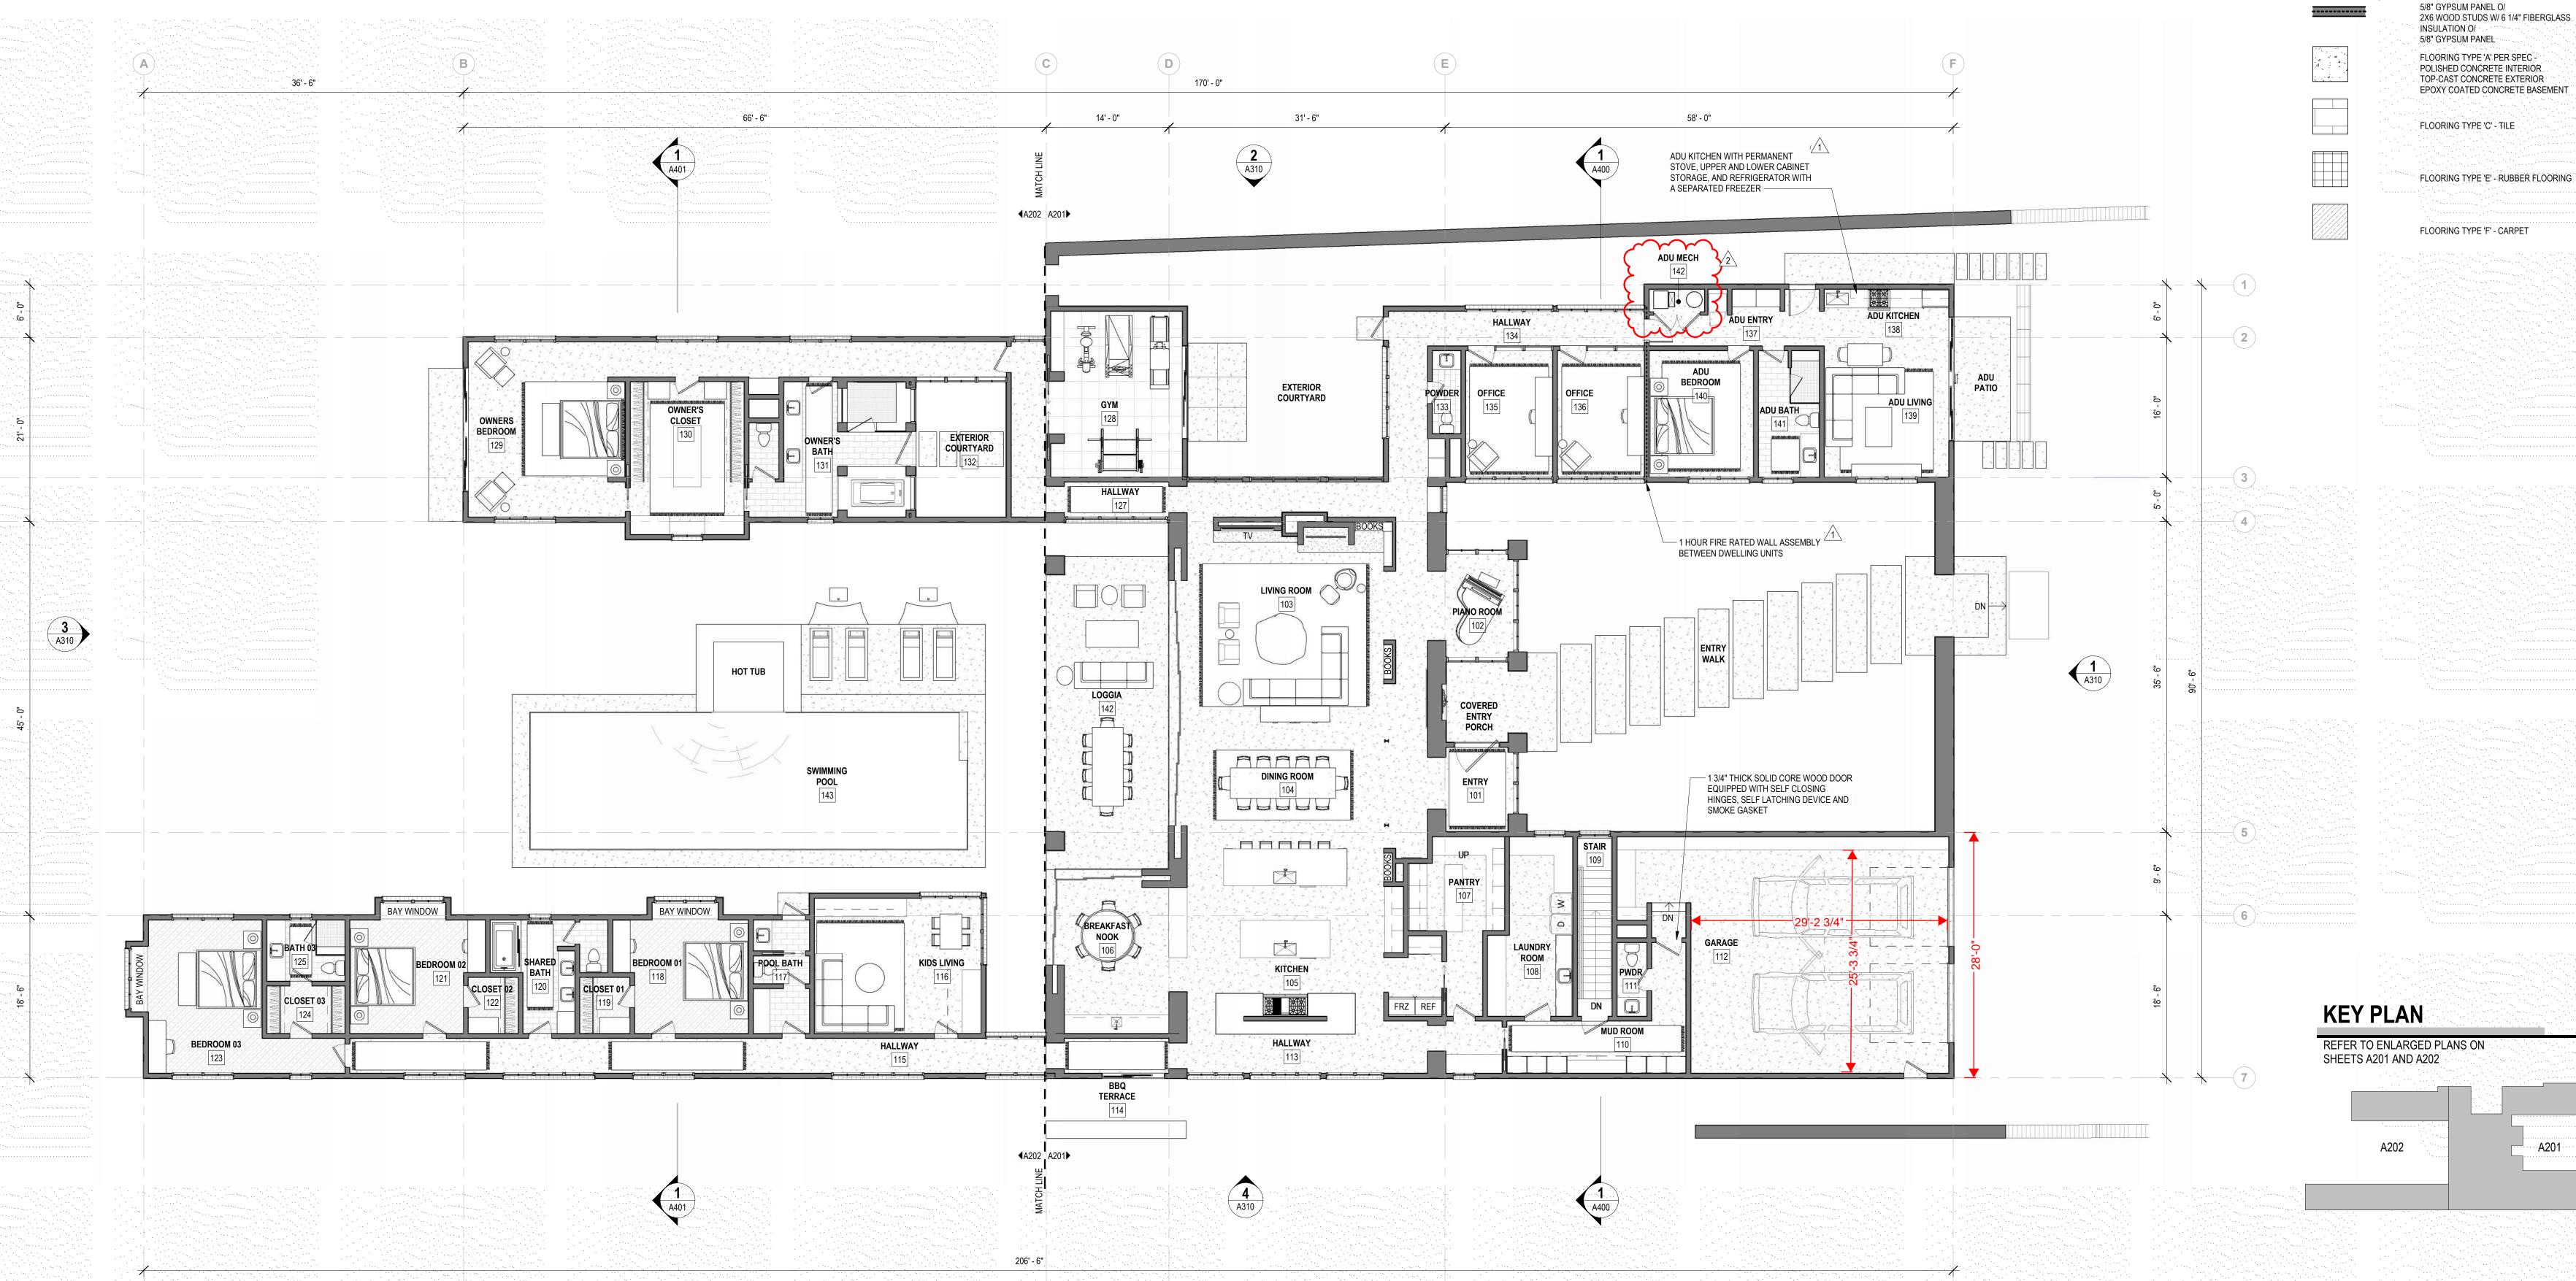

MAIN LEVEL FLOOR PLAN

1/8" = 1'-0"



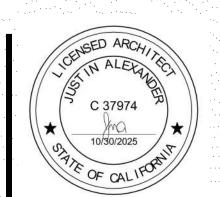


MISTELE-RAFANELLI RESIDENCE
121 PEPPER AVE. BURLINGAME, CA 94010 APN: 0282742
SOLIN MISTELE AND KATHERINE RAFANELLI


oject # **24045**vision date

05/12/2025

nase CHEMATIC DESIGN



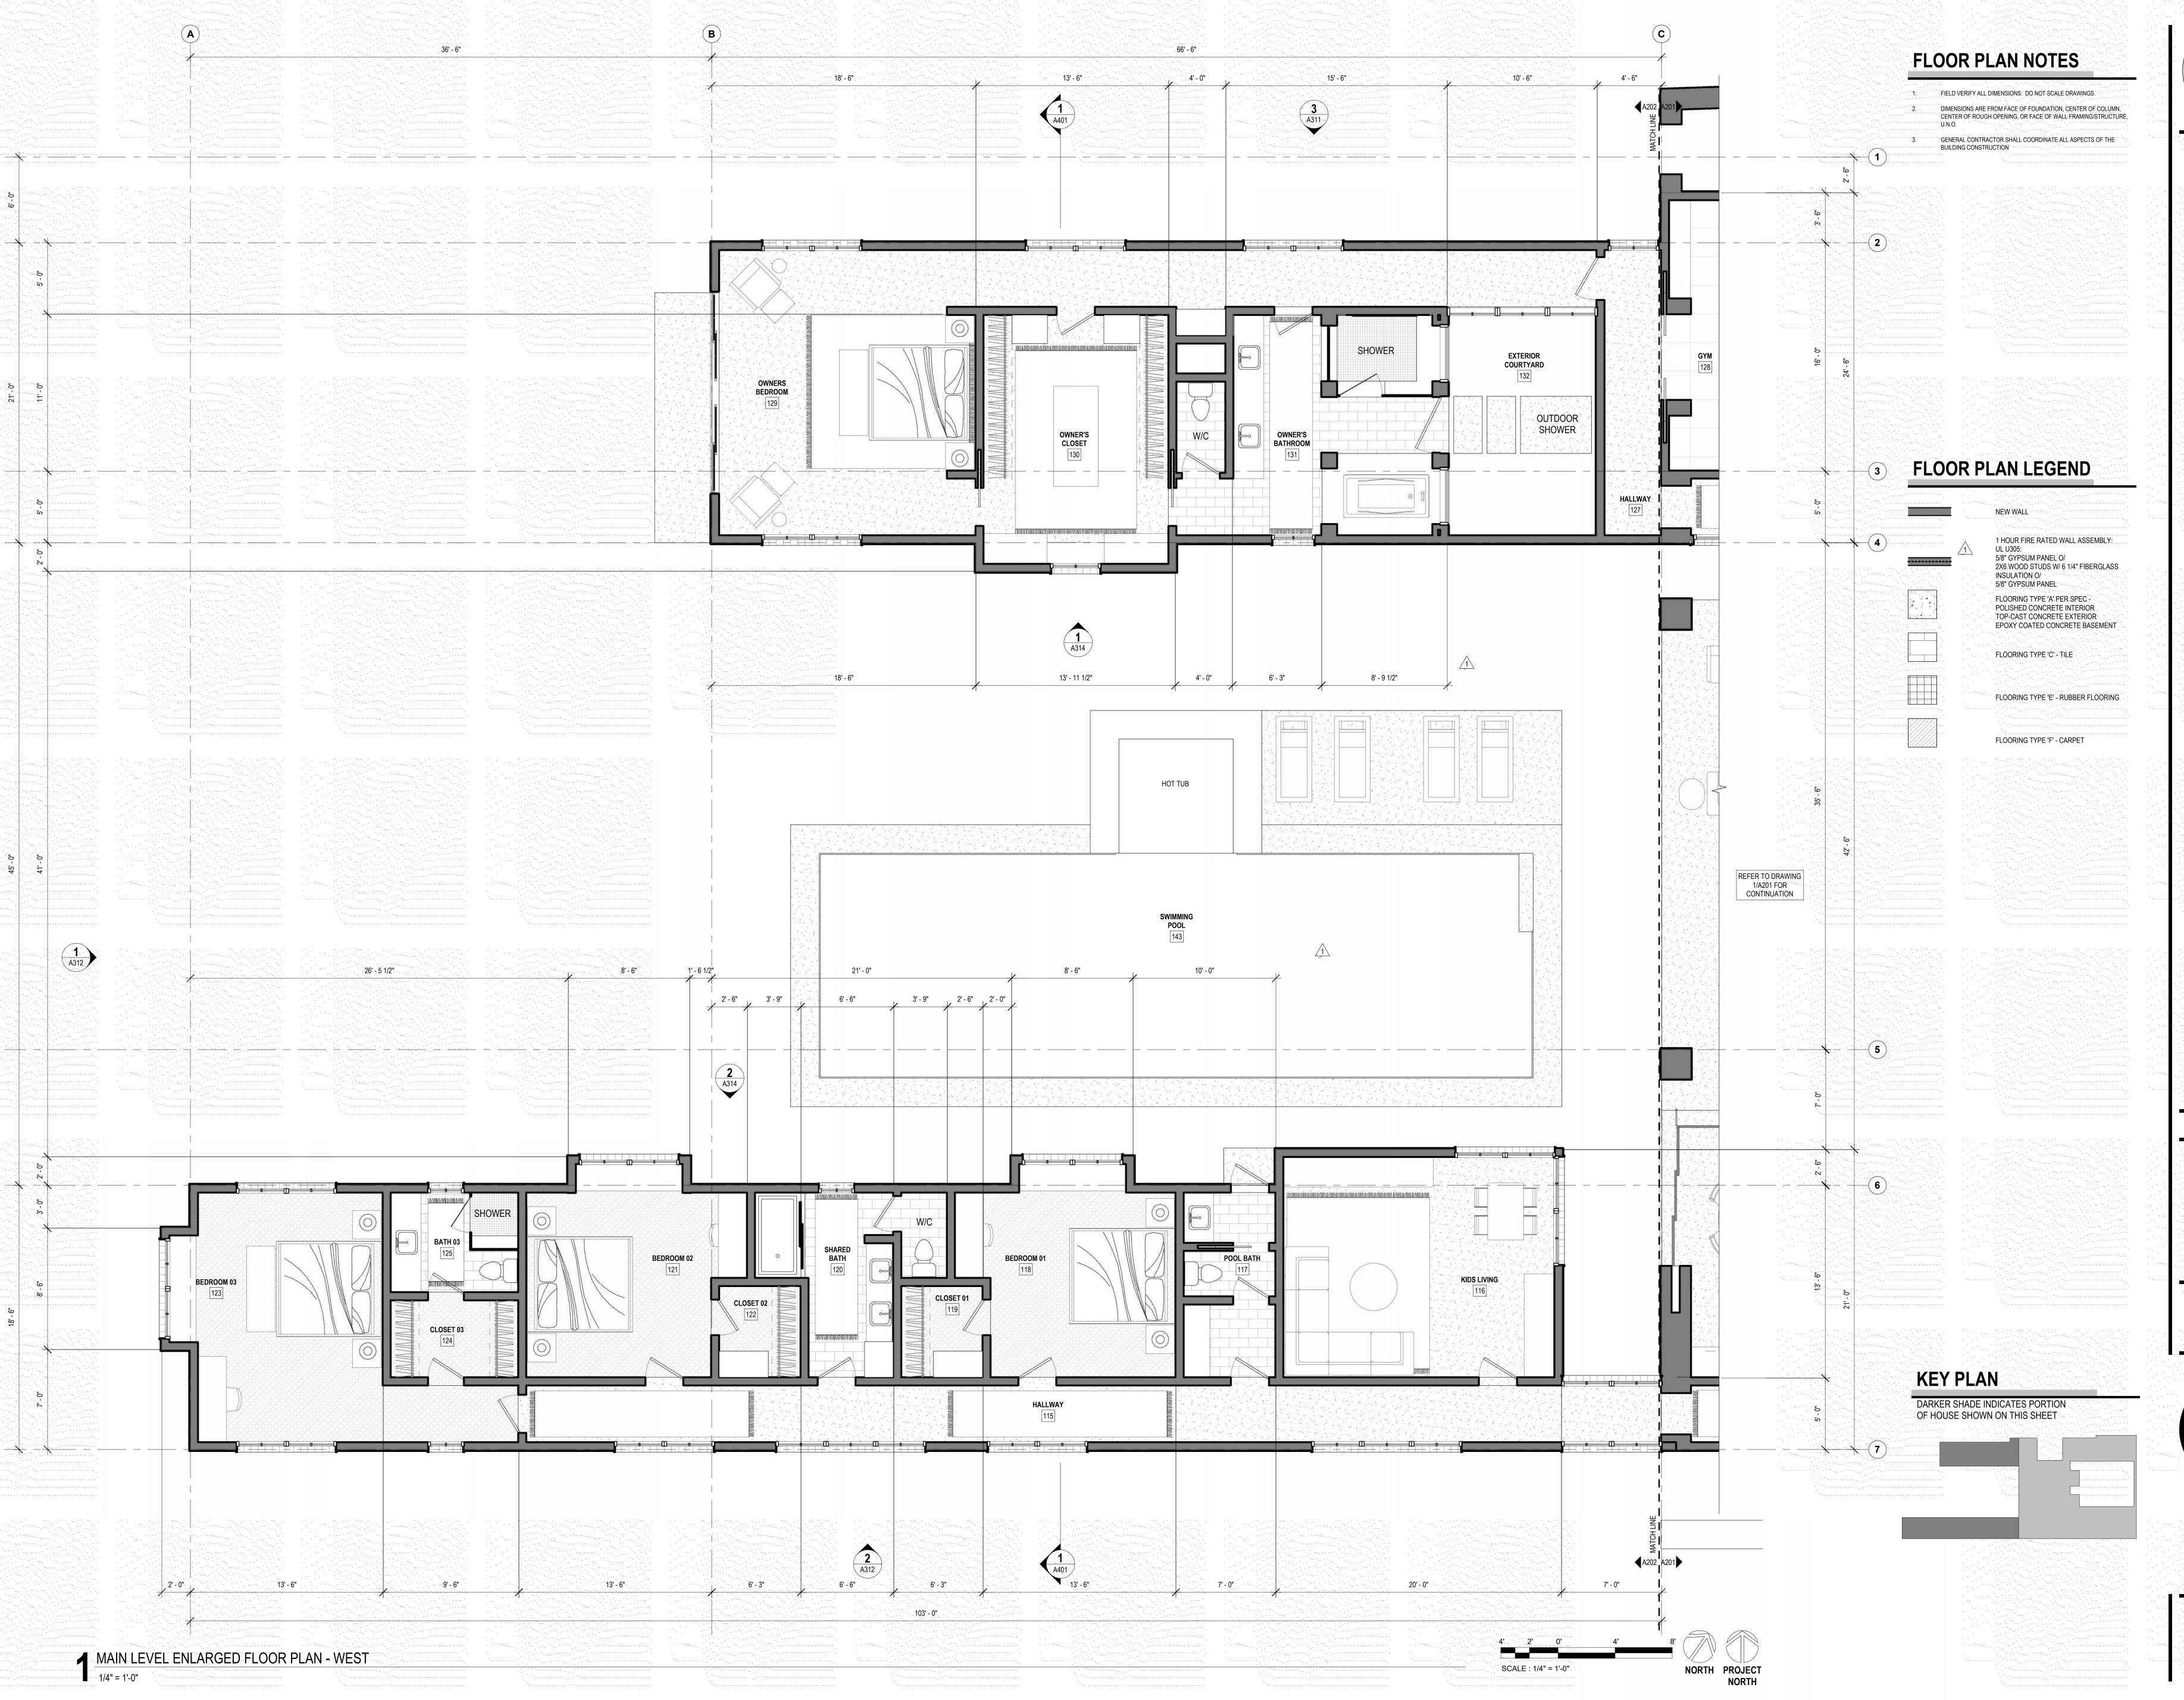

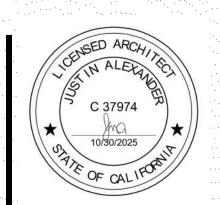

INLARGED FLOOR PLANS

MISTELE-RAFANELLI RESIDENCE

21 PEPPER AVE. BURLINGAME, CA 94010 APN: 02827421

evision date 04/07/2025

hase CHEMATIC DESIGN PRICING SET - NOT



- FIELD VERIFY ALL DIMENSIONS. DO NOT SCALE DRAWINGS.
- 2. DIMENSIONS ARE FROM FACE OF FOUNDATION, CENTER OF COLUMN, CENTER OF ROUGH OPENING, OR FACE OF WALL FRAMING/STRUCTURE,
- GENERAL CONTRACTOR SHALL COORDINATE ALL ASPECTS OF THE BUILDING CONSTRUCTION



# NEW WALL 1 HOUR FIRE RATED WALL ASSEMBLY: UL U305: 5/8" GYPSUM PANEL O/ 2X6 WOOD STUDS W/ 6 1/4" FIBERGLASS INSULATION O/ 5/8" GYPSUM PANEL FLOORING TYPE 'A' PER SPEC POLISHED CONCRETE INTERIOR TOP-CAST CONCRETE EXTERIOR EPOXY COATED CONCRETE BASEMENT FLOORING TYPE 'C' - TILE FLOORING TYPE 'E' - RUBBER FLOORING

FLOOR PLAN LEGEND

FLOORING TYPE 'F' - CARPET

DENCE

SASEMENT PLAN

AISTELE-RAFANELL


21 PEPPER AVE. BURLINGAM

OUN MISTELE AND KATHERINE RAF

# **24045** 

phase
SCHEMATIC DESIGN
PRICING SET - NOT
FOR CONSTRUCTION



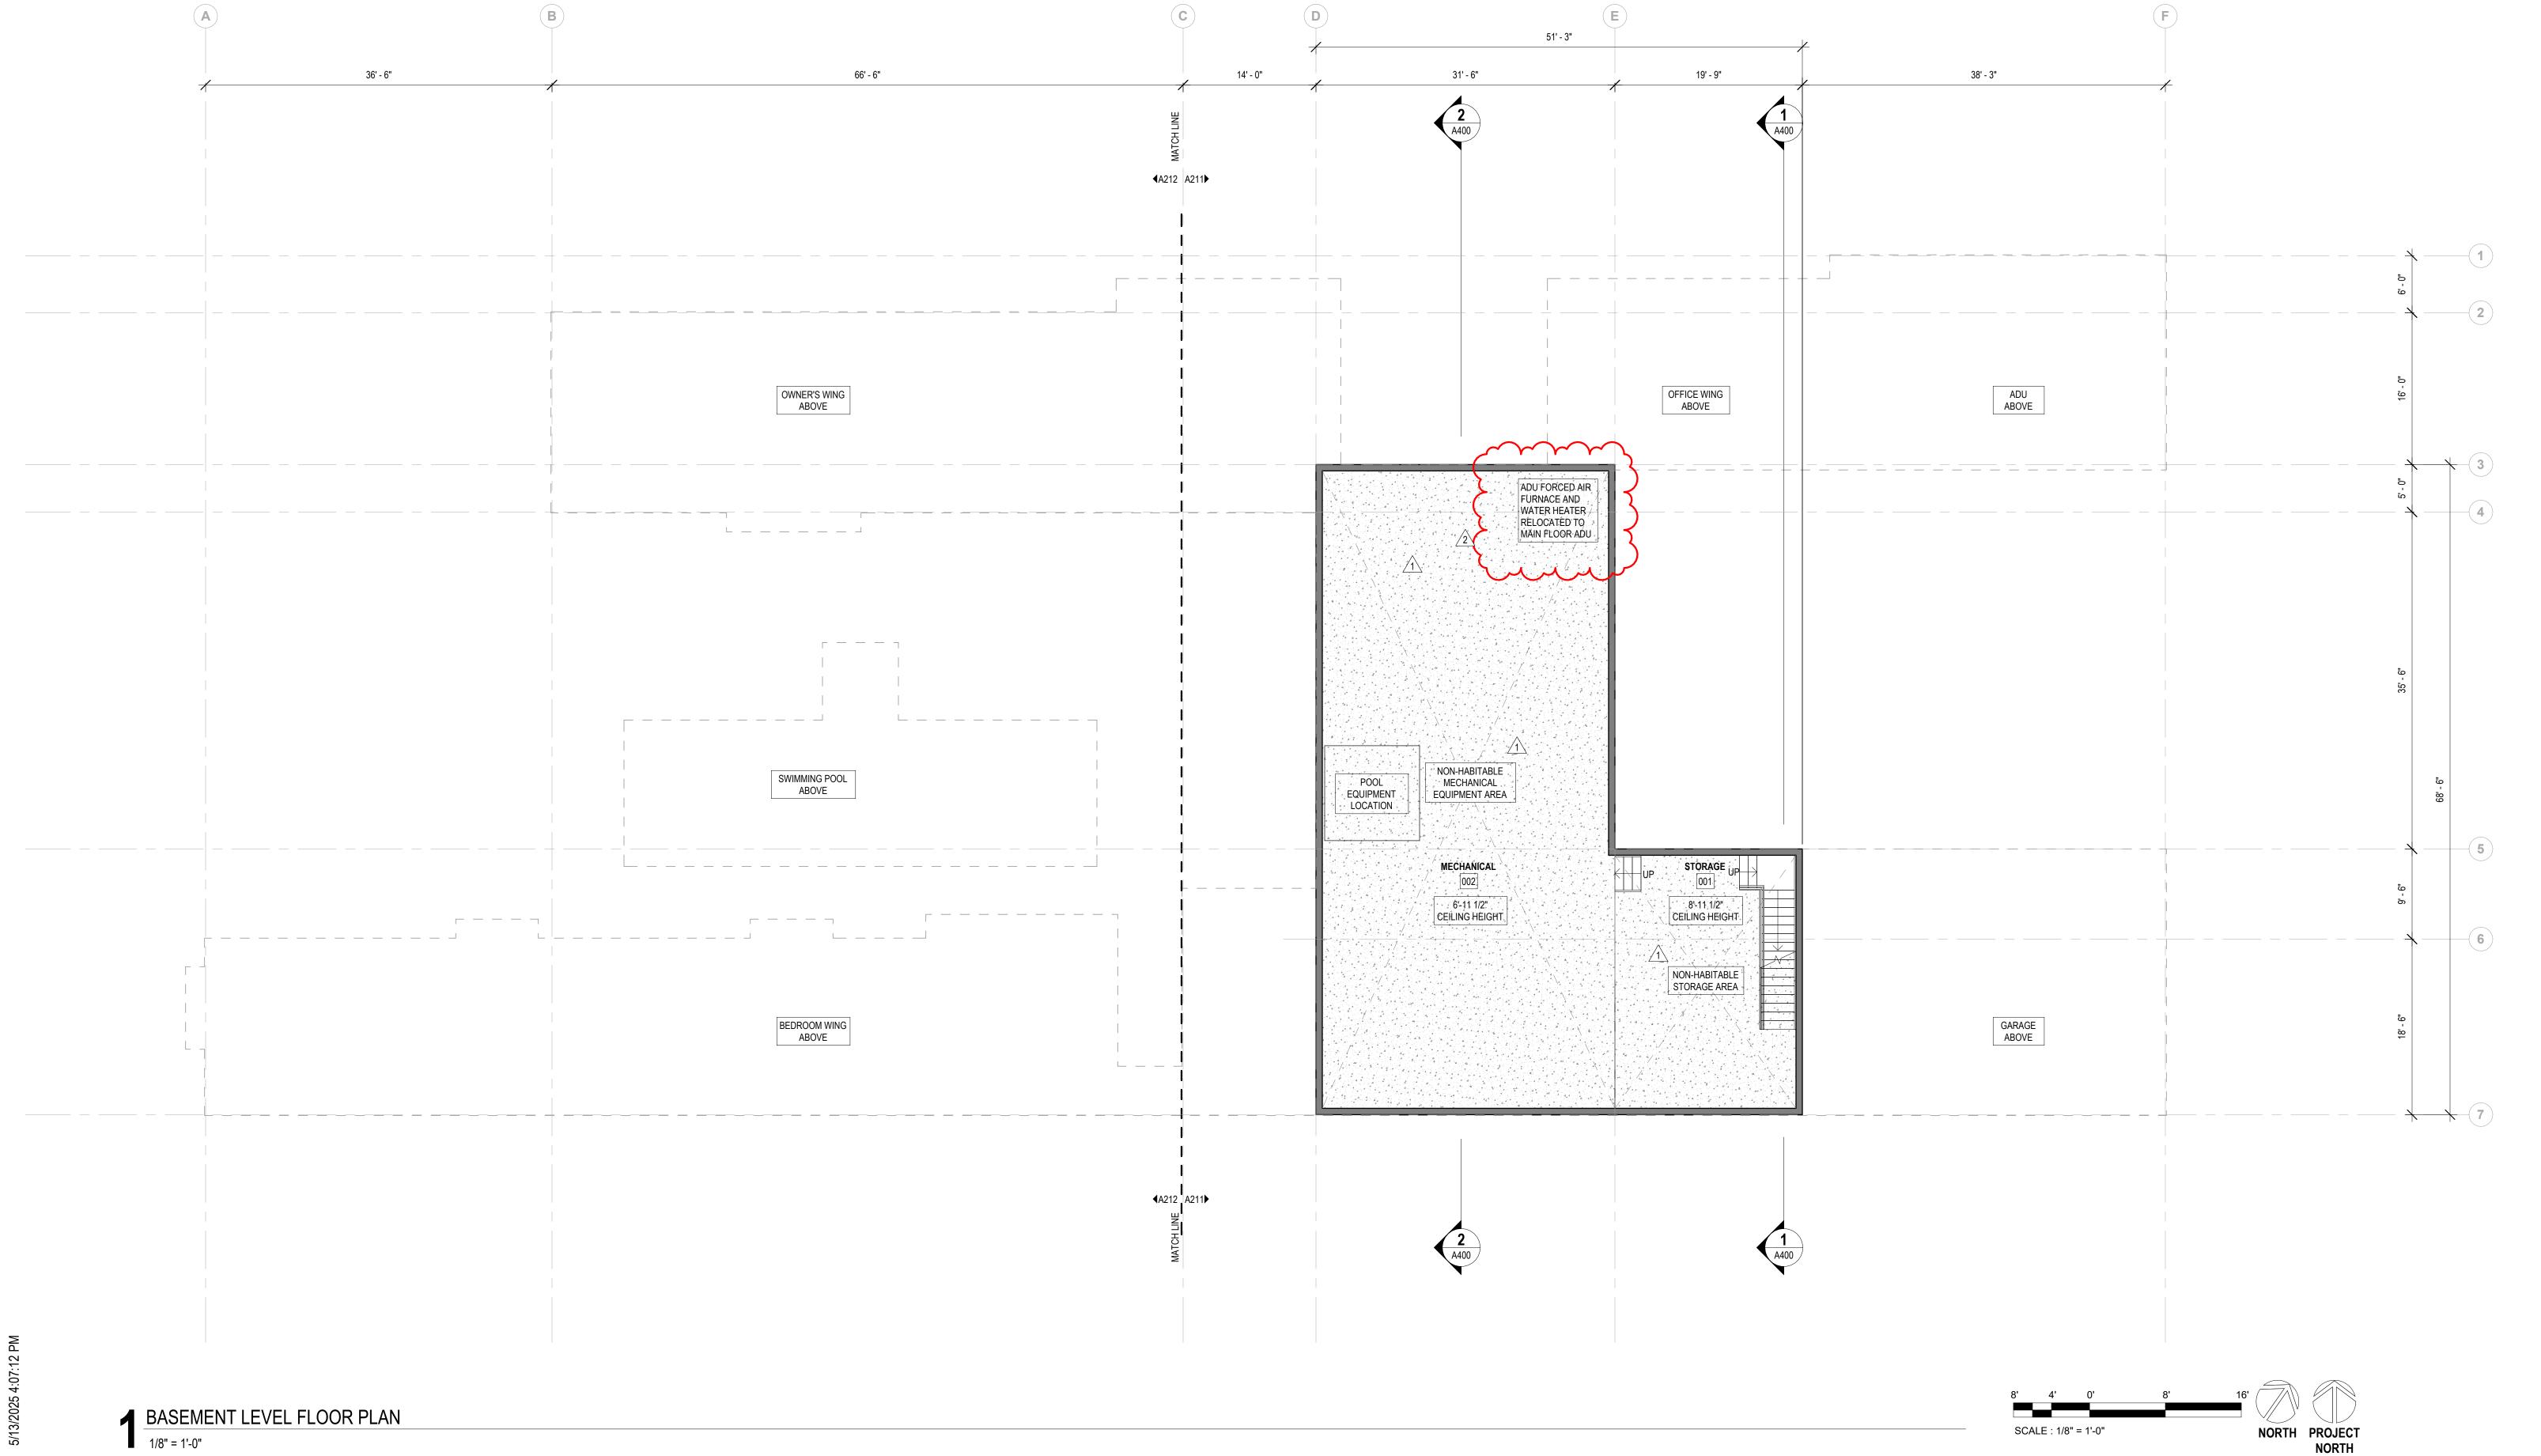

1. ALL ROOF THRU VENTS TO BE ON BACK SIDE OF BUILDING.

2. PROVIDE AND INSTALL ICE AND WATER SHIELD AT ENTIRE ROOF DECK, WALL TO ROOF CONDITIONS, ROOF CRICKETS, AND PENETRATIONS PER ROOFING AND UNDERLAYMENT MANUFACTURER'S

RECOMMENDATIONS, TYP.

3. ALL STEP/EXPOSED FLASHING TO BE PRE-FINISHED, COLOR BY ARCHITECT.
 4. INDICATE ADDITIONAL ITEMS PENETRATING THE ROOF ASSEMBLY;

PROVIDE APPROPRIATE FLASHING.

5. SLOPED GUTTERS TO BE PROVIDED AT ALL ROOF EAVES.

NO EAVE OR HIP/RIDGE VENTS TO BE PROVIDED. ROOF ASSEMBLY TO BE NON-VENTED AND INSULATED WITH CLOSED CELL SPRAY FOAM IN CONTACT WITH THE UNDERSIDE OF THE ROOF SHEATHING.


SLOPED ROOFS WILL BE STEEL STANDING SEAM, 0.016 INCH MIN. THICKNESS WITH FIRE RATED UNDERLAYMENT OF GAF VERSASHIELD OR EQUAL, ACHIEVING A CLASS A FIRE RATED ROOF ASSEMBLY.

FLAT ROOFS WILL BE EPDM WITH TWO LAYERS OF GAF VERSACHIELD OR EQUAL, ACHIEVING A CLASS A FIRE RATED ROOF ASSEMBLY.

AREA OF FLAT ROOF AREA OF FLAT ROOF STANDING SEAM
METAL ROOF
SLOPE 5:12 STANDING SEAM METAL ROOF SLOPE 5:12 COURTYARD **2**A313 STANDING SEAM
METAL ROOF
SLOPE 5:12 STANDING SEAM
METAL ROOF
SLOPE 1 1/2:12 A313 STANDING SEAM
METAL ROOF
SLOPE 5:12 AREA OF FLAT ROOF AREA OF FLAT ROOF

ROOF PLAN

1/8" = 1'-0"

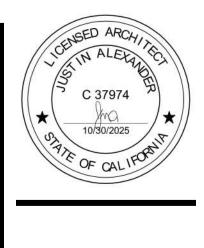

STELE-RAFANELLI RESIDENCE PEPPER AVE. BURLINGAME, CA 94010 APN: 028274; I MISTELE AND KATHERINE RAFANELLI

> # 24045 n date 05/12/2025

phase
SCHEMATIC DESIGN
PRICING SET - NOT
FOR CONSTRUCTION



LOGGIA LOOKING TO POOL ENTRY COURTYARD

POOL COURTYARD LOOKING NORTHEAST



B CAR COURT LOOKING SOUTHWEST




CAR COURT LOOKING NORTHWEST







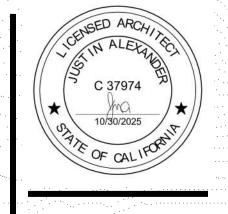


AFANELLI RESIDENCE BURLINGAME, CA 94010 APN:


issue date 02/11/2025


A300

REFER TO ENLARGED ELEVATIONS, SHEETS A311 AND A312 FOR MATERIAL NOTES DIMENSIONS

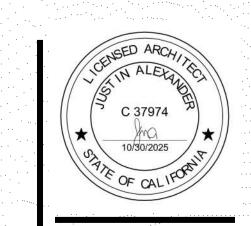



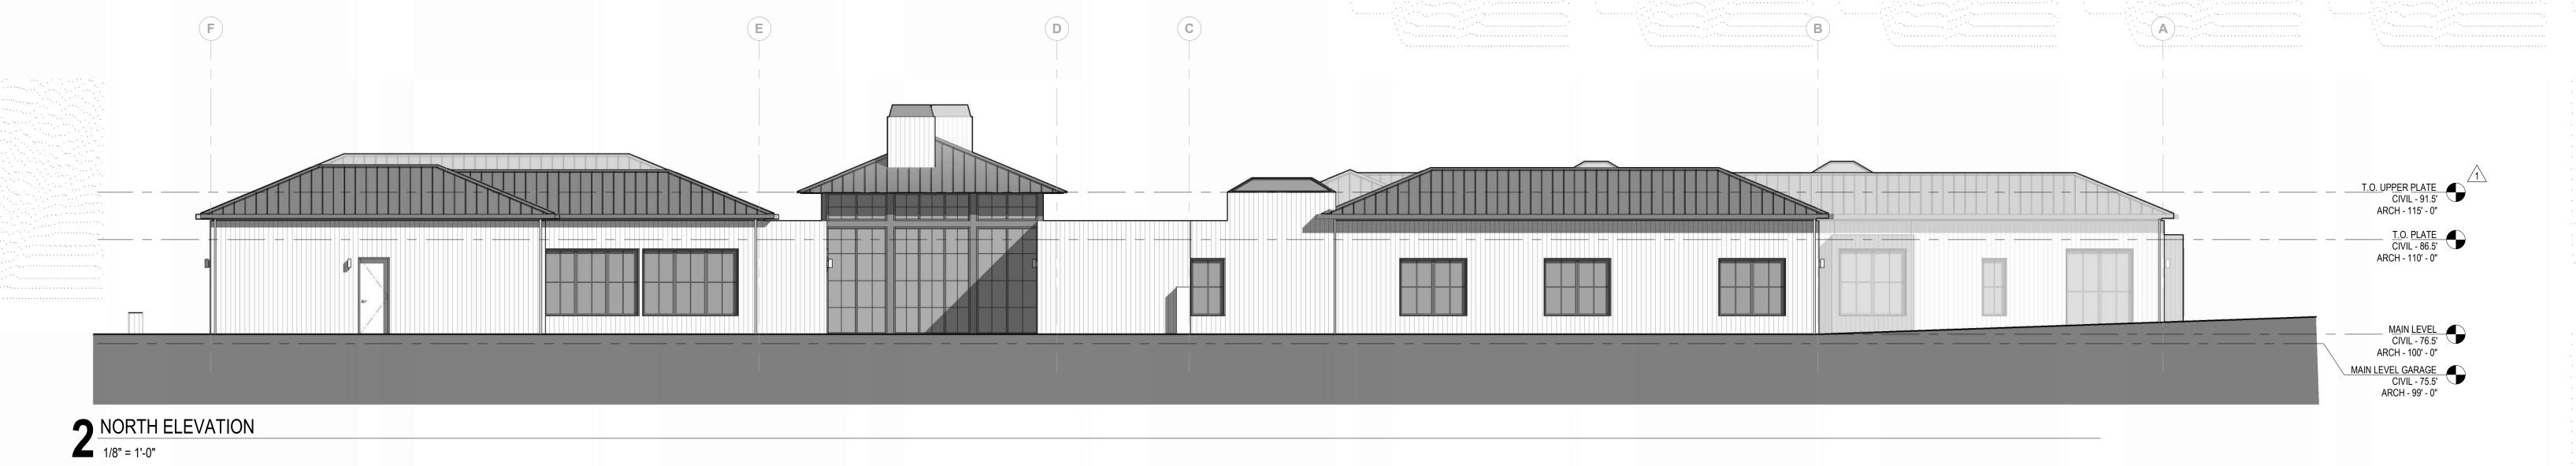


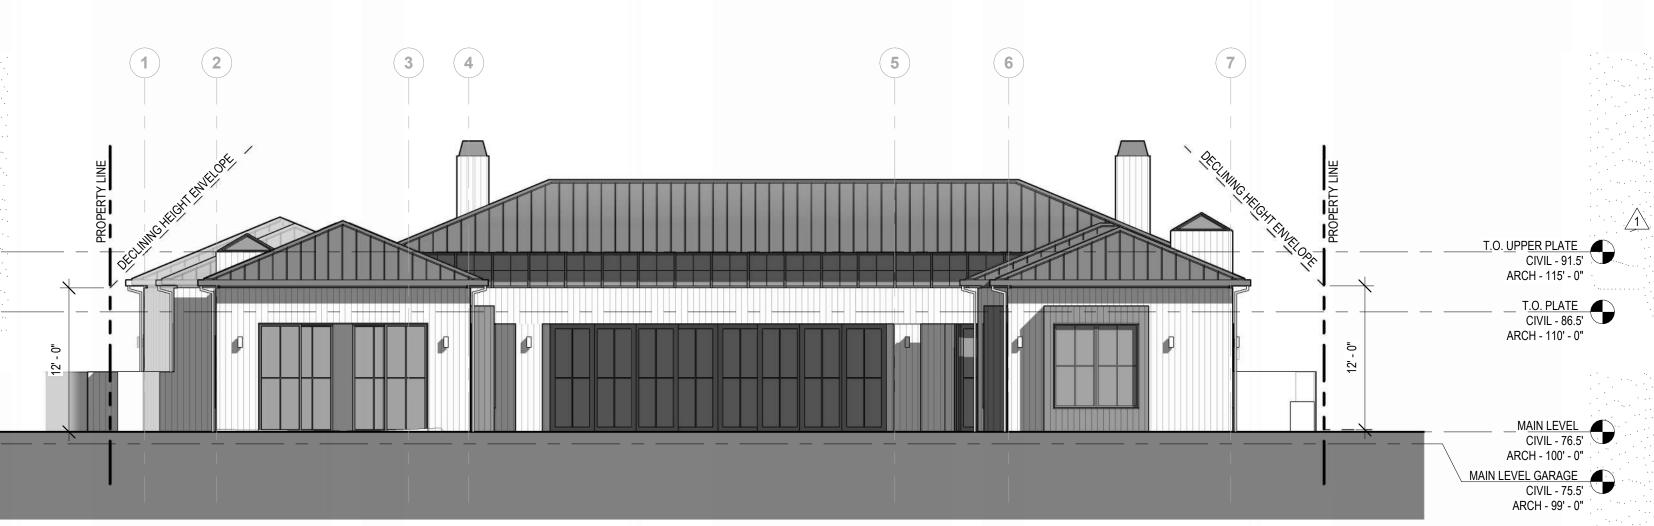





MISTELE-RAFANELLI RESIDENCE 121 PEPPER AVE. BURLINGAME, CA 94010 APN:

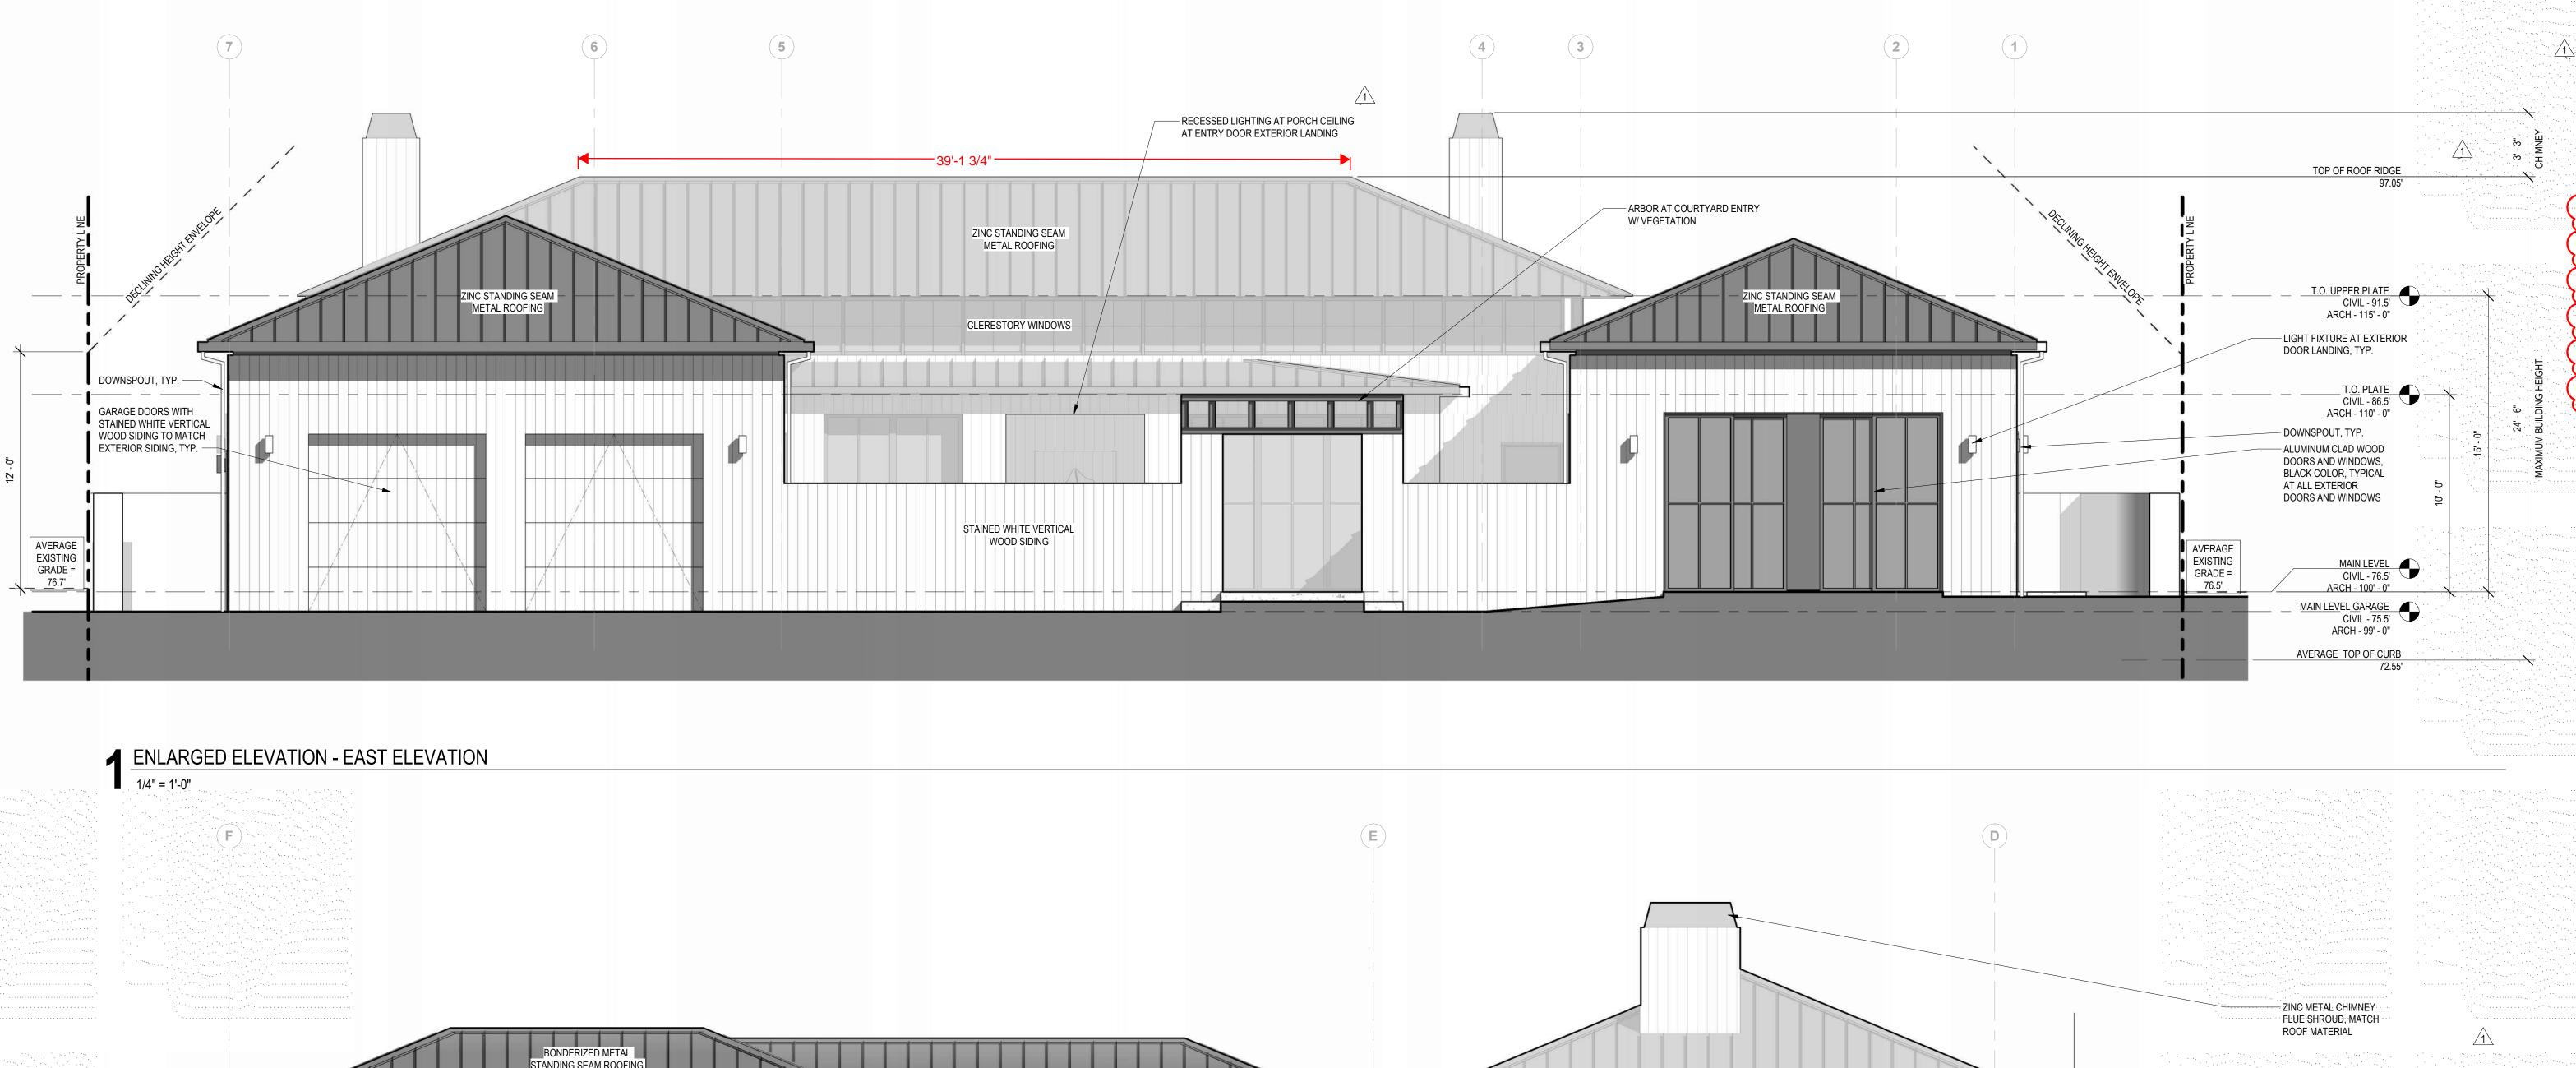

**ELEVATION NOTES** 

1. WINDOWS AND EXTERIOR SLIDING DOORS ARE ALUMINUM CLAD WOOD, BLACK COLOR.

2. ALL GRIDS AND MUNTINS SHOWN ON WINDOWS AND EXTERIOR SLIDING DOORS ARE SIMULATED TRUE DEVIDED LITES, BLACK COLOR WITH BLACK SPACER BARS.

SLIDING DOORS ARE SIMULATED TRUE DEVIDED LITES, BLACK
COLOR WITH BLACK SPACER BARS.

3. ALL WINDOWS AND GLASS DOORS SHALL HAVE MINIMUM 1 PANE
OF TEMPERED GLASS


NO EAVE OR HIP/RIDGE VENTS TO BE PROVIDED. ROOF ASSEMBLY TO BE NON-VENTED AND INSULATED WITH CLOSED CELL SPRAY FOAM IN CONTACT WITH THE UNDERSIDE OF THE ROOF SHEATHING.

SLOPED ROOFS WILL BE STEEL STANDING SEAM, 0.016 INCH MIN.
THICKNESS WITH FIRE RATED UNDERLAYMENT OF GAF
VERSASHIELD OR EQUAL, ACHIEVING A CLASS A FIRE RATED ROOF
ASSEMBLY.

FLAT ROOFS WILL BE EPDM WITH TWO LAYERS OF GAF VERSACHIELD OR EQUAL, ACHIEVING A CLASS A FIRE RATED ROOF ASSEMBLY.





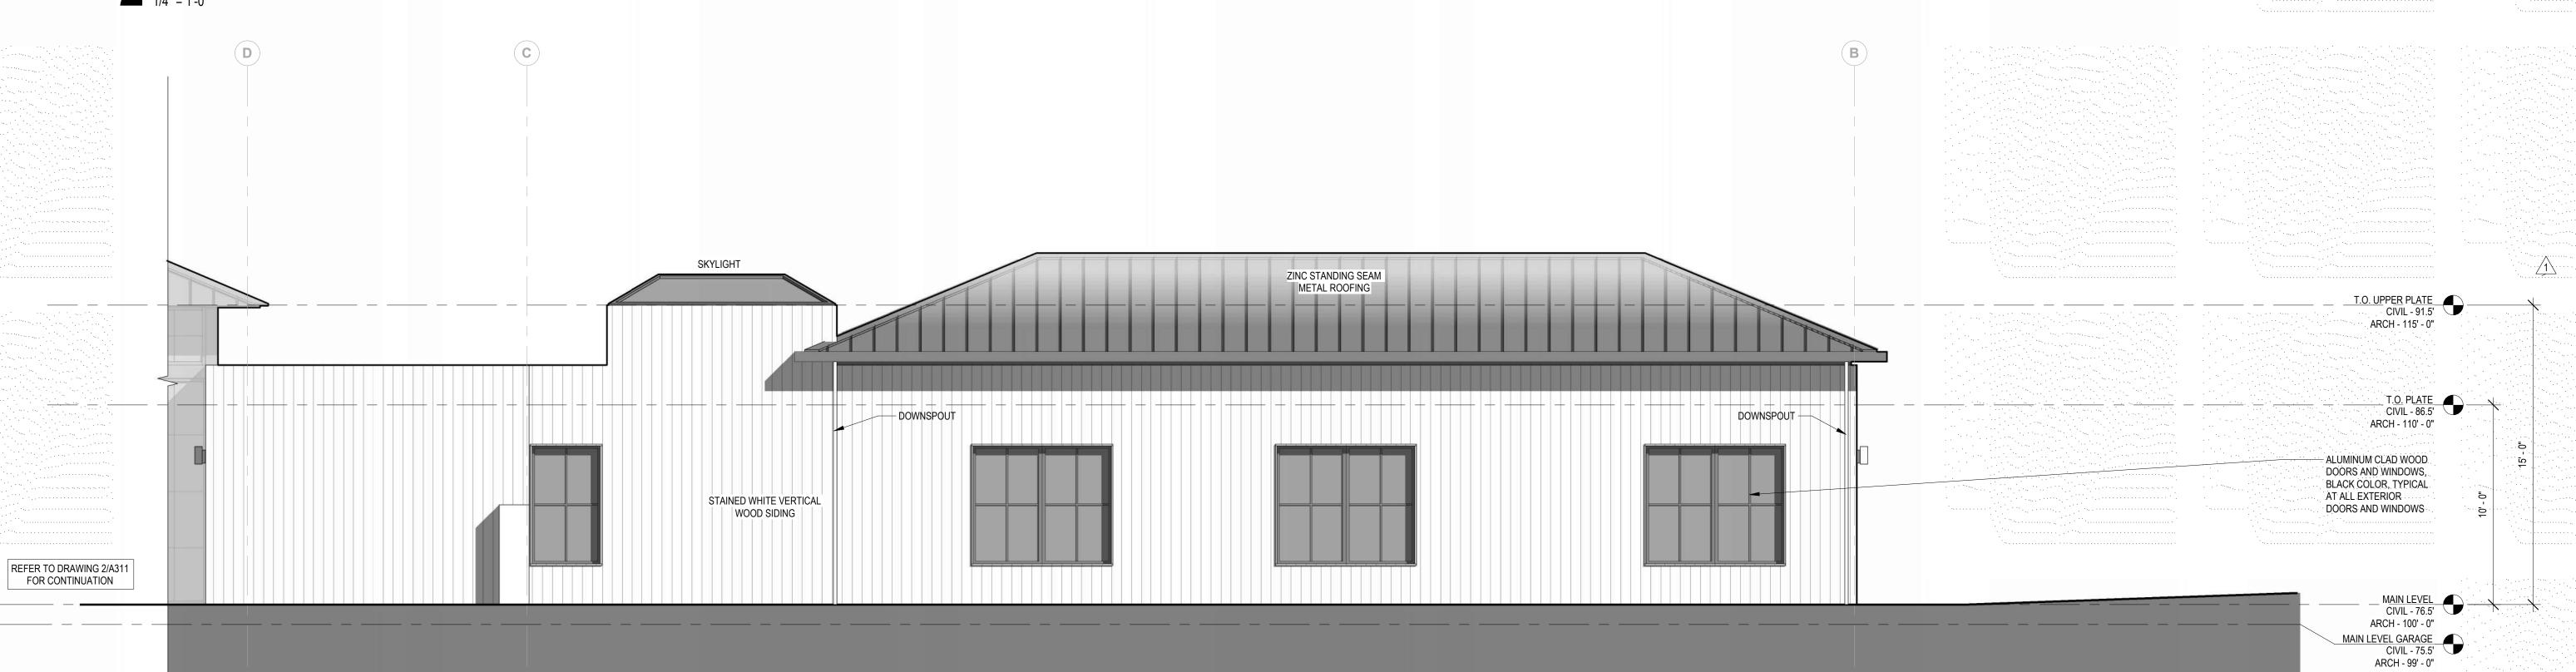

3 ENLARGED ELEVATION - OWNERS WING NORTH

1/4" = 1'-0"

issue date 02/11/2025 **A311** 


MISTELE-RAFANELLI RESIDENCE 121 PEPPER AVE. BURLINGAME, CA 94010 APN:


oject # 24045

05/12/2025

phase

FOR CONSTRUCTION

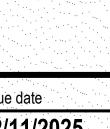

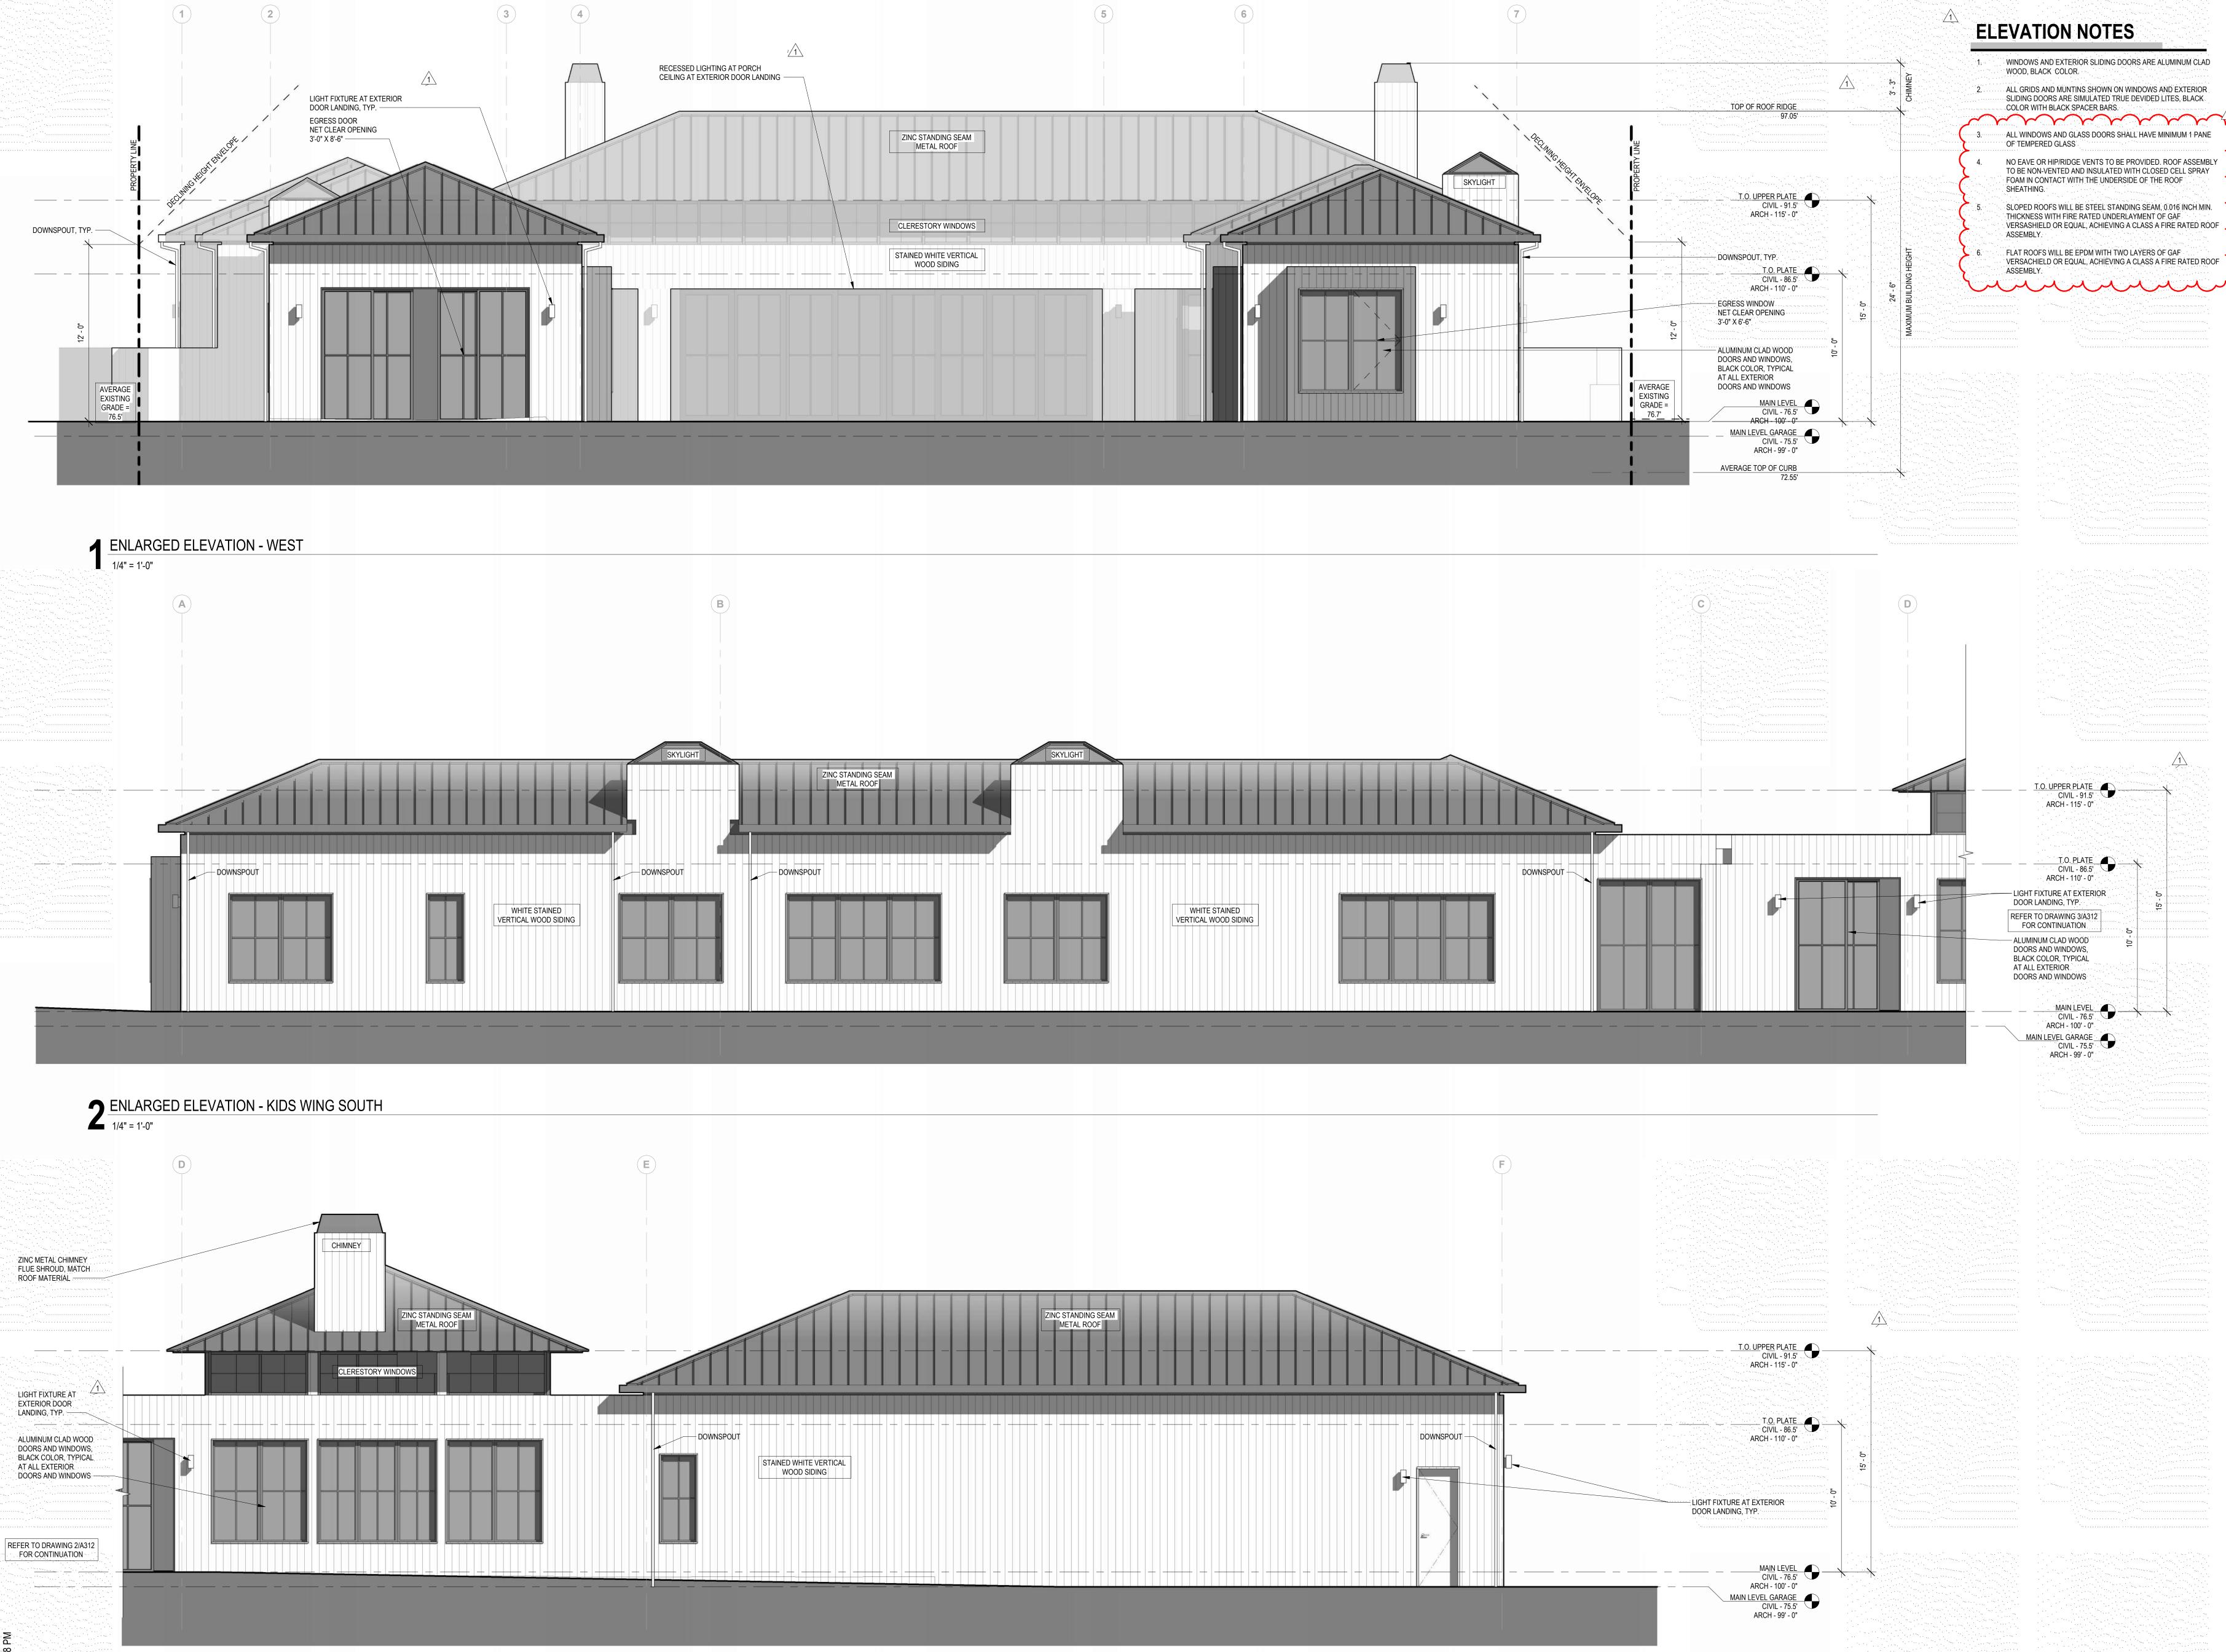

3 ENLARGED ELEVATION - GARAGE SOUTH

1/4" = 1'-0"

MISTELE-RAFANELLI RESIDENCE 121 PEPPER AVE. BURLINGAME, CA 94010 APN:


05/12/2025

SCHEMATIC DESIGN PRICING SET - NOT



issue date 02/11/2025

A312

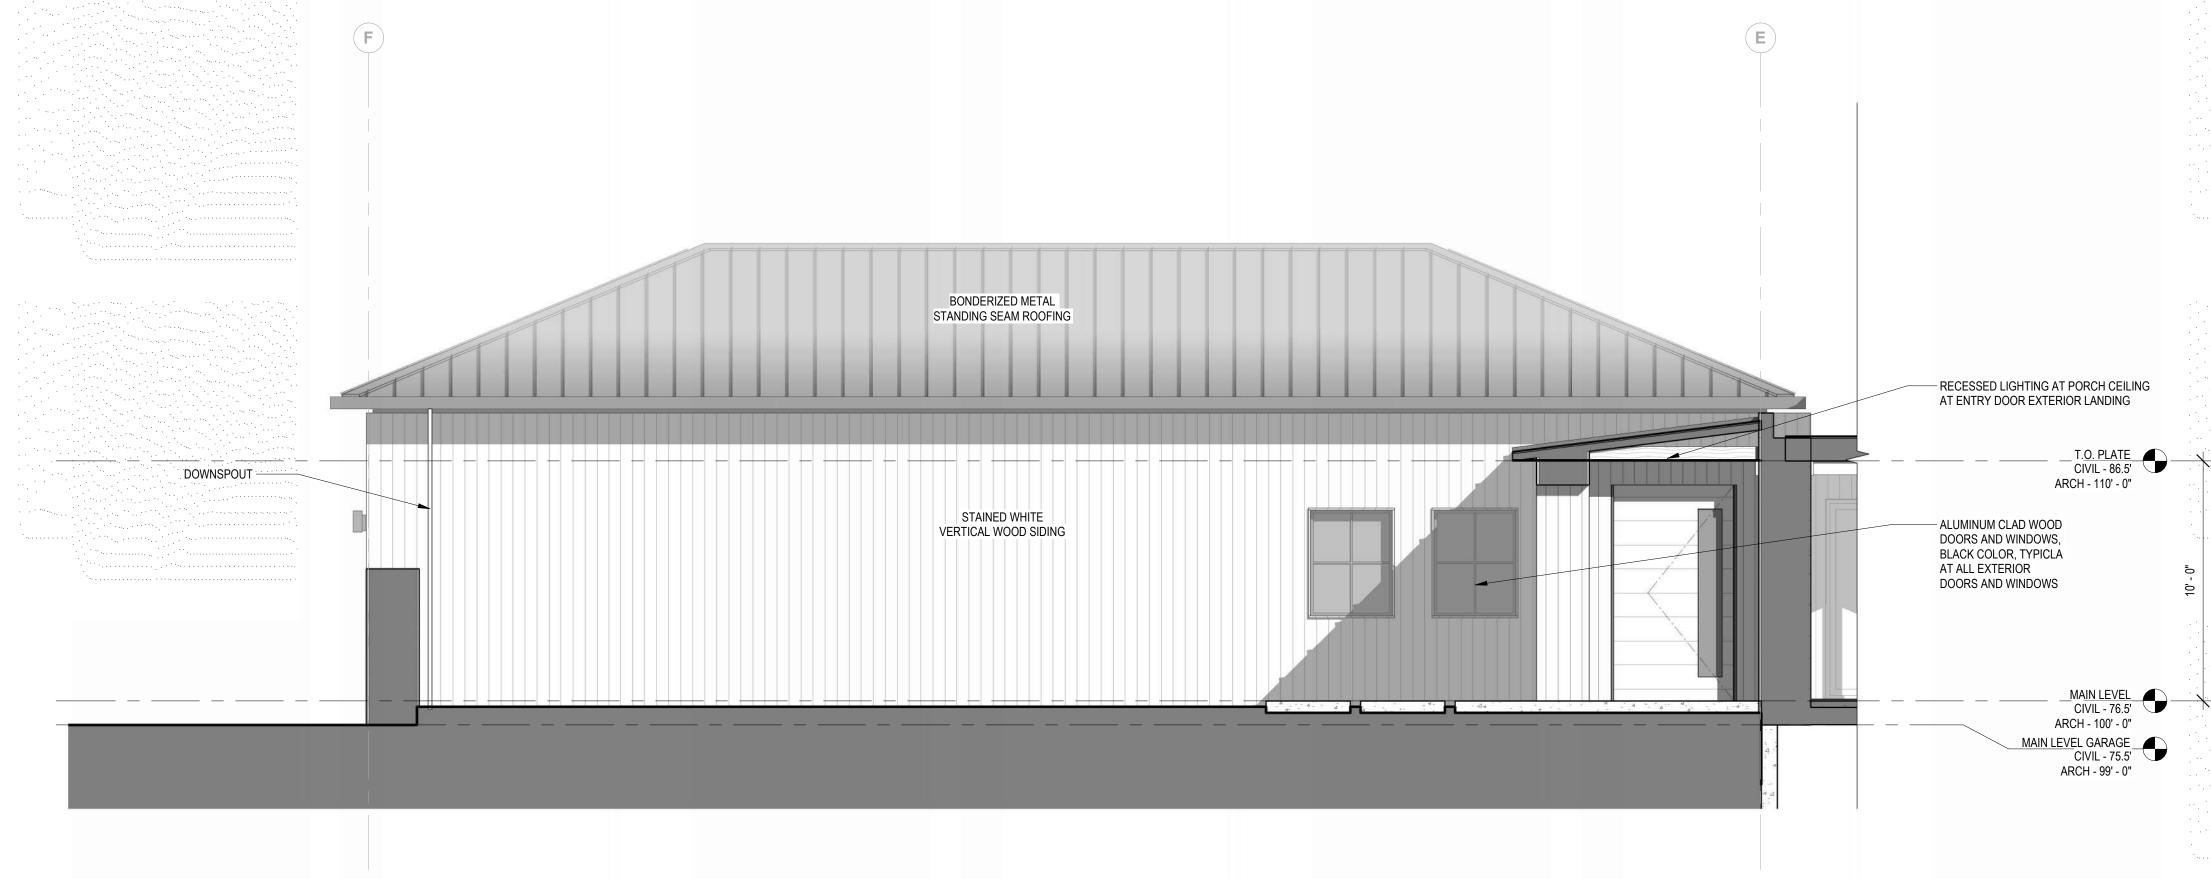

ENLARGED ELEVATION - GARAGE WING NORTH

1/4" = 1'-0"

DOMAND MATERIAL STATE OF THE PARTY OF THE PA

2 ENLARGED ELEVATION - ADU WING SOUTH

1/4" = 1'-0"

**ELEVATION NOTES** 

WINDOWS AND EXTERIOR SLIDING DOORS ARE ALUMINUM CLAD WOOD, BLACK COLOR.

2. ALL GRIDS AND MUNTINS SHOWN ON WINDOWS AND EXTERIOR SLIDING DOORS ARE SIMULATED TRUE DEVIDED LITES, BLACK COLOR WITH BLACK SPACER BARS.

3. ALL WINDOWS AND GLASS DOORS SHALL HAVE MINIMUM 1 PANE

OF TEMPERED GLASS

NO EAVE OR HIP/RIDGE VENTS TO BE PROVIDED. ROOF ASSEMBLY
TO BE NON-VENTED AND INSULATED WITH CLOSED CELL SPRAY
FOAM IN CONTACT WITH THE UNDERSIDE OF THE ROOF

SHEATHING.

SLOPED ROOFS WILL BE STEEL STANDING SEAM, 0.016 INCH MIN.
THICKNESS WITH FIRE RATED UNDERLAYMENT OF GAF
VERSASHIELD OR EQUAL, ACHIEVING A CLASS A FIRE RATED ROOF

ASSEMBLY.

FLAT ROOFS WILL BE EPDM WITH TWO LAYERS OF GAF


VERSACHIELD OR EQUAL, ACHIEVING A CLASS A FIRE RATED ROOF
ASSEMBLY.

EXTERIOR ELEVATIONS

MISTELE-RAFANELLI RESIDENCE


121 PEPPER AVE. BURLINGAME, CA 94010 APN: 028274210

COLIN MISTELE AND KATHERINE RAFANELLI

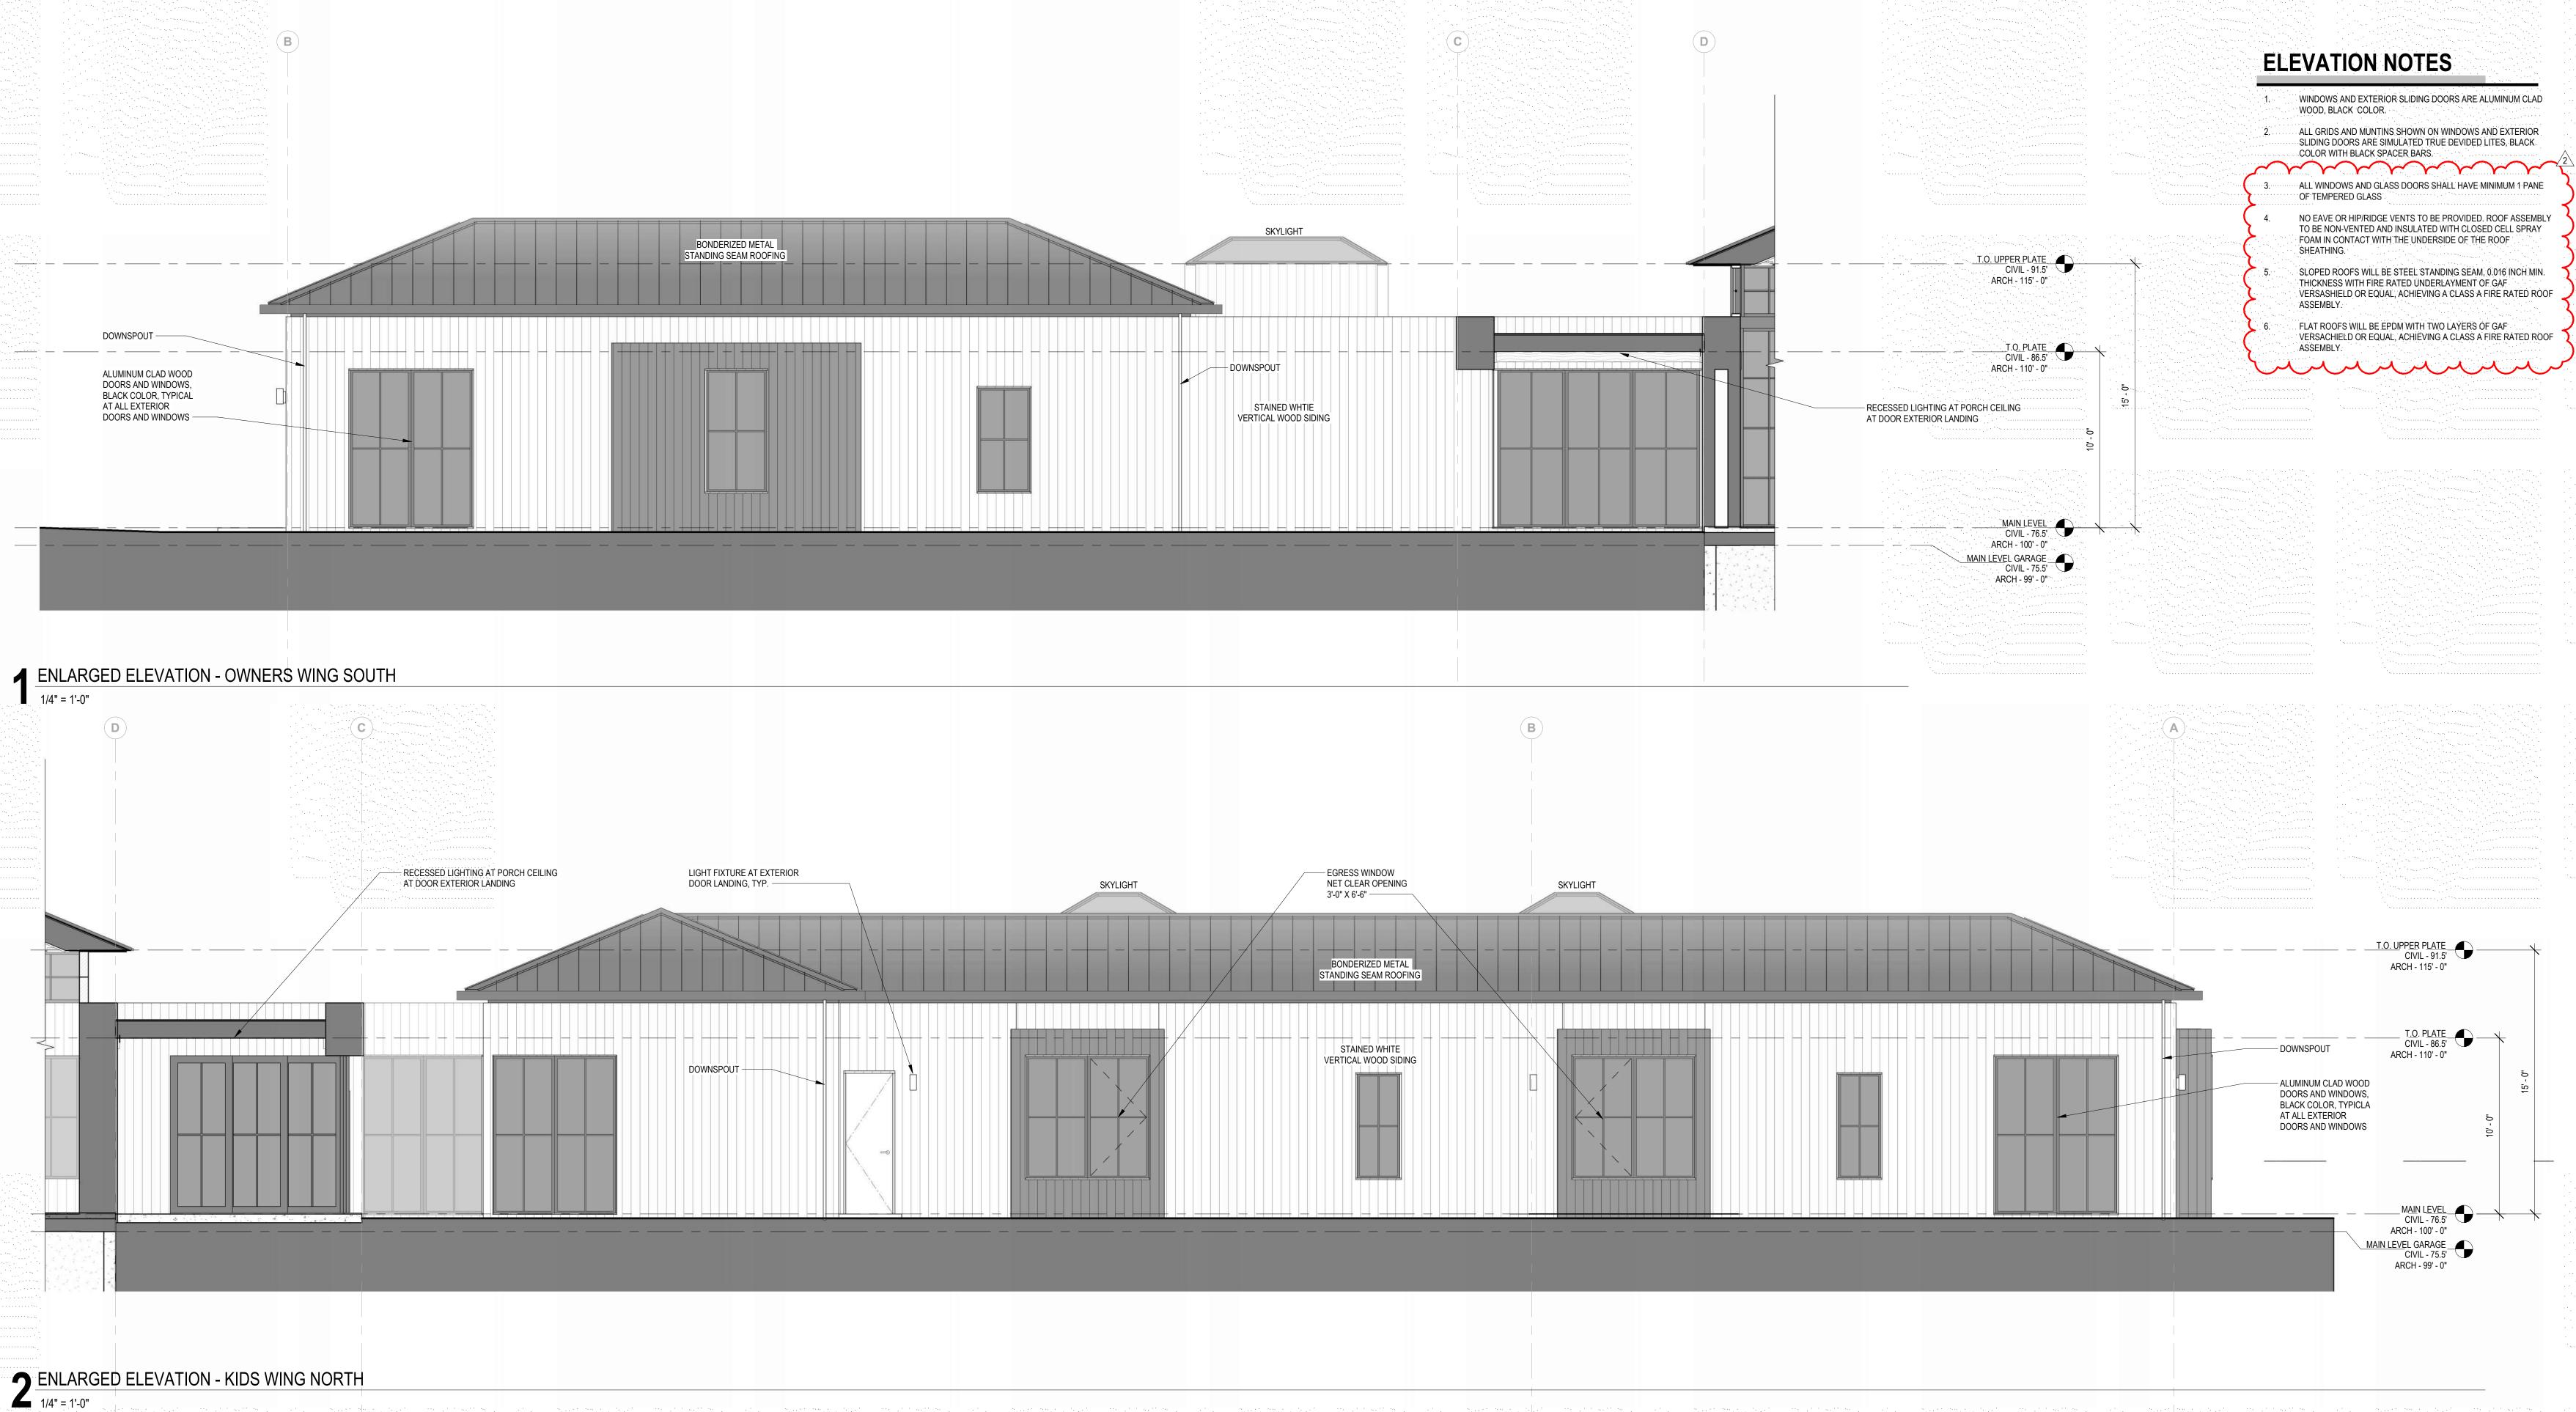

ELLI RESIDENCE JGAME, CA 94010 APN:




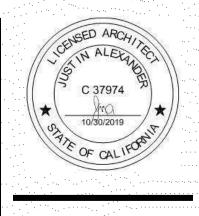



NORTH ELEVATION EXISTING

1/4" = 1'-0"

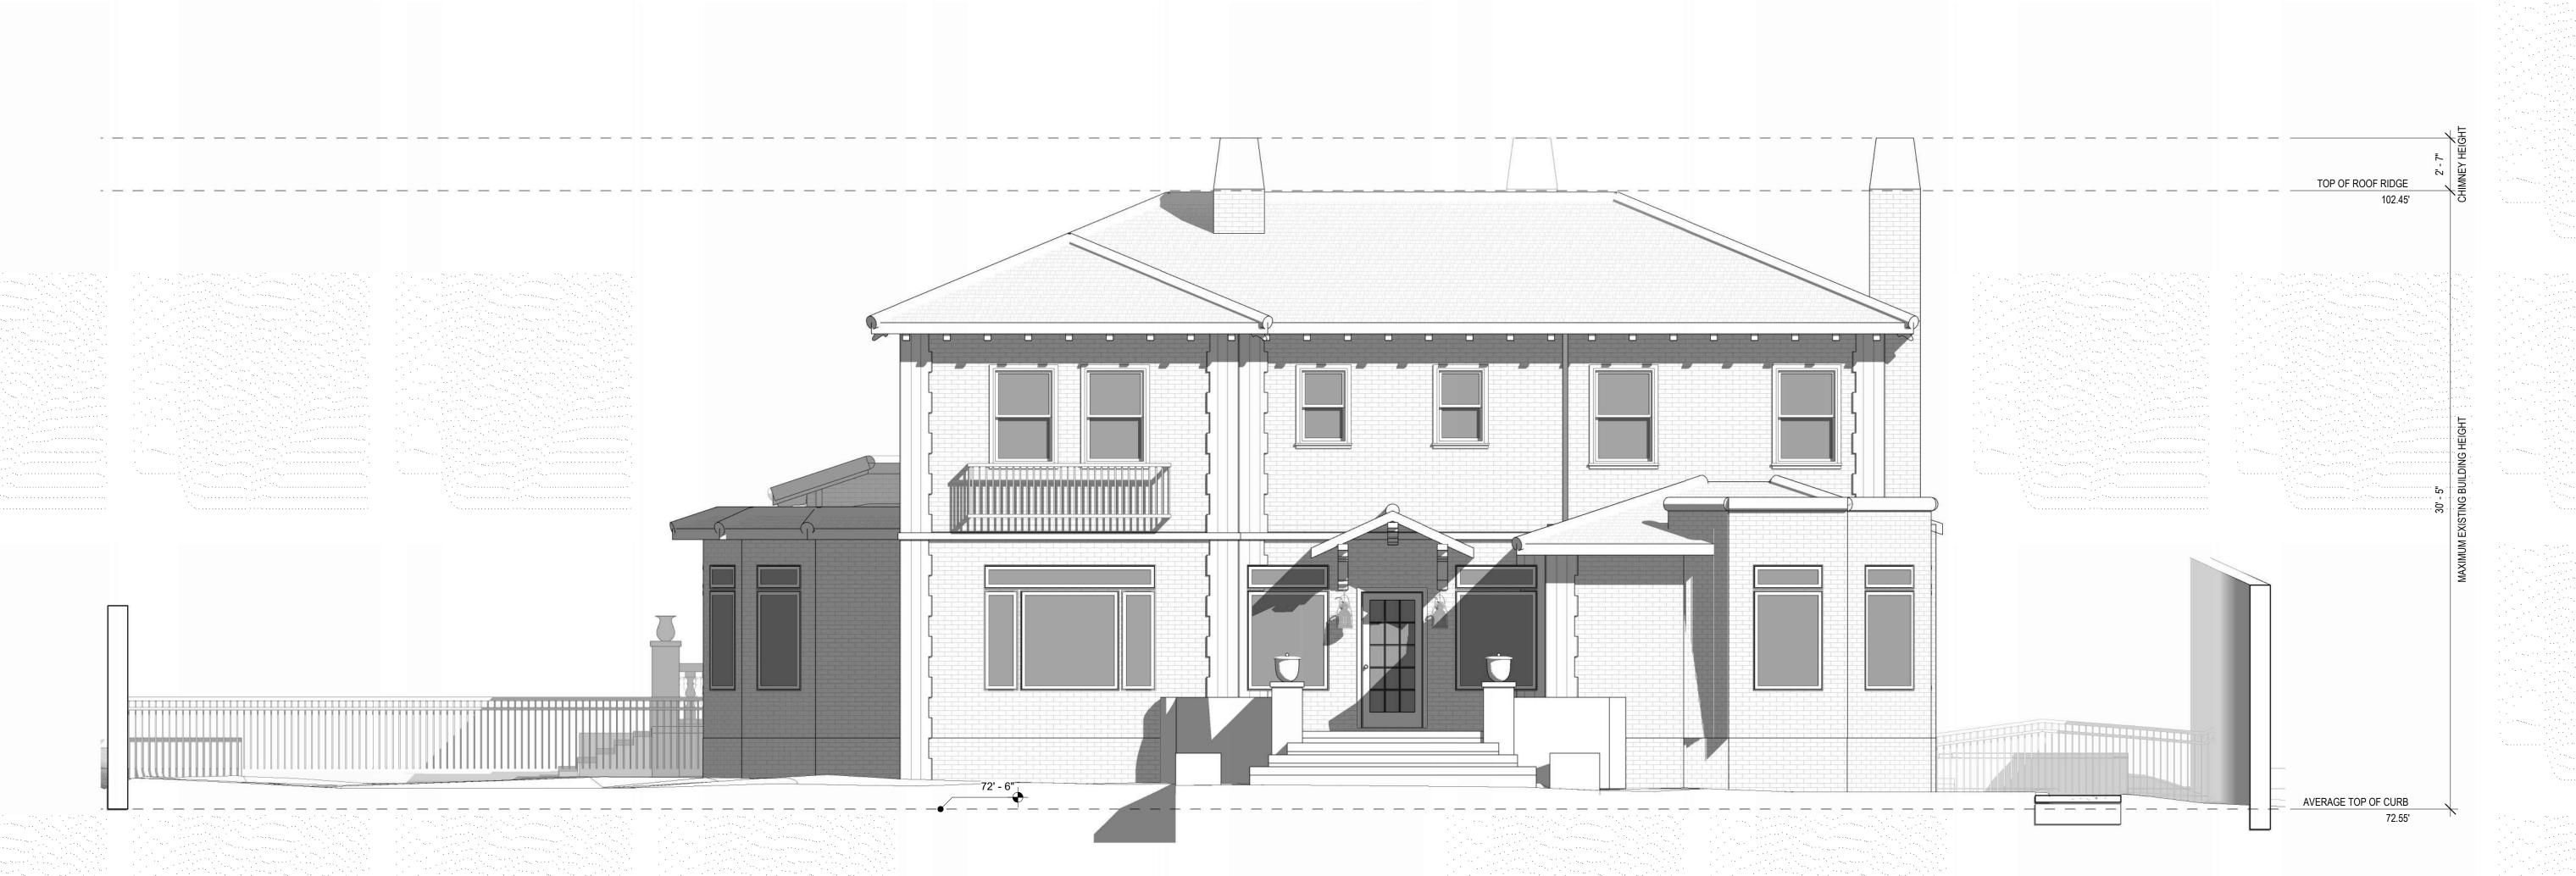

04/07/2025


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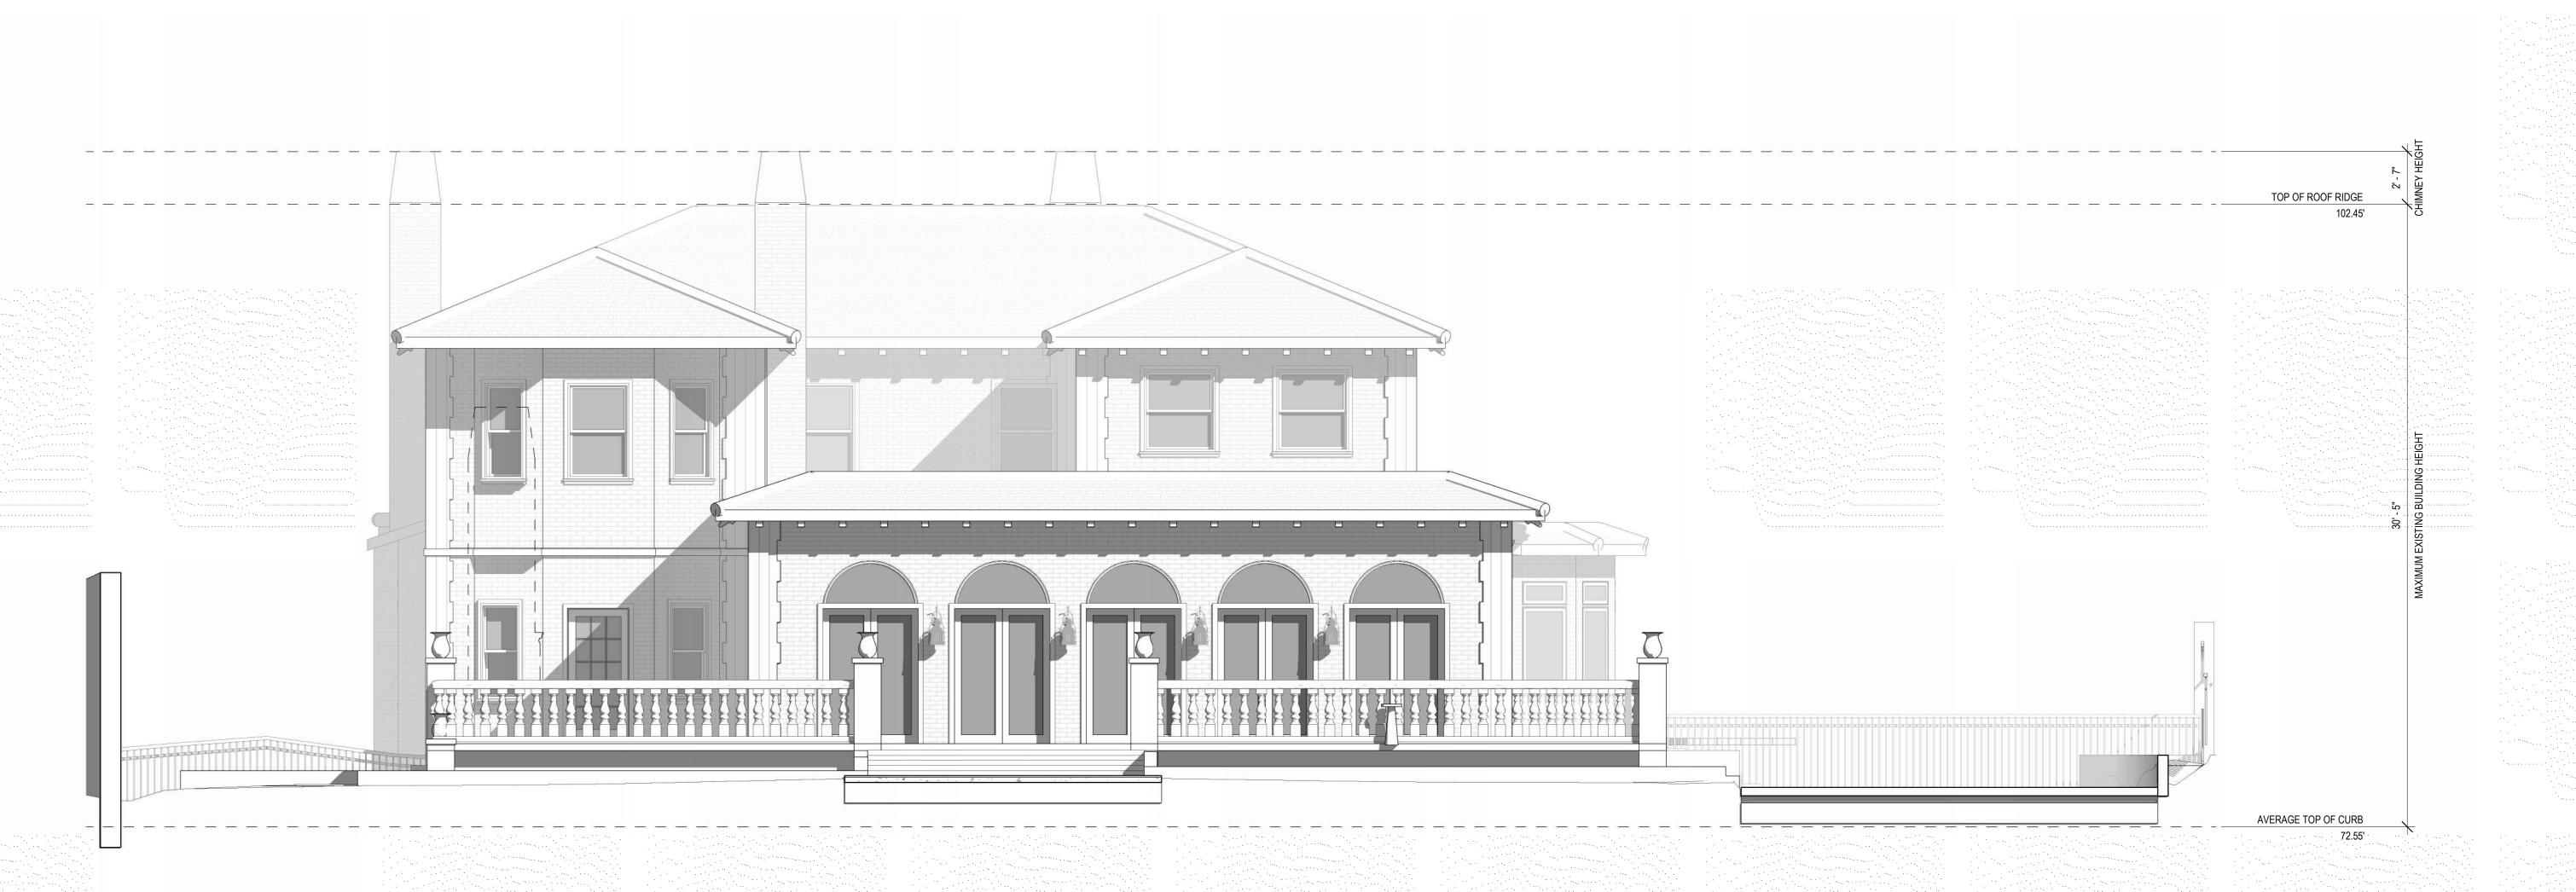
2 EAST ELEVATION EXISTING

1/4" = 1'-0"





SOUTH ELEVATION EXISTING

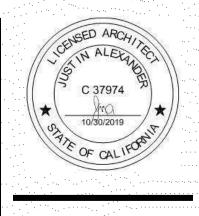

sheet EXISTING BUILDING EXTERIOR ELEVaried MISTELE-RAFANELLI RE


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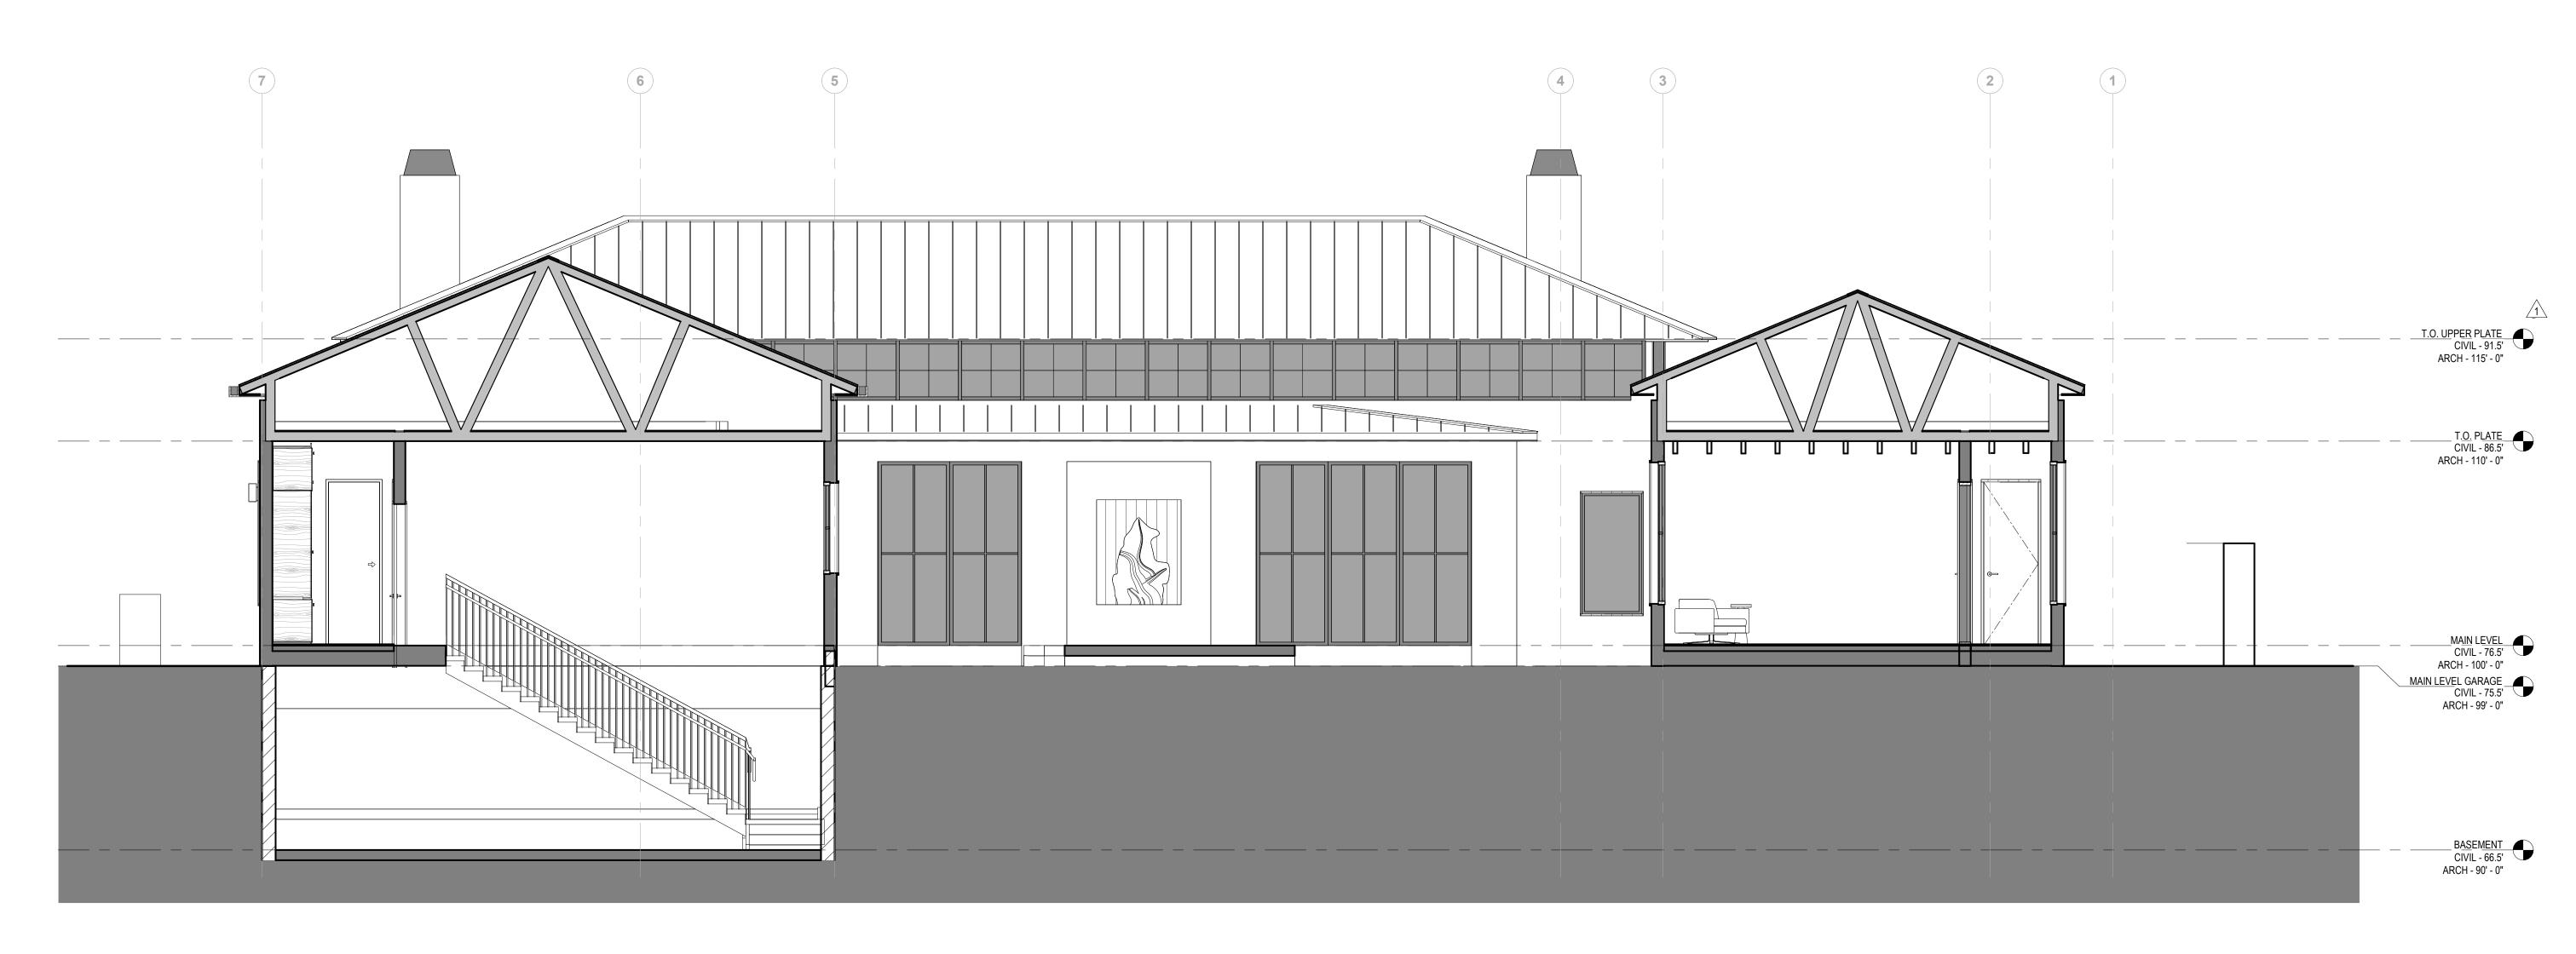


2 WEST ELEVATION EXISTING

1/4" = 1'-0"


02/11/2025 A321



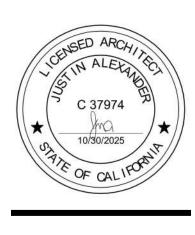

BUILDING SECTION NORTH-SOUTH 1

1/4" = 1'-0"

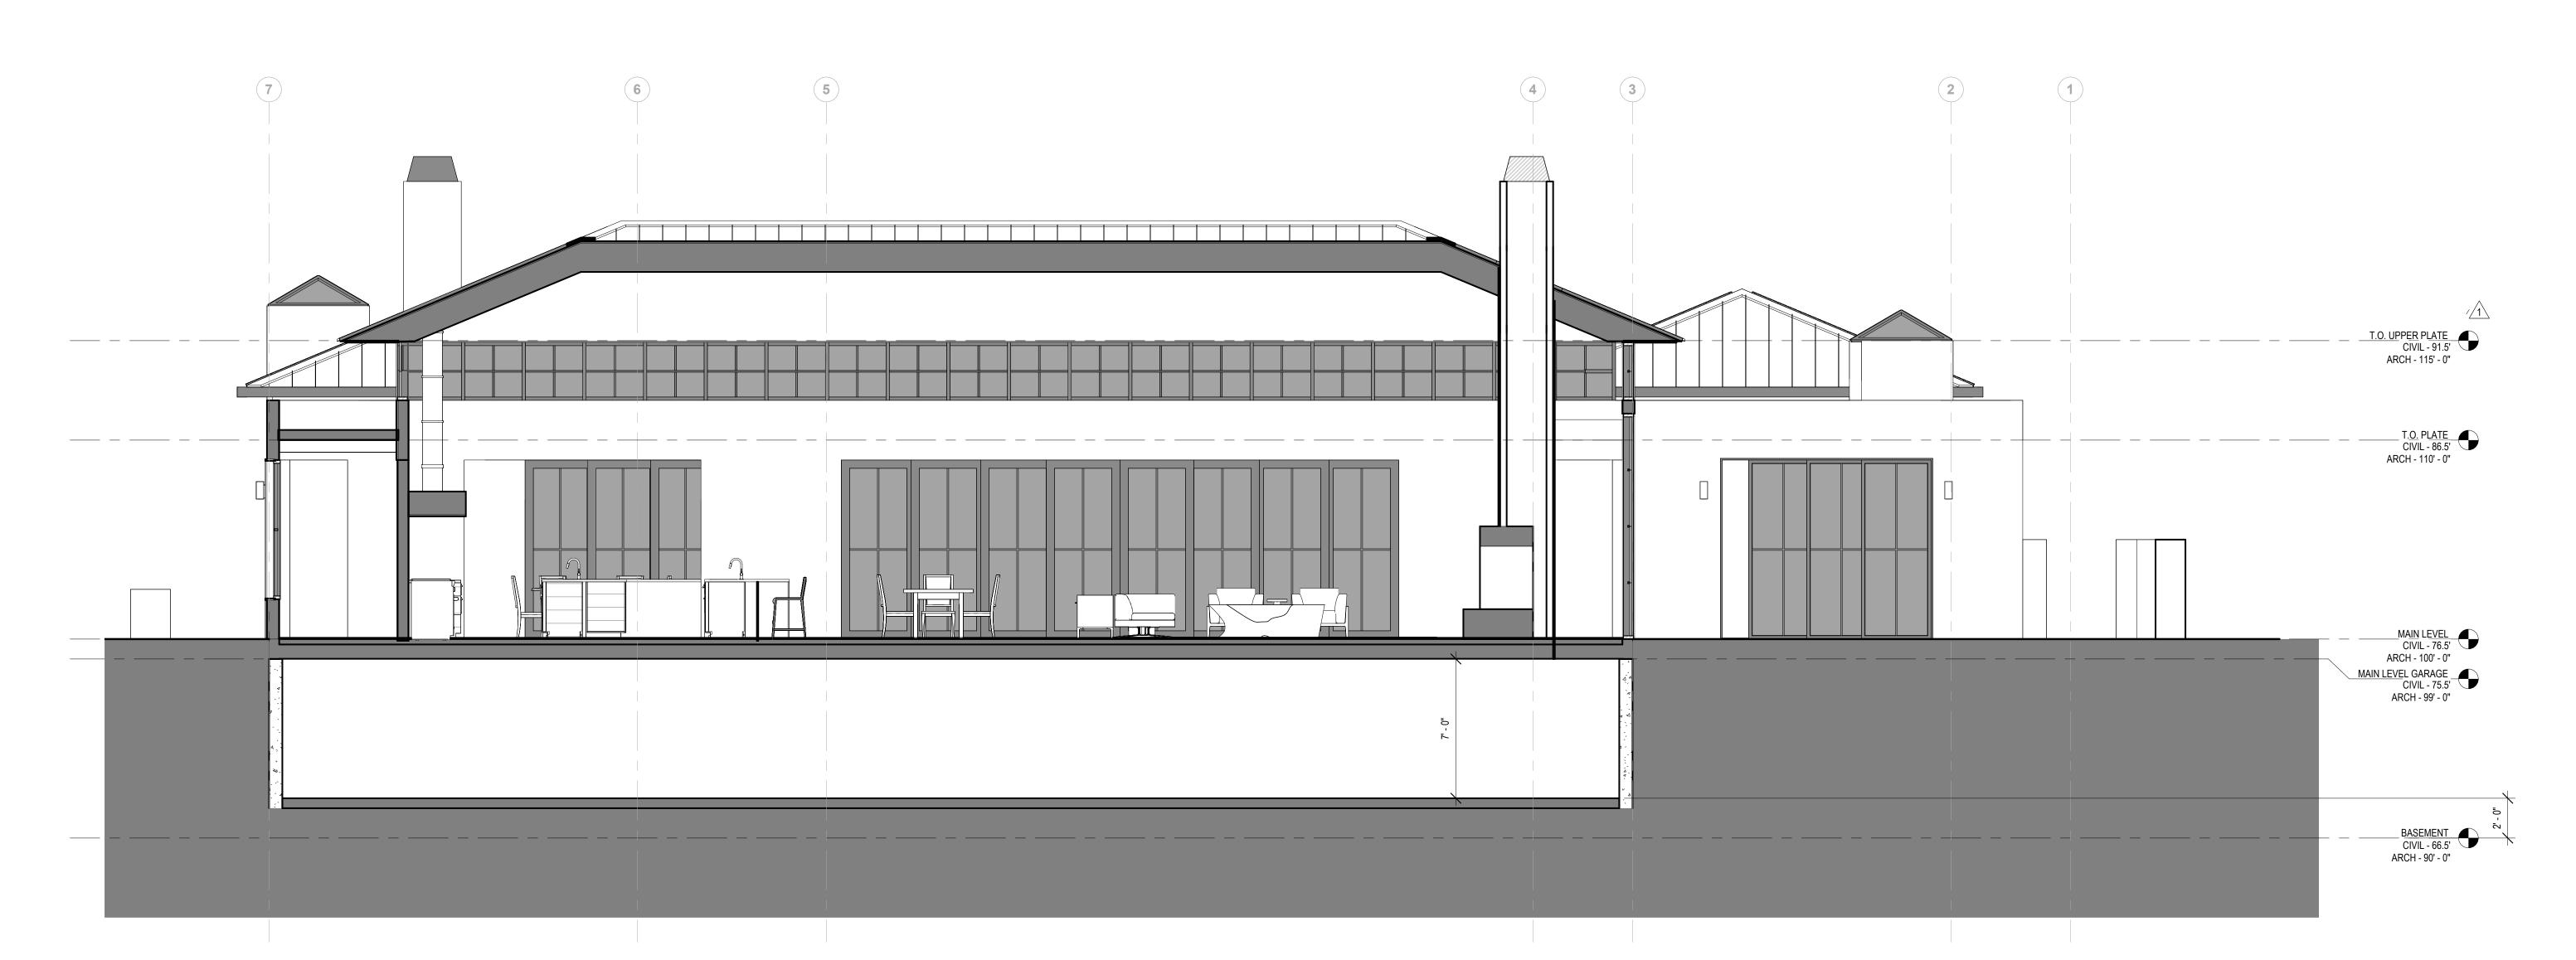


MISTELE-RAFANELLI RESIDENCE
121 PEPPER AVE. BURLINGAME, CA 94010 APN:
COLIN MISTELE AND KATHERINE RAFANELLI


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phase
SCHEMATIC DESIGN
PRICING SET - NOT





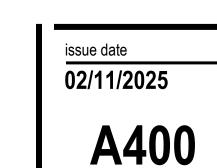

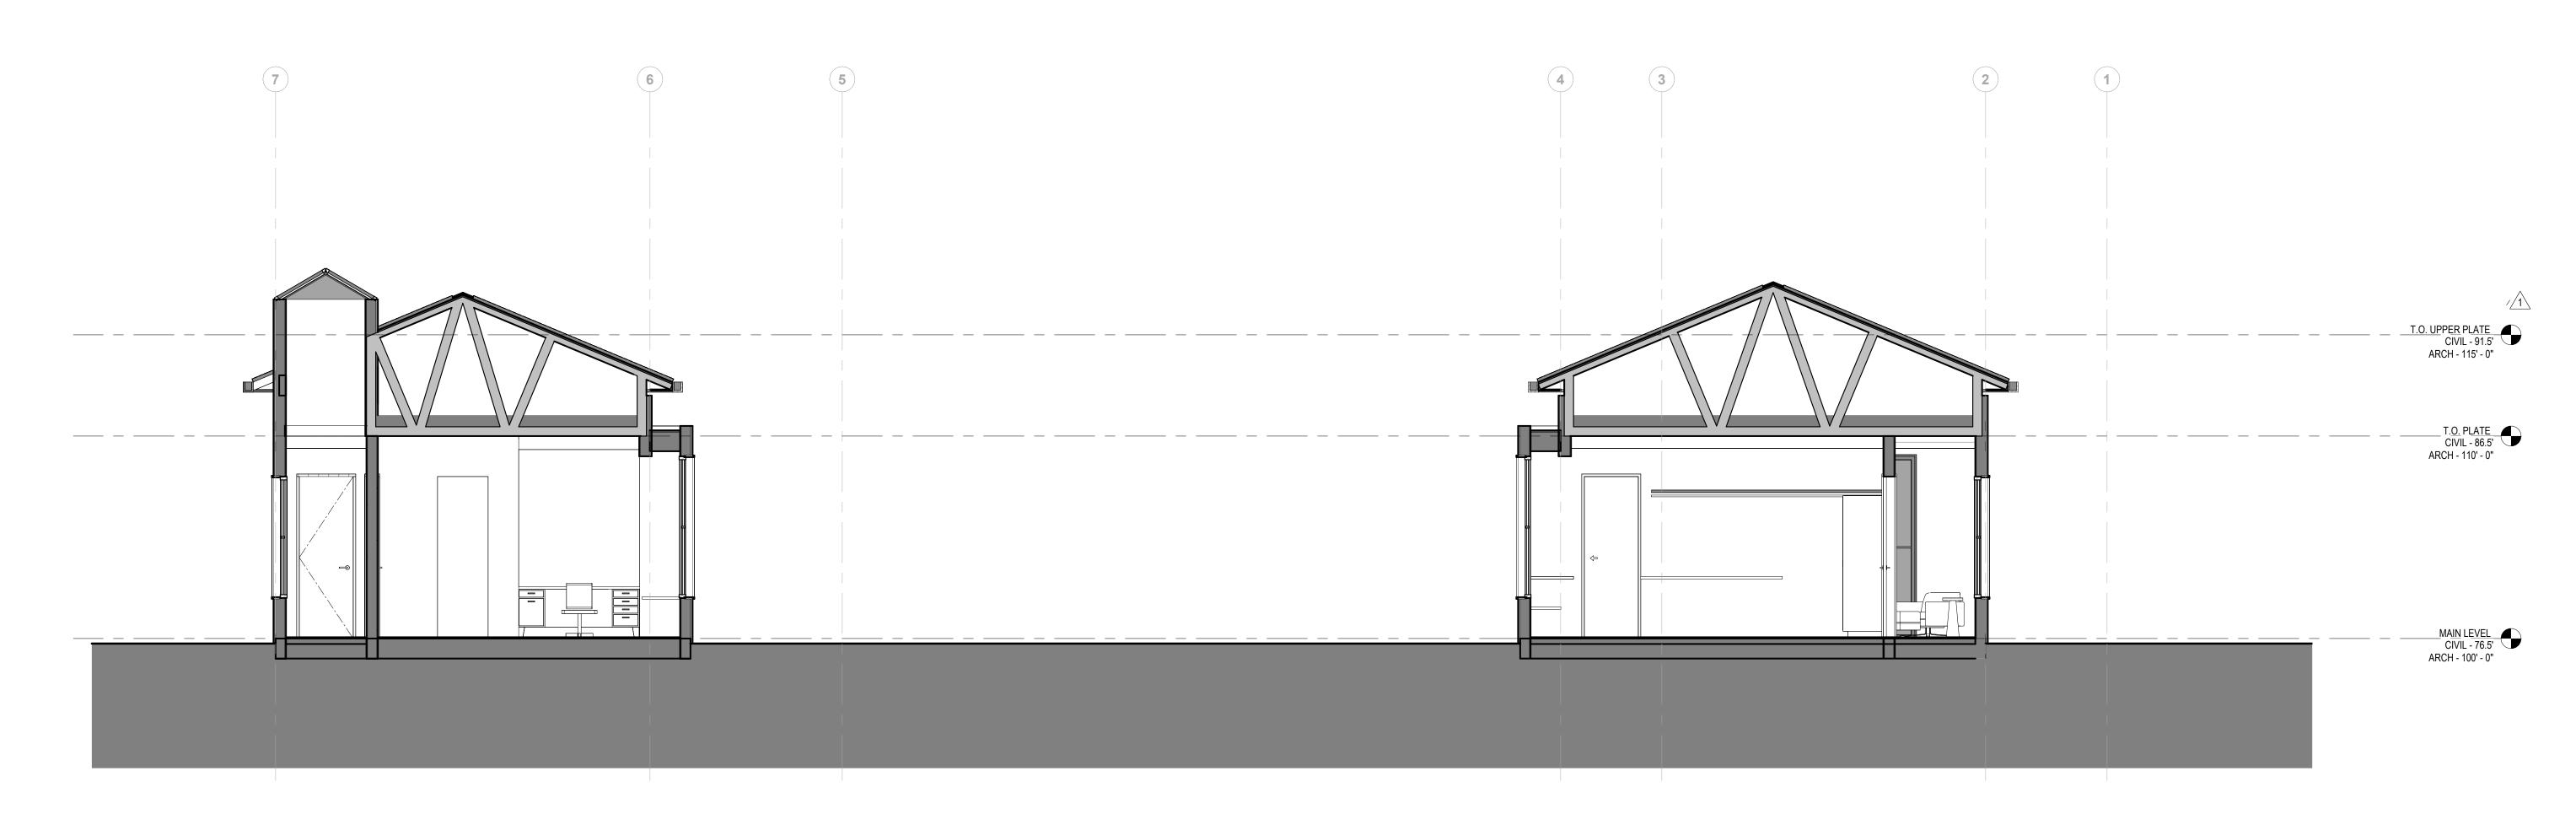

BUILDING SECTION NORTH-SOUTH 3

1/4" = 1'-0"

MISTELE-RAFANELLI RESIDENCE
121 PEPPER AVE. BURLINGAME, CA 94010 APN: 02
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pject # 24045
vision date
04/07/2025

phase
SCHEMATIC DESIGN
PRICING SET - NOT
FOR CONSTRUCTION



### LANDSCAPING GENERAL NOTES

1. CONTRACTOR SHALL VERIFY ON SITE ALL GRADES, PROPERTY LINES, EASEMENTS, SETBACKS, UTILITIES, SITE IMPROVEMENTS WATERPROOFING AND UNDERGROUND UTILITIES BEFORE CONSTRUCTION BEGINS. NO ENCROACHMENT SHALL BE PERMITTED ON ADJACENT LANDS UNLESS WRITTEN PERMISSION IS OBTAINED FROM THE LAND OWNER AND/OR CITY PLANNING & BUILDING DEPARTMENTS. ALL DISCREPANCIES OR PROBLEMATIC SITE CONDITIONS SHALL BE BROUGHT TO THE ATTENTION OF THE

2. FINISHED GRADES SHALL PROVIDE POSITIVE DRAINAGE AWAY FROM STRUCTURES AND SHALL BE PROPERLY INSTALLED TO PREVENT ANY STANDING WATER.

3. JUTE MESH EROSION CONTROL NETTING SHALL BE USED ON ALL 3:1 OR GREATER SLOPES. STAKE NETTING APPROPRIATELY AND PLANT SPECIFIED GROUNDCOVER.

4. CONTRACTOR SHALL OBTAIN ALL PERMITS NECESSARY TO COMPLETE PROPOSED WORK AS PER CITY I TOWN REQUIREMENTS. 5. CONTRACTOR SHALL PROVIDE PROTECTION FOR EXISTING TREES BY INSTALLING TEMPORARY FENCING AT THE DRIPLINE AROUND THE TREES. IN THE EVENT THAT TREE ROOTS OVER 2" ARE DISCOVERED, THE ARCHITECT SHALL BE NOTIFIED. 6. REFER TO ARCHITECTURAL & ENGINEERING DRAWINGS FOR ANY CALCULATIONS, DETAILS, AND SPECIFICATIONS REGARDING

7. THE CONTRACTOR IS RESPONSIBLE FOR COMPLIANCE WITH SOILS REPORT, POOL & HOT TUB PLANS, GRADING, AND DRAINAGE REQUIREMENTS PER CIVIL ENGINEER.

8. ROUGH GRADING AND FINAL GRADING SHALL BE PERFORMED BY THE LANDSCAPE CONTRACTOR.

BUILDING STRUCTURE, FOUNDATIONS, GRADING, SOILS, GAS, & ELECTRICAL.

9. REFER TO ARBORIST REPORT FOR ALL EXISTING AND DEMOLISHED TREES.

ADJACENT PROPERTY TO

REAR SETBACK

### LANDSCAPING PLANTING NOTES

LARGER THAN ONE INCH DIAMETER WILL NOT BE PERMITTED, SOIL AMENDMENTS SHALL HAVE THE FOLLOWING CONTENT: SOIL MIX EQUALING 70% REDWOOD NITRIFIED COMPOST, 30% SANDY LOAM.

2. PLANTING HOLES SHALL BE DOUBLE THE SIZE OF THE CONTAINER (GENERALLY), THE WALLS AND BASES OF PLANT HOLES SHALL BE SCARIFIED. HOLES SHALL BE BACKFILLED WITH A MIXTURE OF IMPORTED SOIL TO EXISTING SOIL AT A RATIO OF 80/20. 3. SOIL BERMS SHALL BE FORMED AROUND ALL PLANTS 1 GALLON SIZE AND LARGER. BASINS SHALL BE MULCHED WITH A 2" LAYER OF BARK CHIPS. CHIPS SHALL BE MINIMUM OF 1-1/2" IN SIZE.

4. ALL PLANTS SHALL BE FERTILIZED. FERTILIZER SHALL BE COMMERCIALLY AVAILABLE TYPE, AGRIFORM (OR EQUIVALENT). APPLICATION SHALL BE ACCORDING TO MANUFACTURERS WRITTEN INSTRUCTIONS.

5. RESIDUAL WEED PRE-EMERGENT SHALL BE APPLIED BY THE CONTRACTOR. THE TYPE AND BRAND CHOSEN BY THE CONTRACTOR SHALL BE APPROVED BY THE ARCHITECT. APPLICATION SHALL BE ACCORDING TO MANUFACTURERS WRITTEN INSTRUCTIONS. 6. TREES SHALL BE STAKED WITH TWO PRESSURE TREATED 2" DIAMETER POLES. TREE TRUNK SHALL BE SECURED WITH TWO RUBBER TIES OR STRAPS FORMING A FIGURE-EIGHT BETWEEN TRUNK AND STAKE.

7. LANDSCAPE CONTRACTOR SHALL VERIFY PLANT AND SOD QUANTITIES PRIOR TO SUBMITTING BID FOR WORK. DOCUMENTATION OF PLANTS INSTALLED AT THE JOBSITE IS REQUIRED, WITH A LETTER PROVIDED TO THE OWNER STATING FINAL QUANTITIES.

- COLORING : INTEGRAL COLOR FROM MANUFACTURERS FULL RANGE AND WILL BE SELECTED BASED UPON MOCK UPS BY

PROPOSED EXT. COURTYARD

> CONCRETE SLAB ON GRADE

CONCRETE

SLAB ON GRADE

### HARDSCAPE NOTES

- BASIS OF DESIGN - MANUFACTURER : BELGARD - SERIES : METROPOLITAN - COLOR : FOUNDRY

THE CONTRACTOR.

CONCRETE -SLAB ON GRADE - SIZE : 24" X 36" X 2-3/8" - INSTALLED IN A RUNNING BOND PATTERN - INSTALL PER MANUFACTURERS WRITTEN INSTALLATION INSTRUCTIONS

2. CONCRETE WALKWAYS OR SLABS - 4" THICK CONCRETE SLAB ON GRADE, POURED IN PLACE. - WELDED WIRE MESH IS NOT ALLOWED, REBAR ONLY. - OVER 6" OF 3/4" MINUS DRAINAGE GRAVEL - OVER NATURAL GRADE OR COMPACTED SUB-GRADE, REFER TO GEO-TECH REPORT

> - MANUFACTURER : GCP APPLIED TECHNOLOGIES - TOP CAST TOP SURFACE RETARDER - #05 : C5 POWDER BLUE VIOLET (SAND BLASTED FINISH APPEARANCE)

3. CONCRETE WALKING PLANKS - 4" THICK CONCRETE PLANKS ON GRADE, POURED IN PLACE.

- WELDED WIRE MESH IS NOT ALLOWED, REBAR ONLY.

- OVER 6" OF 3/4" MINUS DRAINAGE GRAVEL - OVER NATURAL GRADE OR COMPACTED SUB-GRADE, REFER TO GEO-TECH REPORT - COLORING : INTEGRAL COLOR FROM MANUFACTURERS FULL RANGE AND WILL BE SELECTED BASED UPON MOCK UPS BY THE CONTRACTOR.

PROPOSED HOT

PROPOSED

CONCRETE SLAB ON GRADE

— PROTECTED TREE TO BE REMOVED, REFER

TO ARBORIST REPORT

- MANUFACTURER : GCP APPLIED TECHNOLOGIES - TOP CAST TOP SURFACE RETARDER - #05 : C5 POWDER BLUE VIOLET (SAND BLASTED FINISH APPEARANCE)

### PLANTING LEGEND

TREES PROPOSED IN LANDSCAPING PLAN = 27

TREES

**BOTANICAL NAME** COMMON NAME **GROWTH RATE** OLIVE TREE OLEA EUROPAEA MODERATE **NEW TREE** ARBUTUS MENZIESII MADRONE MODERATE MODERATE NEW TREE SLOW TO MODERATE CINNAMOMUM CAMPHORA CAMPHOR MODERATE NEW TREE LAGERSTROEMIA INDICA CREPE MYRTLE LOW MODERATE NEW TREE BETULA PENDULA EUROPEAN WHITE BIRCH EXISTING TREE PICEA PUNGENS 'GLAUCA' COLORADO BLUE SPRUCE EXISTING TREE CEDRUS DEODOR DEODOR CEDAR EXISITNG TREE BETULA PENDULA EUROPEAN WHITE BIRCH EXISTING TREE

- 6'-0" TALL SITE

**PROPOSED 1** 

BEDROOM

6'-0" TALL SITE

WALLS, TYP.

CAR GARAGE

CONCRETE

WALLS, TYP.\_

### NOTES:

11.06.100.b. ONE LANDSCAPE TREE FOR EVERY ONE THOUSAND SQUARE FEET OF HABITABLE SPACE FOR SINGLE FAMILY HOMES. FLOOR AREA OF PROPOSED RESIDENCE = 8,895

NUMBER OF TREES REQUIRED NEW REQUIRED LANDSCAPE TREES. TO BE 24" BOX SIZE OR. LARGER, AND MAY NOT BE FRUIT, NUT, PALMS, ITALIAN CYPRESS OR JAPANESE MAPLE. NEW REQUIRED LANDSCAPE TREES MUST HAVE A MATURE HEIGHT OF OVER 15 FEET AND MATURE WIDTH OVER 10 FEET.

ALL REQUIRED TREES MUST BE IN GOOD CONDITION AT THE FINAL ARBORIST INSPECTION. ALL REQUIRED LANDSCAPE TREES, EXISTING OR NEW, BECOME PROTECTED TREES REGARDLESS OF SIZE AND SHALL BE DISCLOSED UPON SALE OR TRANSFER OF REAL PROPERTY 11.06.100.a.1: REPLACEMENT TREES FOR EACH PROTECTED TREE TO BE REMOVED SHALL BE:

14-19" TRUNK DIAMETER: (1) 24" BOX OR (2) 15 GALLON CONTAINERS 30-45" TRUNK DIAMETER: (1) 36" BOX OR (2) 24" BOXES OR (4) 15 GALLON CONTAINERS PROPOSED REPLACEMENT TREES FOR REMOVED PROTECTED TREES ARE (4) 24" BOX SIZE NEW TREES, REFER TO ARBORIST REPORT FOR FURTHER REQUIREMENTS

<u>SYMBOL</u>	<b>BOTANICAL NAME</b>	<b>COMMON NAME</b>	<b>QUANTITY</b>	WATER USAGE	<b>GROWTH RATE</b>
1	BUXUS MICROPHYLLA	JAPANESE BOX WOOD		MODERATE	MODERATE
2	BUXUS SEMPERVIRENS	EUROPEAN BOX WOOD		MODERATE	MODERATE
3	FABACEAE FRUTESCENS	WISTERIA	4	MODERATE	FAST

EXISTING TREE'S ON

ADJACENT PROPERTY TO

REMAIN, PROTECT

SLAB ON

PROPOSED 4 **BEDROOM HOUSE** PARARA

DWARF FESCUE / DRY BLEND 90/10 - ALL TURF AREAS SHALL BE FERTILIZED AT THE TIME OF INSTALL

ADJACENT RESIDENCE

S 55°00'21" W 206.53'

ADJACENT RESIDENCE

KEYNOTES EXISTING TREE TO REMAIN, LANDSCAPE TREE NEW LANDSCAPE TREE

50' - 0"

R.O.W.

12' - 0" NO TREES, / EXISTING OR PROPOSED \

EXIST IN THE

FIRST 12'

FROM THE

EDGE OF THE

PAVEMENT

- PROTECTED TREE TO BE REMOVED. REFER TO ARBORIST REPORT

SYMBOL INDICATES EXISTING TREE TO REMAIN, REFER TO ARBORIST REPORT

TREE TO REMAIN, REFER TO

SYMBOL INDICATES EXISTING TREE TO REMAIN, REFER TO ARBORIST REPORT

PROTECTED TREE TO BE REMOVED.

REFER TO ARBORIST REPORT

ARBORIST REPORT

---- 3'-0" TALL SITE

WALLS, TYP.

F-(E) 1

55' - 0"

AVERAGE NEIGHBORHOOD SETBACK

- 3'-0" TALL SITE

WALLS, TYP.

ADU

CONCRETE SLAB ON GRADE



RESIDENCE



